INDEX OF DRAWINGS


- 1 16 COVER SHEET
- 2 16 EXISTING FLOOR PLAN
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MISSOURI DEPARTMENT OF TRANSPORTATION

OSCEOLA MAINTENANCE BUILDING ADDITION SOUTHWEST DISTRICT OSCEOLA, MISSOURI 64776 5371 NE BUSINESS HY 82 OSCEOLA MO,

CODE REQUIREMENTS

BUILDING CODE - CURRENT IBC PLUMBING CODE - CURRENT IBC MECHANICAL CODE - CURRENT IBC ELECTRICAL CODE - CURRENT N.E.C.

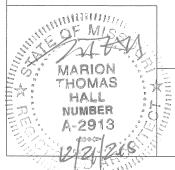


MISSOURI DEPARTMENT OF TRANSPORTATION

> DIVISION OF GENERAL SERVICES FACILITIES MANAGEMENT

OSCEOLA MAINTENANCE BUILDING ADDITIONL 5371 NE BUS HWY 82 OSCEOLA, MO 64776

DESIGN BY: TOM HALL DRAWN BY: TOM HALL


DATE: 12/21/2015

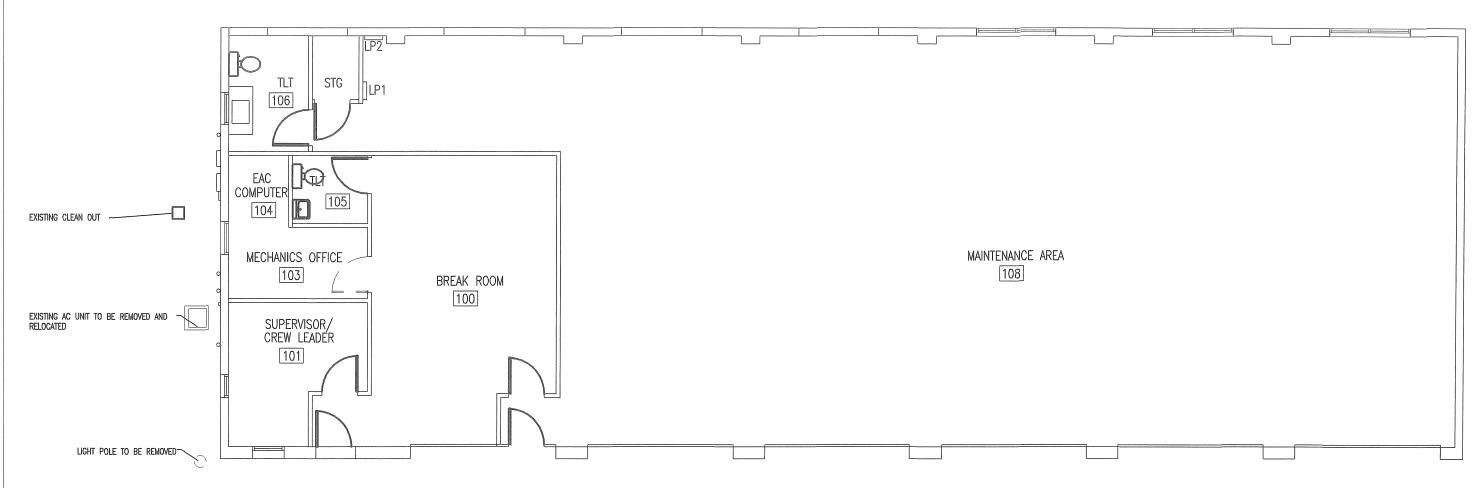

A EXISTING FLOOR PLAN

2 SCALE: 1/8" = 1'-0"



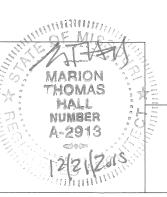


EXISTING PLAN


MISSOURI DEPARTMENT OF TRANSPORTATION

DIVISION OF GENERAL SERVICES FACILITIES MANAGEMENT

OSCEOLA MAINTENANCE BUILDING ADDITION 5371 NE BUS HWY 82 OSCEOLA MO, 64776 DESIGN BY: TOM HALL
DRAWN BY: TOM HALL

DATE: 12/21/2015

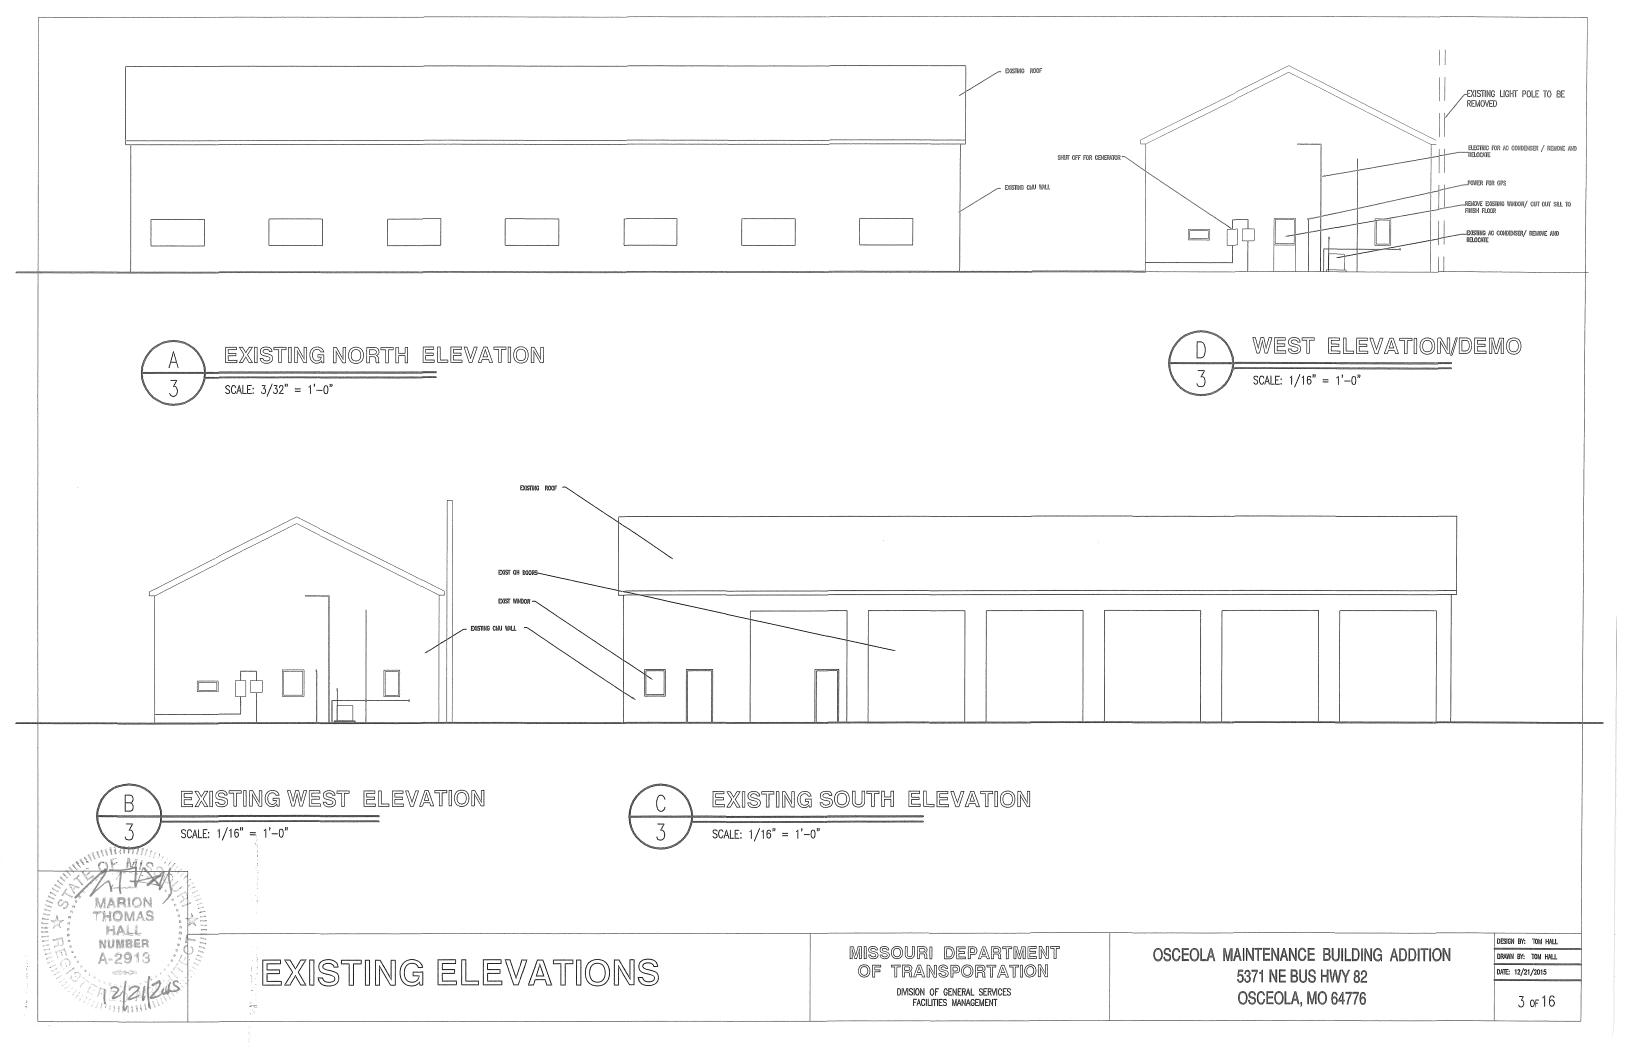

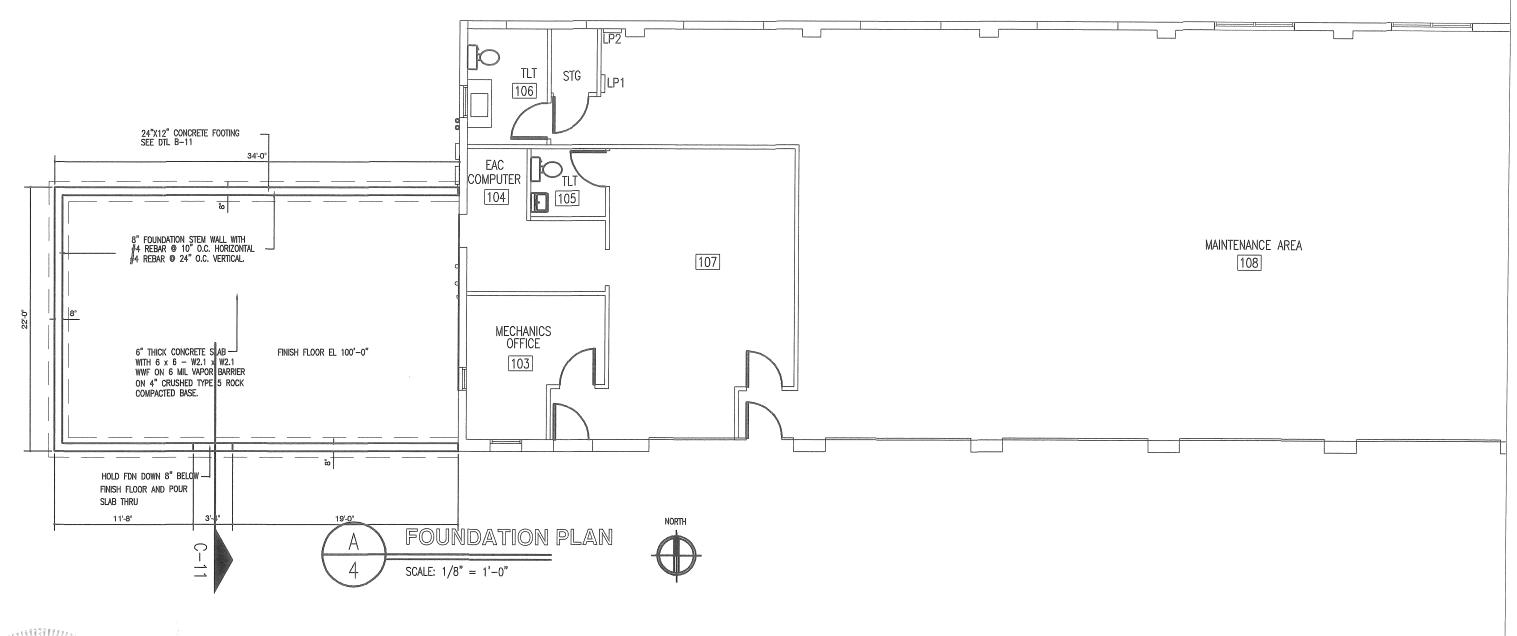

MARION THOMAS HALL NUMBER A-2913


FOUNDATION PLAN


MISSOURI DEPARTMENT
OF TRANSPORTATION

DIVISION OF GENERAL SERVICES FACILITIES MANAGEMENT

OSCEOLA MAINTENANCE BUILDING ADDITION 5371 NE BUS HWY 82 OSCEOLA, MO 64776 DESIGN BY: TOM HALL

DRAWN BY: TOM HALL
DATE: 12/21/2015

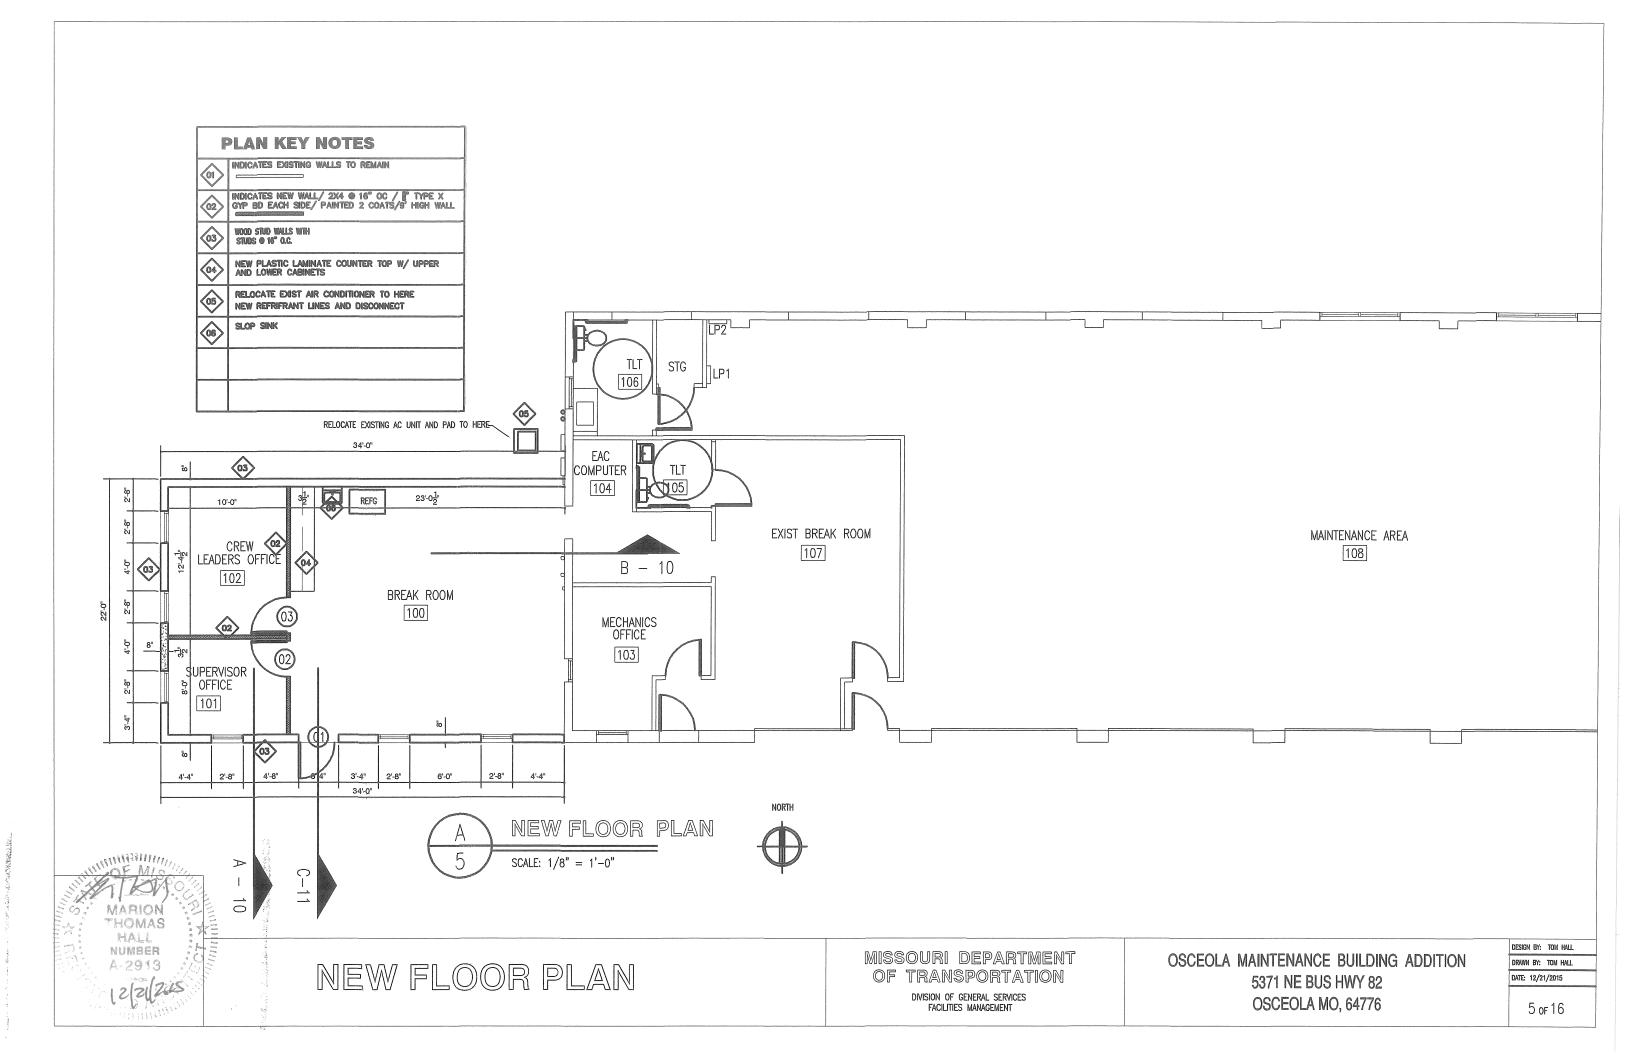

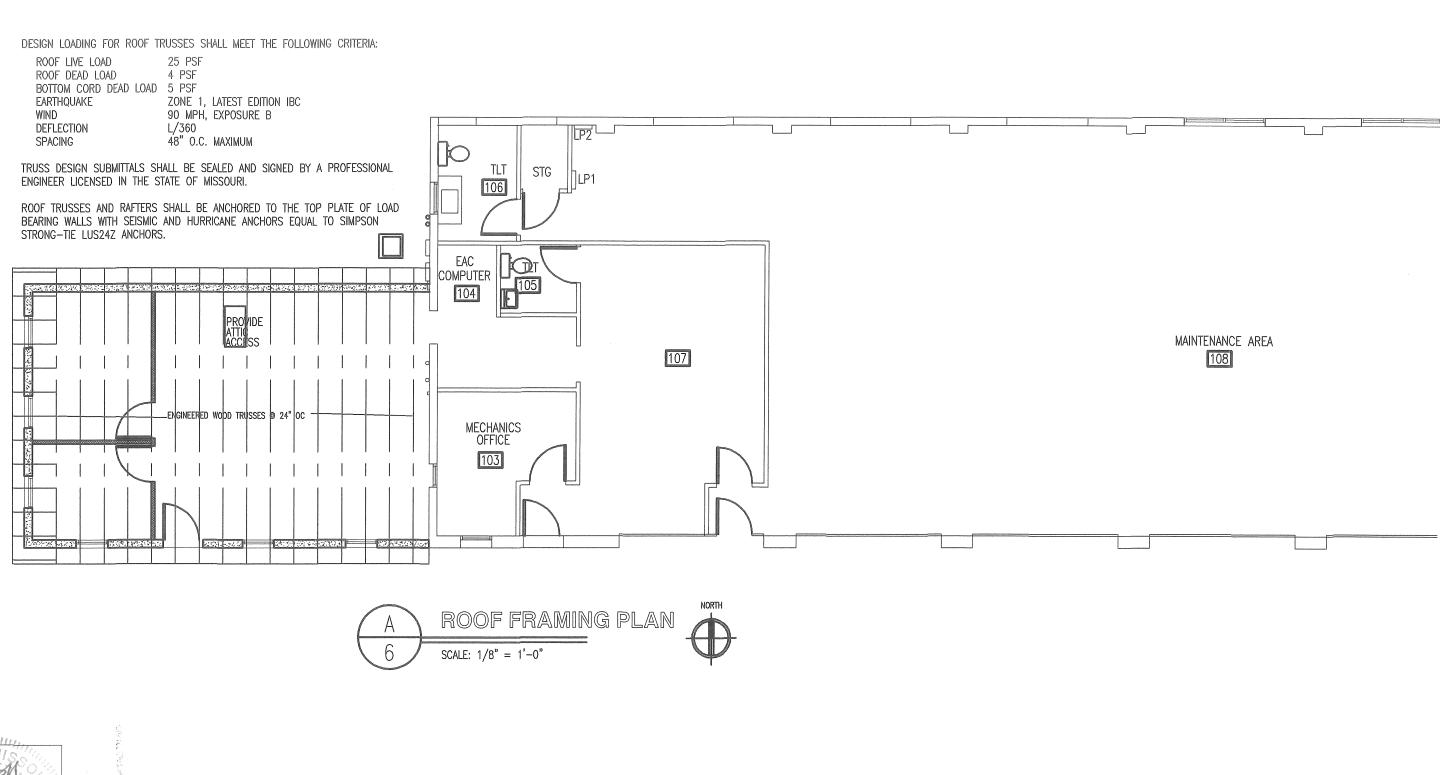


MARION THOMAS HALL NUMBER A-2913

ROOF FRAMING PLAN

MISSOURI DEPARTMENT OF TRANSPORTATION

DIVISION OF GENERAL SERVICES FACILITIES MANAGEMENT

OSCEOLA MAINTENANCE BUILDING ADDITION 5371 NE BUS HWY 82 OSCEOLA, MO 64776 DESIGN BY: TOM HALL
DRAWN BY: TOM HALL
DATE: 12/21/2015

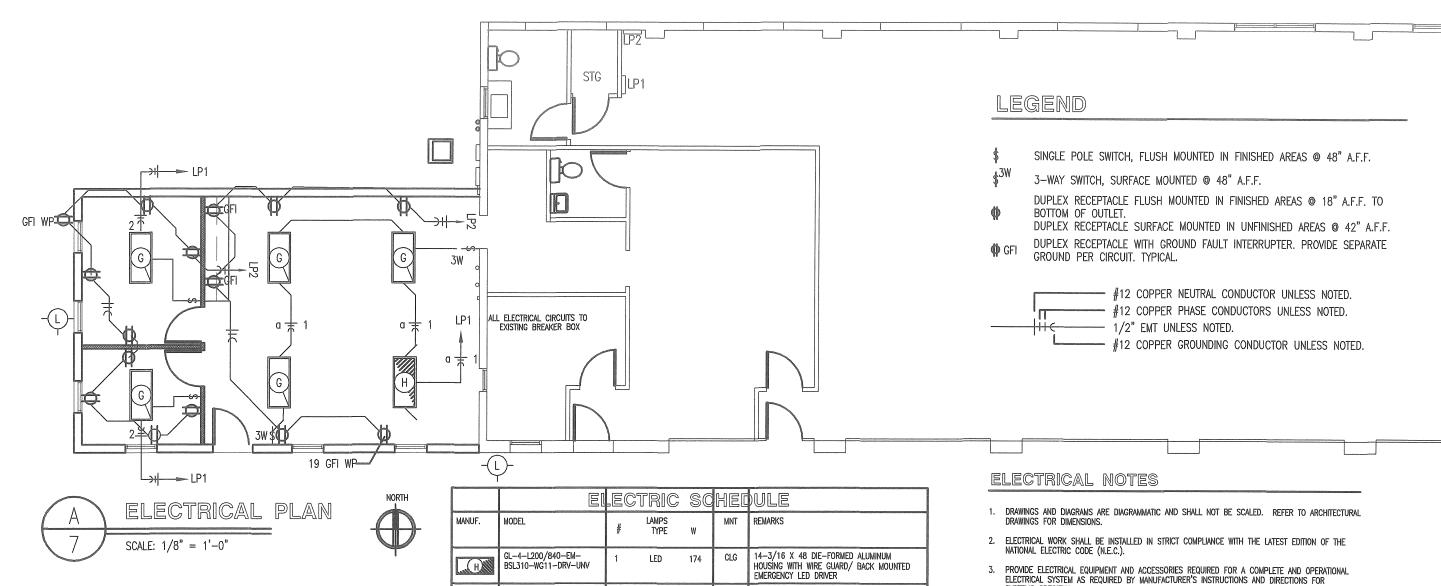

ELECTRICAL FIXTURES AND EQUIPMENT ARE SCHEDULED BY MANUFACTURER AND MODEL NUMBER FOR DESIGNINTENT ONLY. APPROVED EQUALS MAY BE SUBSTITUTED

LED

LED

43

174

WALL

WLM43LED

GL-4-L200/840-EM-

BSL310-WG11-DRV-UNV

ATLAS

()-WILLIAMS

(G)

- 4. SWITCHES AND RECEPTACLES SHALL BE EQUAL TO THE AMPERE RATING SHOWN IN THE PANEL SCHEDULE. RECEPTACLES SHALL BE GROUND-FAULT INTERRUPTION TYPE WHERE SHOWN OR AS
- 5 SEE HVAC SCHEDULE FOR EQUIPMENT TO BE HARD WIRED, PROVIDE SERVICE DISCONNECT AT EACH.
- 6 COORDINATE WORK WITH OTHER TRADES PRIOR TO COMMENCING WITH ELECTRICAL WORK.
- CONDUCTOR AND BREAKER SIZE MAY VARY PER MANUFACTURER ON THE EQUIPMENT SPECIFIED. ELECTRIC CONTRACTOR TO VERIFY SIZES WITH EXACT EQUIPMENT ORDERED PRIOR TO PURCHASING
- FIXTURE LOCATIONS ARE APPROXIMATE, EXACT LOCATIONS TO BE DETERMINED AFTER COLLABORATION WITH THE OWNER AND OTHER TRADES.
- 9 CONTRACTOR SHALL PROVIDE SERVICE DISCONNECTS AS REQUIRED AT EXTERIOR OF BUILDING.

10 PROVIDE BLOCKING FOR ELECTRICAL DEVICES AS REQUIRED FOR A SECURE APPLICATION.

OSCEOLA MAINTENANCE BUILDING ADDITION 5371 NE BUS HWY 82 OSCEOLA, MO 64776

OF MIS

MARION

THOMAS

MALL

NUMBER

A-2913

2/21/25

ELECTRICAL PLAN

MISSOURI DEPARTMENT OF TRANSPORTATION

EXTERIOR, SURFACE MOUNT LIGHT FIXTURE.

14-3/16 X 48 DIE-FORMED ALUMINUM


HOUSING WITH WIRE GUARD/


WITH ALUMINUM HOUSING. GLARE FREE LENS.

DIVISION OF GENERAL SERVICES FACILITIES MANAGEMENT

DESIGN BY: TOM HALL DRAWN BY: TOM HALL DATE: 12/21/2015

7 OF16

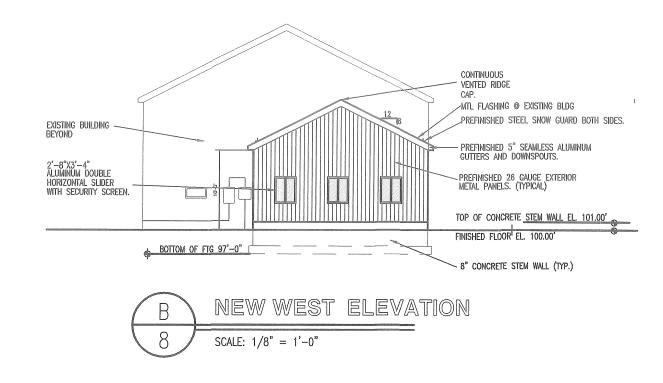

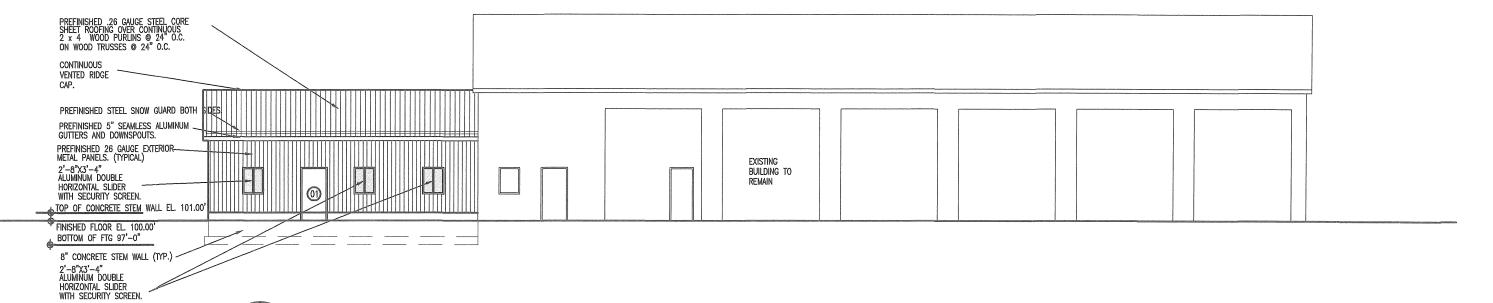

A

NEW SOUTH ELEVATION

SCALE: 1/8" = 1'-0"

MARION THOMAS HALL NUMBER A-2913

NEW ELEVATIONS


MISSOURI DEPARTMENT OF TRANSPORTATION

DIVISION OF GENERAL SERVICES FACILITIES MANAGEMENT

OSCEOLA MAINTENANCE BUILDING ADDITION
5371 NE BUS HWY 82
OSCEOLA, MO 64776

DESIGN BY: TOM HALL
DRAWN BY: TOM HALL

DATE: 12/21/2015

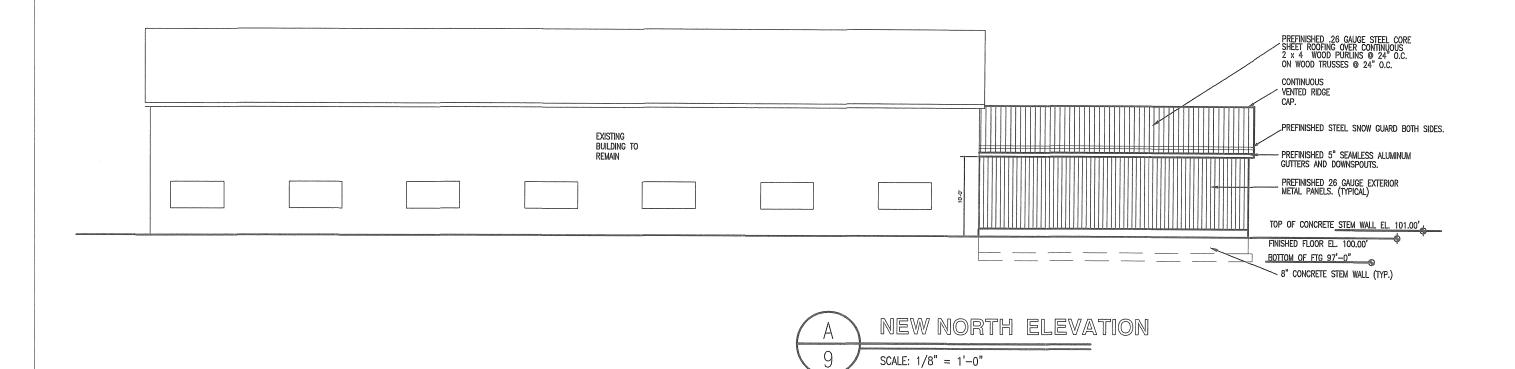

5024 NUMBER A-2913

NEW ELEVATIONS

MISSOURI DEPARTMENT OF TRANSPORTATION


SCALE: 1/8" = 1'-0"


DIVISION OF GENERAL SERVICES FACILITIES MANAGEMENT


OSCEOLA MAINTENANCE BUILDING ADDITION 5371 NE BUS HWY 82 OSCEOLA, MO 64476

DESIGN BY: TOM HALL

DRAWN BY: TOM HALL DATE: 12/21/2015

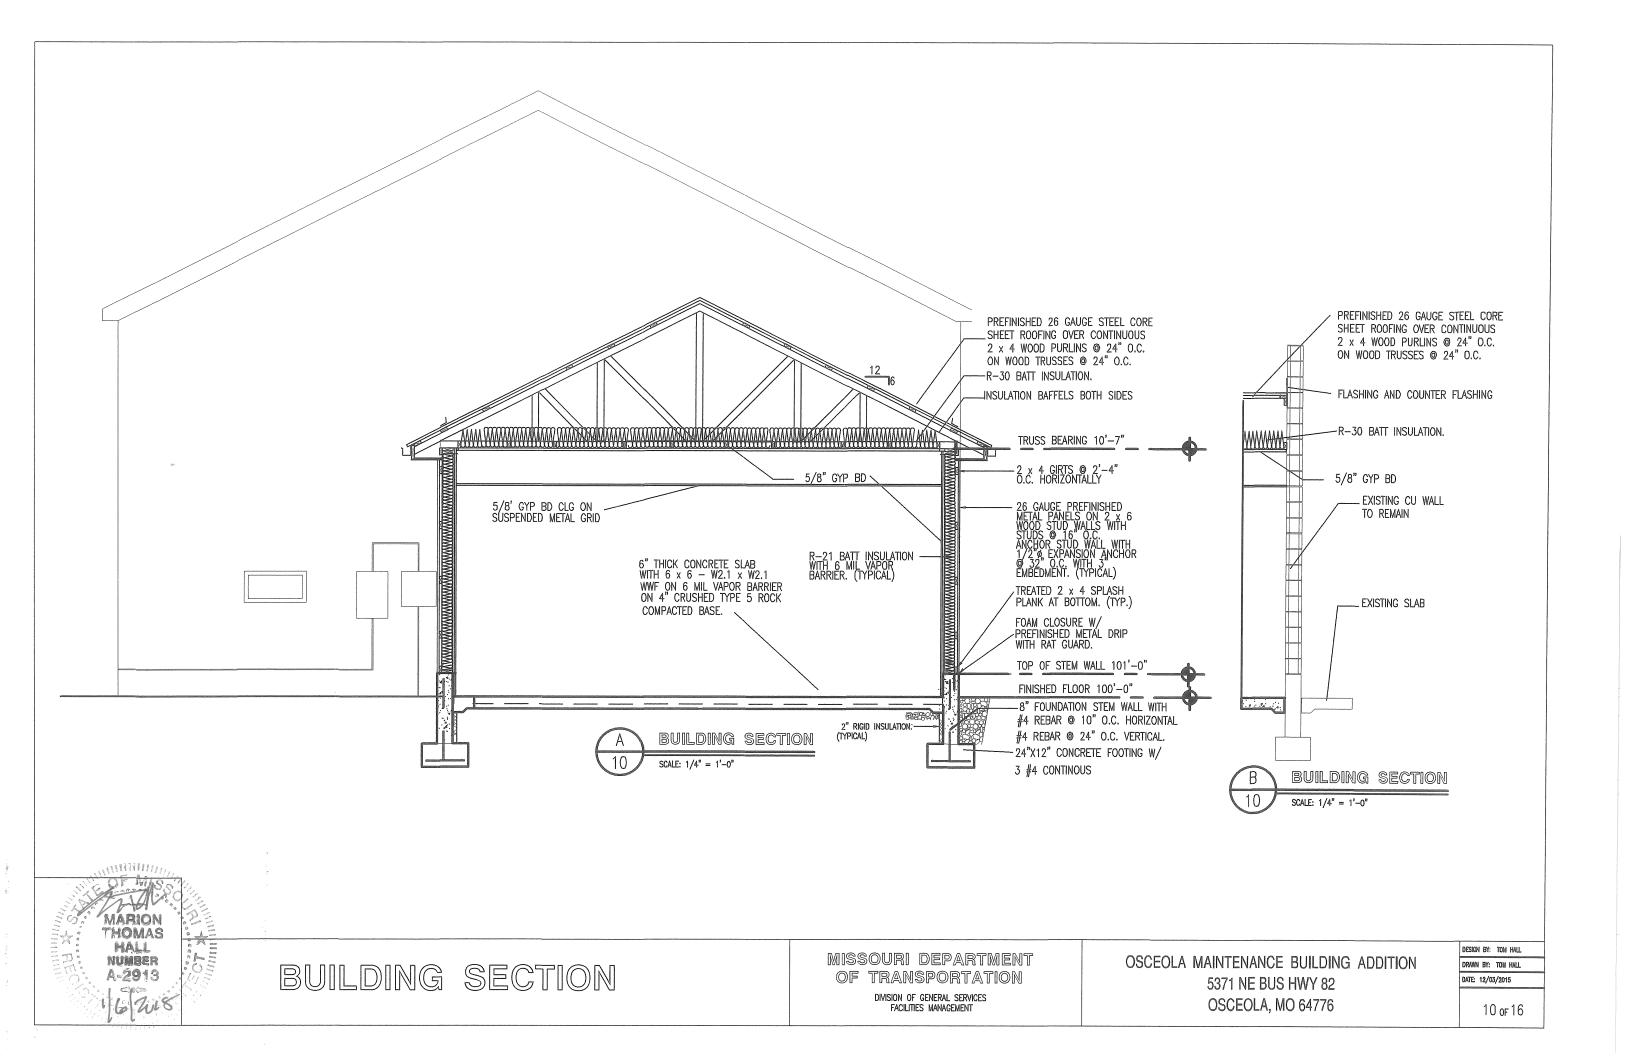


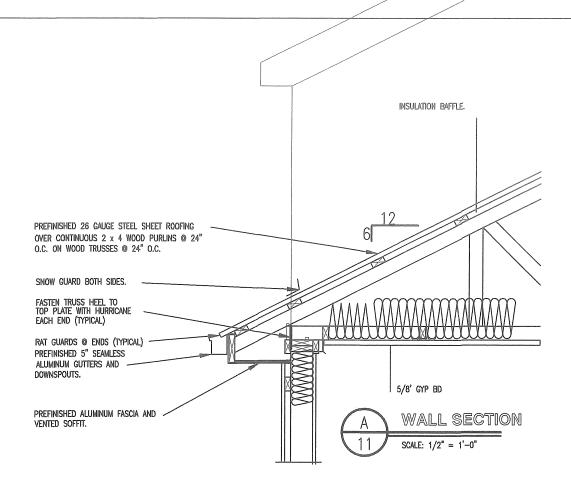

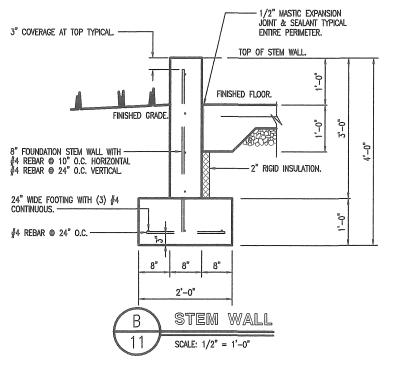

CONCRETE NOTES

- CONCRETE WORK SHALL BE EXECUTED IN STRICT COMPLIANCE WITH THE LATEST EDITION OF THE AMERICAN CONCRETE INSTITUTE (A.C.I.) MANUAL OF CONCRETE PRACTICE.
- FOUNDATION DESIGN IS BASED UPON AN ASSUMED SOIL BEARING CAPACITY OF 2,000 PSF. IF WET OR UNUSUAL SOIL CONDITIONS ARE ENCOUNTERED, NOTIFY THE DESIGNER AND CONSTRUCTION INSPECTOR BEFORE PROCEEDING WITH THE WORK.
- IF CONDITIONS REQUIRING ROCK EXCAVATION ARE ENCOUNTERED, NOTIFY THE DESIGNER AND CONSTRUCTION INSPECTOR BEFORE PROCEEDING WITH THE WORK.
- ALL CONCRETE SHALL BE TYPE 1 CEMENT WITH A COMPRESSIVE STRENGTH OF 4,000 PSI @ 28 DAYS AND NOT TO EXCEED 4" SLUMP.
- FOUNDATION PIERS AND FOOTINGS SHALL BEAR A MINIMUM OF 12 INCHES INTO UNDISTURBED SOIL AND 36 INCHES MINIMUM BELOW FINISH GRADE.
- DEFORMED STEEL REINFORCING BARS SHALL BE: #4 AND LARGER ASTM A615 GRADE 60.
- SEE SPECIFICATION SECTION 03300 CONCRETE FOR ADDITIONAL INFORMATION.
- CONCRETE EXPOSED TO THE EXTERIOR SHALL RECEIVE AIR ENTRAINMENT 6% +/- 2%.
- PROVIDE CORNER REINFORCING BARS WITH 12" MINIMUM LAP EQUAL IN SIZE AND GRADE TO
- 10. EXTERIOR CONCRETE FLATWORK SHALL HAVE A LIGHT BROOM FINISH.
- COORDINATE WORK OF OTHER TRADES REQUIRED TO BE INSTALLED IN, UNDER, OR THROUGH CONCRETE PRIOR TO PLACEMENT OF CONCRETE. INSTALL ALL ANCHORAGES AND SLEEVES REQUIRED FOR THE INSTALLATION OF WORK BY OTHER TRADES.
- 12. ENTIRE PERIMETER OF BUILDING TO RECEIVE 2" POLYISOCYANURATE RIGID INSULATION BOARD.
- SAWED CONTROL JOINTS SHALL BE CLEANED FREE OF ALL DEBRIS AND FILLED WITH SEALANT. SEE SECTION 07900.
- ALL EXPOSED INTERIOR CONCRETE FLOORS SHALL RECEIVE A CURING/SEALING FINISH PER SPECIFICATION SECTION 03346.
- 15. COPPER PIPING RUN THROUGH CONCRETE WORK SHALL BE RUN THROUGH PVC SLEEVES.

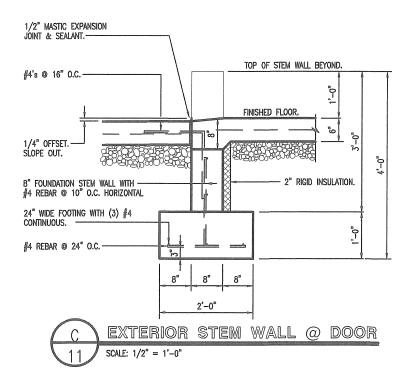

THE MANUAL MARION THOMAS HALL NUMBER A-2913

WALL SECTIONS


MISSOURI DEPARTMENT OF TRANSPORTATION


> DIVISION OF GENERAL SERVICES FACILITIES MANAGEMENT


OSCEOLA MAINTENANCE BUILDING ADDITION 5371 NE BUS HWY 82 OSCEOLA, MO 64776


DESIGN BY: TOM HALL DRAWN BY: TOM HALL


DATE: 12/03/2015

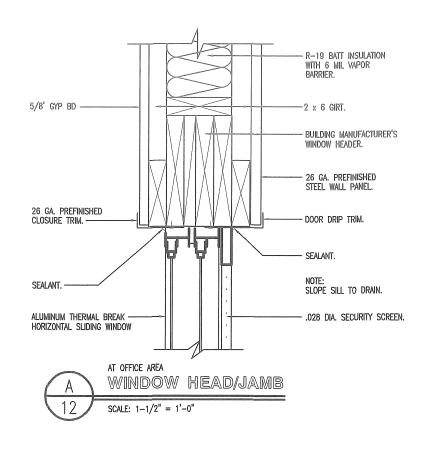

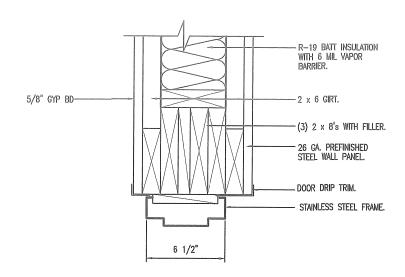

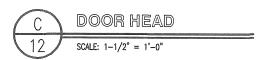

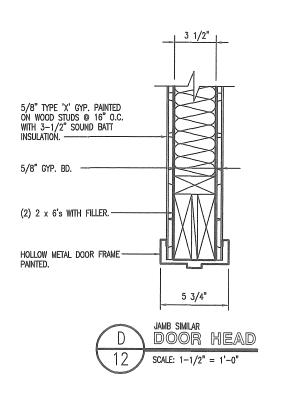

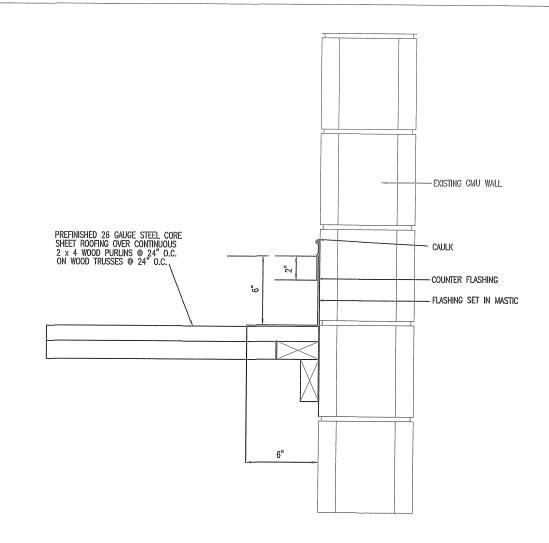

E FLASHING DTL

12 SCALE: 1-1/2" = 1'-0"

MARION THOMAS HALL NUMBER A 2913

DETAILS


MISSOURI DEPARTMENT OF TRANSPORTATION

DIVISION OF GENERAL SERVICES FACILITIES MANAGEMENT OSCEOLA MAINTENANCE BUILDING ADDITION 5371 NE BUS HWY 82 OSCEOLA, MO 64776 DESIGN BY: TOM HALL
DRAWN BY: TOM HALL

DATE: 12/21/2015

ROOM NO	50514 114145	WALLS				FLOOR	BASE	CEILING	CLG HT	REMARKS
	ROOM NAME	NORTH	SOUTH	EAST	WEST	TEOOR				
100	NEW BREAK ROOM	GYP BD/ PAINTED	PAINTED	EXIST CMU PAINTED	GYP BD/ PAINTED	CONCRETE W/ SEALER	4' VINYL	2X4X5/8 ACOUS TI	E	
101	SUPERVISORS OFFICE	GYP BD/ PAINTED	GYP BD/ PAINTED	GYP BD/ PAINTED	CMU PAINTED	CONCRETE W/ SEALER	4' VINYL	2X4X5/8 ACOUS TI	LE	
102	CREW LEADERS OFF	GYP BD/ PAINTED	GYP BD/ PAINTED	GYP BD/ PAINTED	GYP BD/ PAINTED	CONCRETE W/ SEALER	4' VINYL	2X4X5/8 ACOUS TI	LE	
103	EXISTING MECHANICS OFF	EXIST	EXIST	EXIST	EXIST	EXIST	EXIST	EXIST		
104	EAC COMPUTER	EXIST	EXIST	EXIST	EXIST	EXIST	EXIS	F EXIST		
105	EXIST TLT	EXIST	EXIST	EXIST	EXIST	EXIST	EXIST	EXIST		
106	EXIST TLT	EXIST	EXIST	EXIST	EXIST	EXIST	EXIST	EXIST		
106	EXIST TLT	EXIST	EXIST	EXIST	EXIST	EXIST	EXIST	EXIST		

	DOC	DR S	CHE	DULE							
	DOORS										
NO	OPG	TYPE	SIZE	HEIGHT	THK	HARDWARE REMARKS	TYPE	FR	NOTES	NO	
01	3'-4"X 7'=2"	А	3'-0"	7'-0"		1 1/2 PAIR BUTTS/LOCLSET, ADA APPROVED LEVER HANDLE/ CLOSER/ THRESHOLD/WEATHER STRIP		н.м.	INSULATED DOOR AND FRAME/ PAINTED/ 2 COATS		
02	3'-4"X 7'=2"	А	3'-0"	7'-0"		1 1/2 PAIR BUTTS/PRIVACY LOCKT, ADA APPROVED LEVER HANDLE		H.M.	DOOR AND FRAME PAINTED/ 2 COATS		
03	3'-4"X 7'=2"	А	3'-0"	7'-0"		1 1/2 PAIR BUTTS/PRIVACY LOCKT, ADA APPROVED LEVER HANDLE		H.M.	DOOR AND FRAME PAINTED/ 2 COATS		

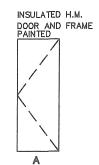


MARION THOMAS HALL NUMBER A 2913

SCHEDULES

MISSOURI DEPARTMENT OF TRANSPORTATION

DIVISION OF GENERAL SERVICES FACILITIES MANAGEMENT OSCE0LA MAINTENANCE BUILDING ADDITION 5371 NE BUS HWY 82 OSCEOLA, MO 64776 DESIGN BY: TOM HALL
DRAWN BY: TOM HALL
DATE: 12/21/2015

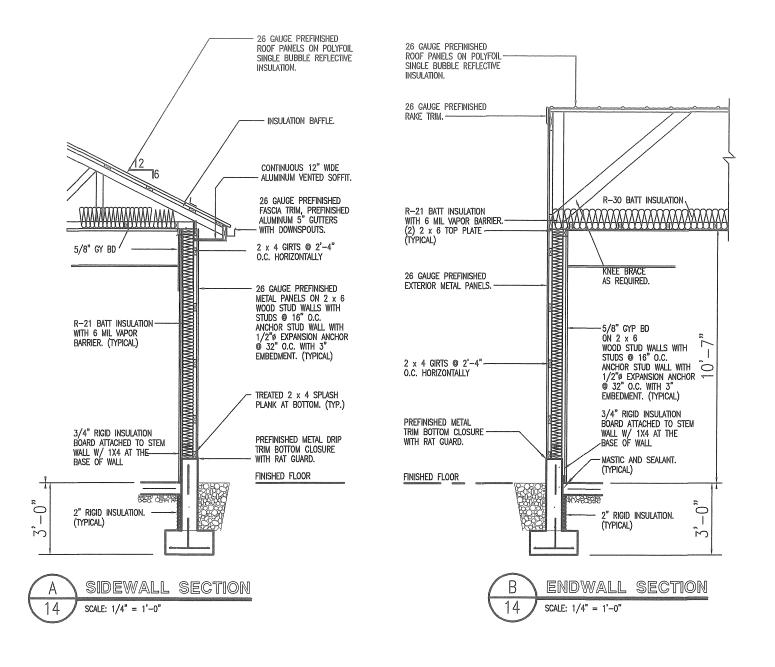





MISSOURI DEPARTMENT OF TRANSPORTATION

DIVISION OF GENERAL SERVICES FACILITIES MANAGEMENT

OSCEOLA MAINTENANCE BUILDING ADDITION 5371 NE BUS HWY 82 OSCEOLA, MO 64776 DESIGN BY: TOM HALL
DRAWN BY: TOM HALL

DATE: 12/21/2015

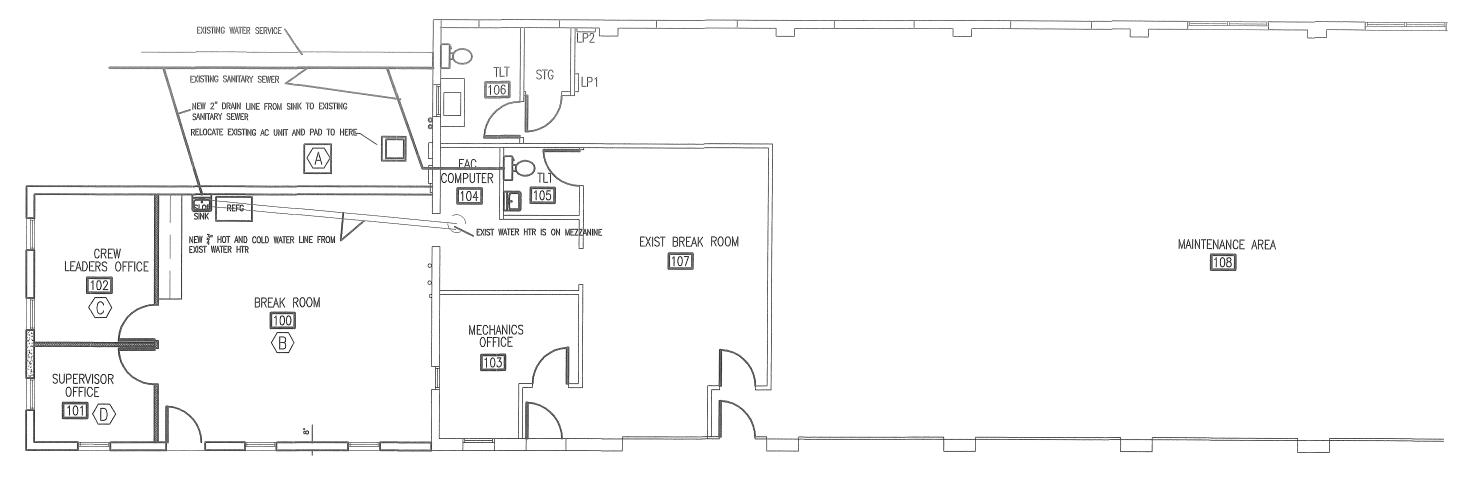

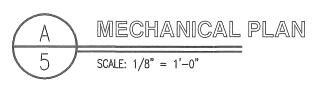

MECHANICAL NOTES

- 1. DRAWINGS AND DIAGRAMS ARE DIAGRAMMATIC AND SHALL NOT BE SCALED. REFER TO ARCHITECTURAL DRAWINGS FOR DIMENSIONS.
- 2. MECHANICAL WORK SHALL BE INSTALLED IN STRICT COMPLIANCE WITH THE LATEST EDITION OF THE IBC MECHANICAL CODE.
- PROVIDE EQUIPMENT AND APPURTENANCES NOT NECESSARILY SHOWN OR SPECIFIED BUT NEEDED FOR COMPLETE AND PROPER INSTALLATION.
- ALL EQUIPMENT AND MATERIALS, IN PARTICULAR VALVES, FILTERS, MOTORS, AND CONTROLS SHALL BE ARRANGED TO PROVIDE PROPER CLEARANCE FOR SERVICE, MAINTENANCE AND INSPECTION.
- MECHANICAL SUBCONTRACTOR SHALL FULLY COORDINATE ALL WORK WITH PLUMBING AND ELECTRICAL WORKERS PRIOR TO COMMENCING OF THE MECHANICAL INSTALLATION.
- 6. PROVIDE BLOCKING TO HVAC DEVICES AS REQUIRED FOR A SECURE APPLICATION.

MARION HALL NUMBER A 2913

HVAC PLAN

MISSOURI DEPARTMENT OF TRANSPORTATION

DIVISION OF GENERAL SERVICES FACILITIES MANAGEMENT OSCEOLA MAINTENANCE BUILDING ADDITION 5371 NE BUS HWY 82 OSCEOLA, MO 64776 DESIGN BY: TOM HALL
DRAWN BY: TOM HALL

DATE: 12/21/2015

HVAC SCHEDULE										
SYM.	UNIT	MANUFACTURER	BTU OUTPUT	FUEL	VOLTAGE	REMARKS				
$\langle A \rangle$	38MGQF36—3COND UNIT 53DA—900CONDESATE P (4)MS141225 25'INSULATED LINE SE	JMP CANNEN		ELECTRIC	115					
$\langle B \rangle$	BREAK ROOM (2)MBQB12C-3 1 TON CEILING CASSET (2)40MBQB01C CASSETT IGRILL	CARRIER			115					
$\langle C \rangle$	LEAD OFFICE (1)40MBQB09C-3 3/4 TON CLG CASSETT (1)40MBQB01CCASSETT	CARRIER GRILL			115					
$\langle D \rangle$	SUPERVISOR OFFICE (1)40MBQB09C-3 3(3/4 TON CLG CASSETT (1) 40MBQB01C (CASSE	CARRIER TT GRILL			115					
$\langle E \rangle$										



HVAC SCHEDULE

MISSOURI DEPARTMENT OF TRANSPORTATION

DIVISION OF GENERAL SERVICES FACILITIES MANAGEMENT OSCEOLA MAINTENANCE BUILDING ADDITION 5371 NE BUS HWY 82 OSCEOLA, MO 64776 DESIGN BY: TOM HALL

DRAWN BY: TOM HALL
DATE: 12/21/2015