INDEX OF DRAWINGS

- 1-6 COVER SHEET
- 2-6 SITE PLAN
- 3 6 NORTH & WEST ELEVATIONS
- 4 6 SOUTH & EAST ELEVATIONS
- 5-6 DETAILS
- 6 6 ROOF SECTION

MISSOURI DEPARTMENT OF TRANSPORTATION

HAMPTON PROJECT OFFICE REROOF


CODE REQUIREMENTS

BUILDING CODE - CURRENT IBC

PLUMBING CODE - CURRENT IBC

ST. LOUIS COUNTY

ST. LOUIS DISTRICT — ST. LOUIS, MO 6138 Wilson Avenue

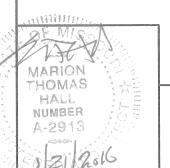

COVER SHEET


MISSOURI DEPARTMENT
OF TRANSPORTATION
DIVISION OF GENERAL SERVICES


FACILITIES MANAGEMENT

Hampton Project Office Reroof St. Louis District — St. Louis County 6138 Wilson Avenue, St. Louis, MO DATE: 1-15-16

Sheet

1 of 6

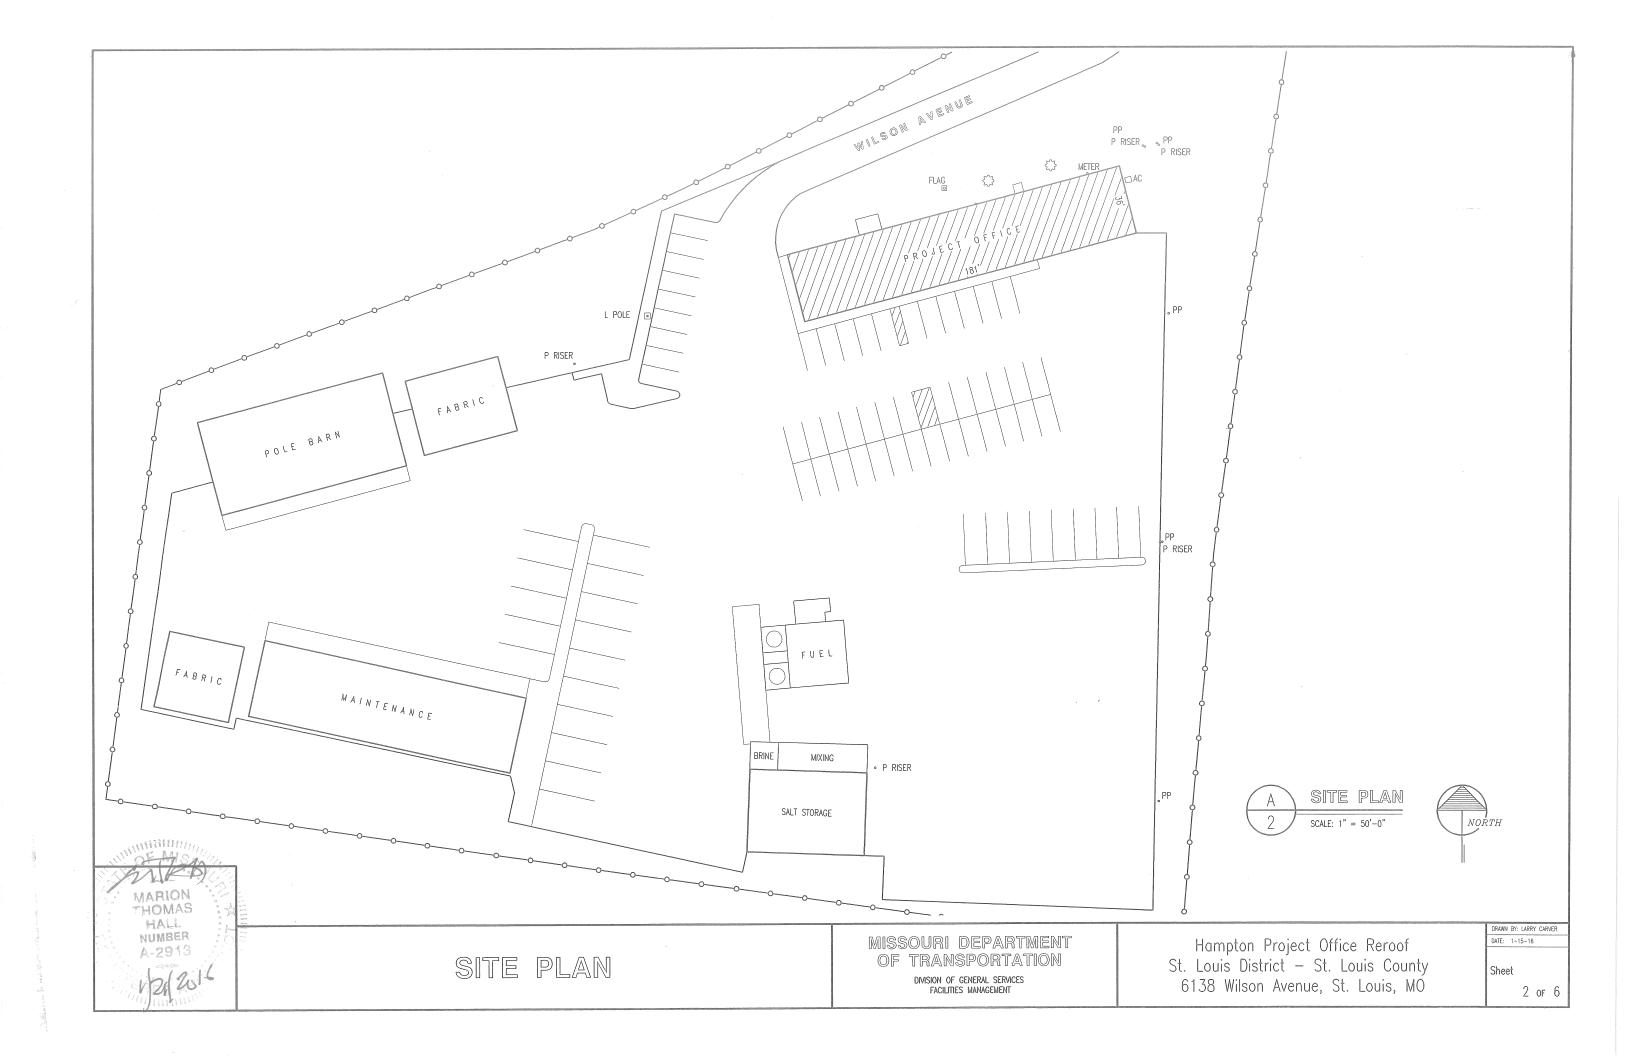

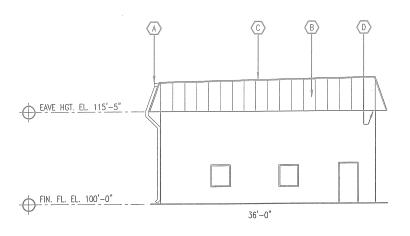


B WEST ELEVATION


3 SCALE: 1/16" = 1'-0"

CONTRACTOR NOTES:

- REMOVE EXISTING SHINGLES & FELT PAPER DOWN TO THE EXISTING ROOF SHEATHING. DISCARD ALL THE DEBRIS OFF-SITE. EXTEND 3/4" PLYWOOD ROOF SHEATHING TO MATCH EXISTING MANSARD SLOPE. INSTALL SYNTHETIC FELT PAPER OVER ALL THE MANSARD SHEATHING. INSTALL 26 GA. PREFINISHED METAL SHEET ROOFING ON 2 x 4 MALERS © 24" O.C.
- © INSTALL NEW 26 GA. PREFINISHED DRIP EDGE AT ROOF EDGE. REMOVE THE EXISTING SOFFIT AND DISCARD OFF-SITE. INSTALL NEW VENTED ALUMINUM SOFFIT.
- (D) REMOVE SEVEN EXISTING THRU-SOFFIT DOWNSPOUTS DISCARD OFF-SITE. PROVIDE AND INSTALL SEVEN (7) NEW ALUMINUM DOWNSPOUTS & CONCRETE SPLASH BLOCKS. BACK-PAINT AS REQUIRED DUE TO PREFINISHED ALUMINUM IS IN CONTACT WITH WITH PREFINISHED STEEL.
- $\stackrel{\textstyle \leftarrow}{\text{E}}$ top of existing mansard roof drip edge shown dashed. The entire roof slopes towards the back of the building.

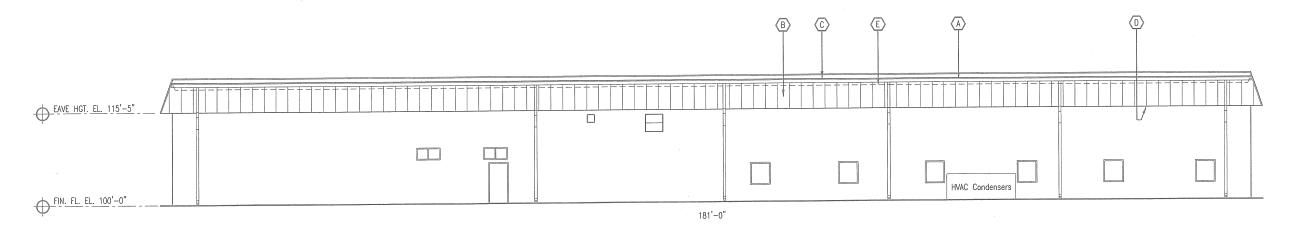



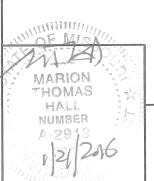

NORTH & WEST ELEVATIONS

MISSOURI DEPARTMENT OF TRANSPORTATION

DIVISION OF GENERAL SERVICES FACILITIES MANAGEMENT


Hampton Project Office Reroof St. Louis District — St. Louis County 6138 Wilson Avenue, St. Louis, MO DRAWN BY: LARRY CARVER
DATE: 1-15-16

Sheet


3 of 6

CONTRACTOR NOTES:

- REMOVE EXISTING SHINGLES & FELT PAPER DOWN TO THE EXISTING ROOF SHEATHING. DISCARD ALL THE DEBRIS OFF-SITE. EXTEND 3/4" PLYWOOD ROOF SHEATHING TO MATCH EXISTING MANSARD SLOPE. INSTALL SYNTHETIC FELT PAPER OVER ALL THE MANSARD SHEATHING. INSTALL 26 GA. PREFINISHED METAL SHEET ROOFING ON 2 x 4 NAILERS @ 24" O.C.
- © INSTALL NEW 26 GA. PREFINISHED DRIP EDGE AT ROOF EDGE. REMOVE THE EXISTING SOFFIT AND DISCARD OFF-SITE. INSTALL NEW VENTED ALUMINUM SOFFIT.

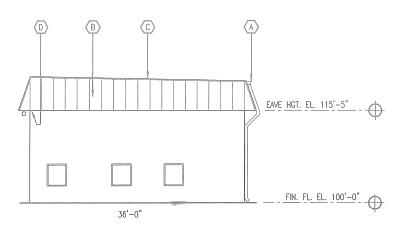

B EAST ELEVATION
4 SCALE: 1/16" = 1'-0"

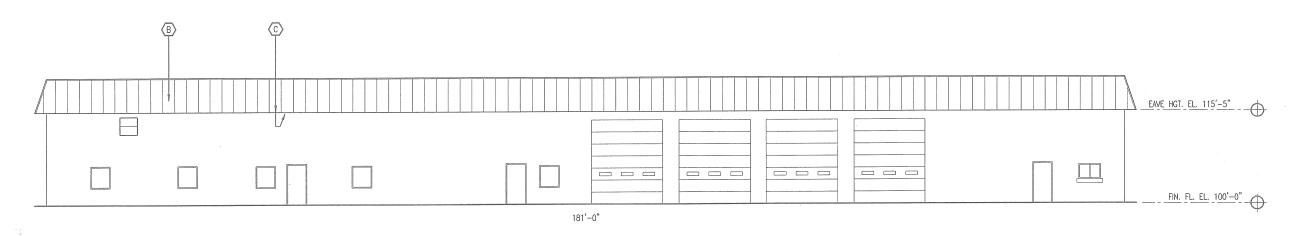

A SOUTH ELEVATION
4 SCALE: 1/16" = 1'-0"

MARION THOMAS HALL NUMBER A-2918

SOUTH & EAST ELEVATIONS


MISSOURI DEPARTMENT OF TRANSPORTATION

DIVISION OF GENERAL SERVICES FACILITIES MANAGEMENT

Hampton Project Office Reroof St. Louis District — St. Louis County 6138 Wilson Avenue, St. Louis, MO DRAWN BY: LARRY CARVER
DATE: 1-15-16

Sheet

4 or 6

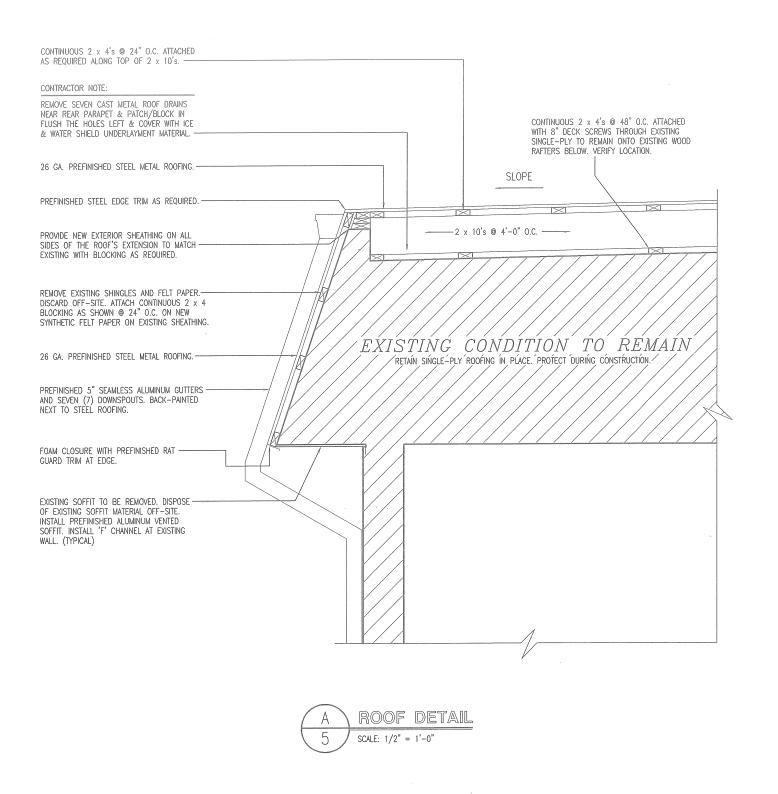

MARION THOMAS HALL NUMBER A-2913

DETAILS


MISSOURI DEPARTMENT OF TRANSPORTATION

DIVISION OF GENERAL SERVICES FACILITIES MANAGEMENT

Hampton Project Office Reroof St. Louis District — St. Louis County 6138 Wilson Avenue, St. Louis, MO DRAWN BY: LARRY CARVER
DATE: 1-15-16

Sheet

5 of 6

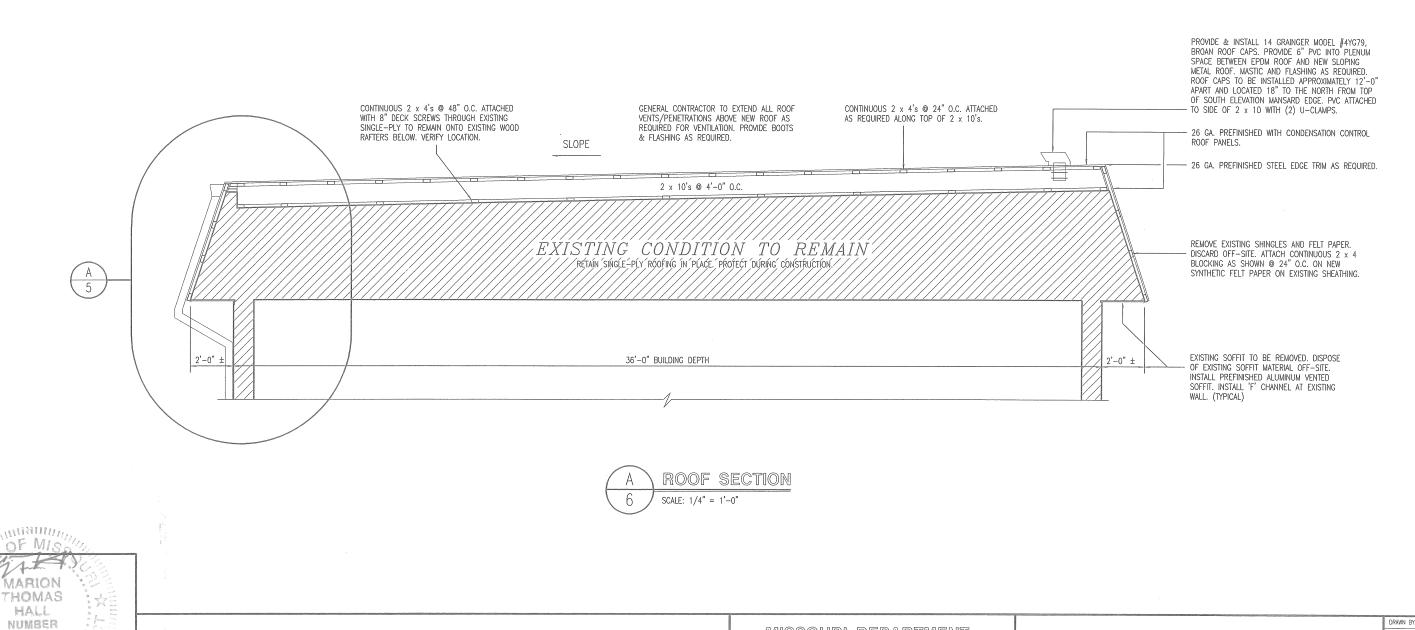

ROOF SECTION

A-2913

MISSOURI DEPARTMENT OF TRANSPORTATION

DIVISION OF GENERAL SERVICES FACILITIES MANAGEMENT

Hampton Project Office Reroof St. Louis District - St. Louis County 6138 Wilson Avenue, St. Louis, MÓ

DRAWN BY: LARRY CARVER

DATE: 1-15-16

Sheet

6 or 6