## ADDENDUM NUMBER <u>003</u>

Project Number Project Title

HPP-3303(419) City Project No. 70232201

**MLK Pedestrian Bridge** 

ISSUE DATE: October 3, 2025

Bidders are hereby notified that the Bidding and Contract Documents for the above project, for which Bids are to be received on <u>October 8, 2025</u>, are amended as follows:

The Bid date for this Project stated in Document 00130 - Invitation to Bid shall be changed to: 2:00 PM, on October 22, 2025.

Information to Bidders The following is provided to Bidders for information only:

- 1. Form 00412 Unit Prices have been updated and replaced with 'REVISED Form 00412 Unit Prices'.
- 2. Addendum Number 003 contains the attachment 'RFI UPDATED Revisions'.

Q1.	Drawing E103 on the Luminaire schedule shows different QTY for L05 and L04. Please
	confirm QTYS.
<b>A1.</b>	Do not refer to the photometric plans for quantities as not all or adjacent fixtures
	are utilized in this study. Quantities can be found by the contractor doing take-off
	quantities from the plans, sheets E101 and E102 and verifying that against 'Revised
	Form 00412 Unit Bid Prices.
Q2.	Please provide Pedestrian light pole details and confirm where the 7 luminaire L05s and
	4 ATB2 P902 R2 3K are located on the plans.
A2.	Do not refer to the photometric plans for quantities as not all or adjacent fixtures
	are utilized in this study. Quantities can be found by the contractor doing take-off
	quantities from the plans, sheets E101 and E102 and verifying that against 'Revised
	Form 00412 Unit Bid Prices.

NOTE: Bidders must acknowledge receipt of this Addendum by listing the number and date, where provided, on the Bid Form - Document 00410.

## MLK PEDESTRIAN BRIDGE REVISIONS NARRATIVE

OCTOBER 2, 2025

**E001:** Revised construction note 25.

**E002:** Updated LFS to reflect current fixture specifications and equivalent manufacturers. Revised LP1 to include calculated wire sizes.

**E101:** Updated Pedestrian Bridge Lighting Plan 1/E101 to show conduit routing between type LO5 Pedestrian Poles.

Updated Pedestrian Bridge Lighting Plan 1/E101 to show separate boxes for control wires.

Updated Pedestrian Bridge Lighting Plan 1/E101 to show power supply to fixture type LO4.

E102: Updated North Sidewalk Lighting Plan 2/E102 to show power supply to fixture type LO4.

Updated South Sidewalk and Plaza Lighting Plan 3/E102 to show conduit routing between type LO5 Pedestrian Poles.


Updated South Sidewalk and Plaza Lighting Plan 3/E102 to show separate box for control wires.

Updated South Sidewalk and Plaza Lighting Plan 3/E102 to show power supply to fixture type LO4.

Revised Key Note 5 to include calculated wire sizes.

**E202:** Revised Conduit Routing Diagram Detail 1/E202 to include separate box for control wires, and to accurately display number of conduits exiting junction box.

Added NEW Pole Elevation Detail 2/E202.

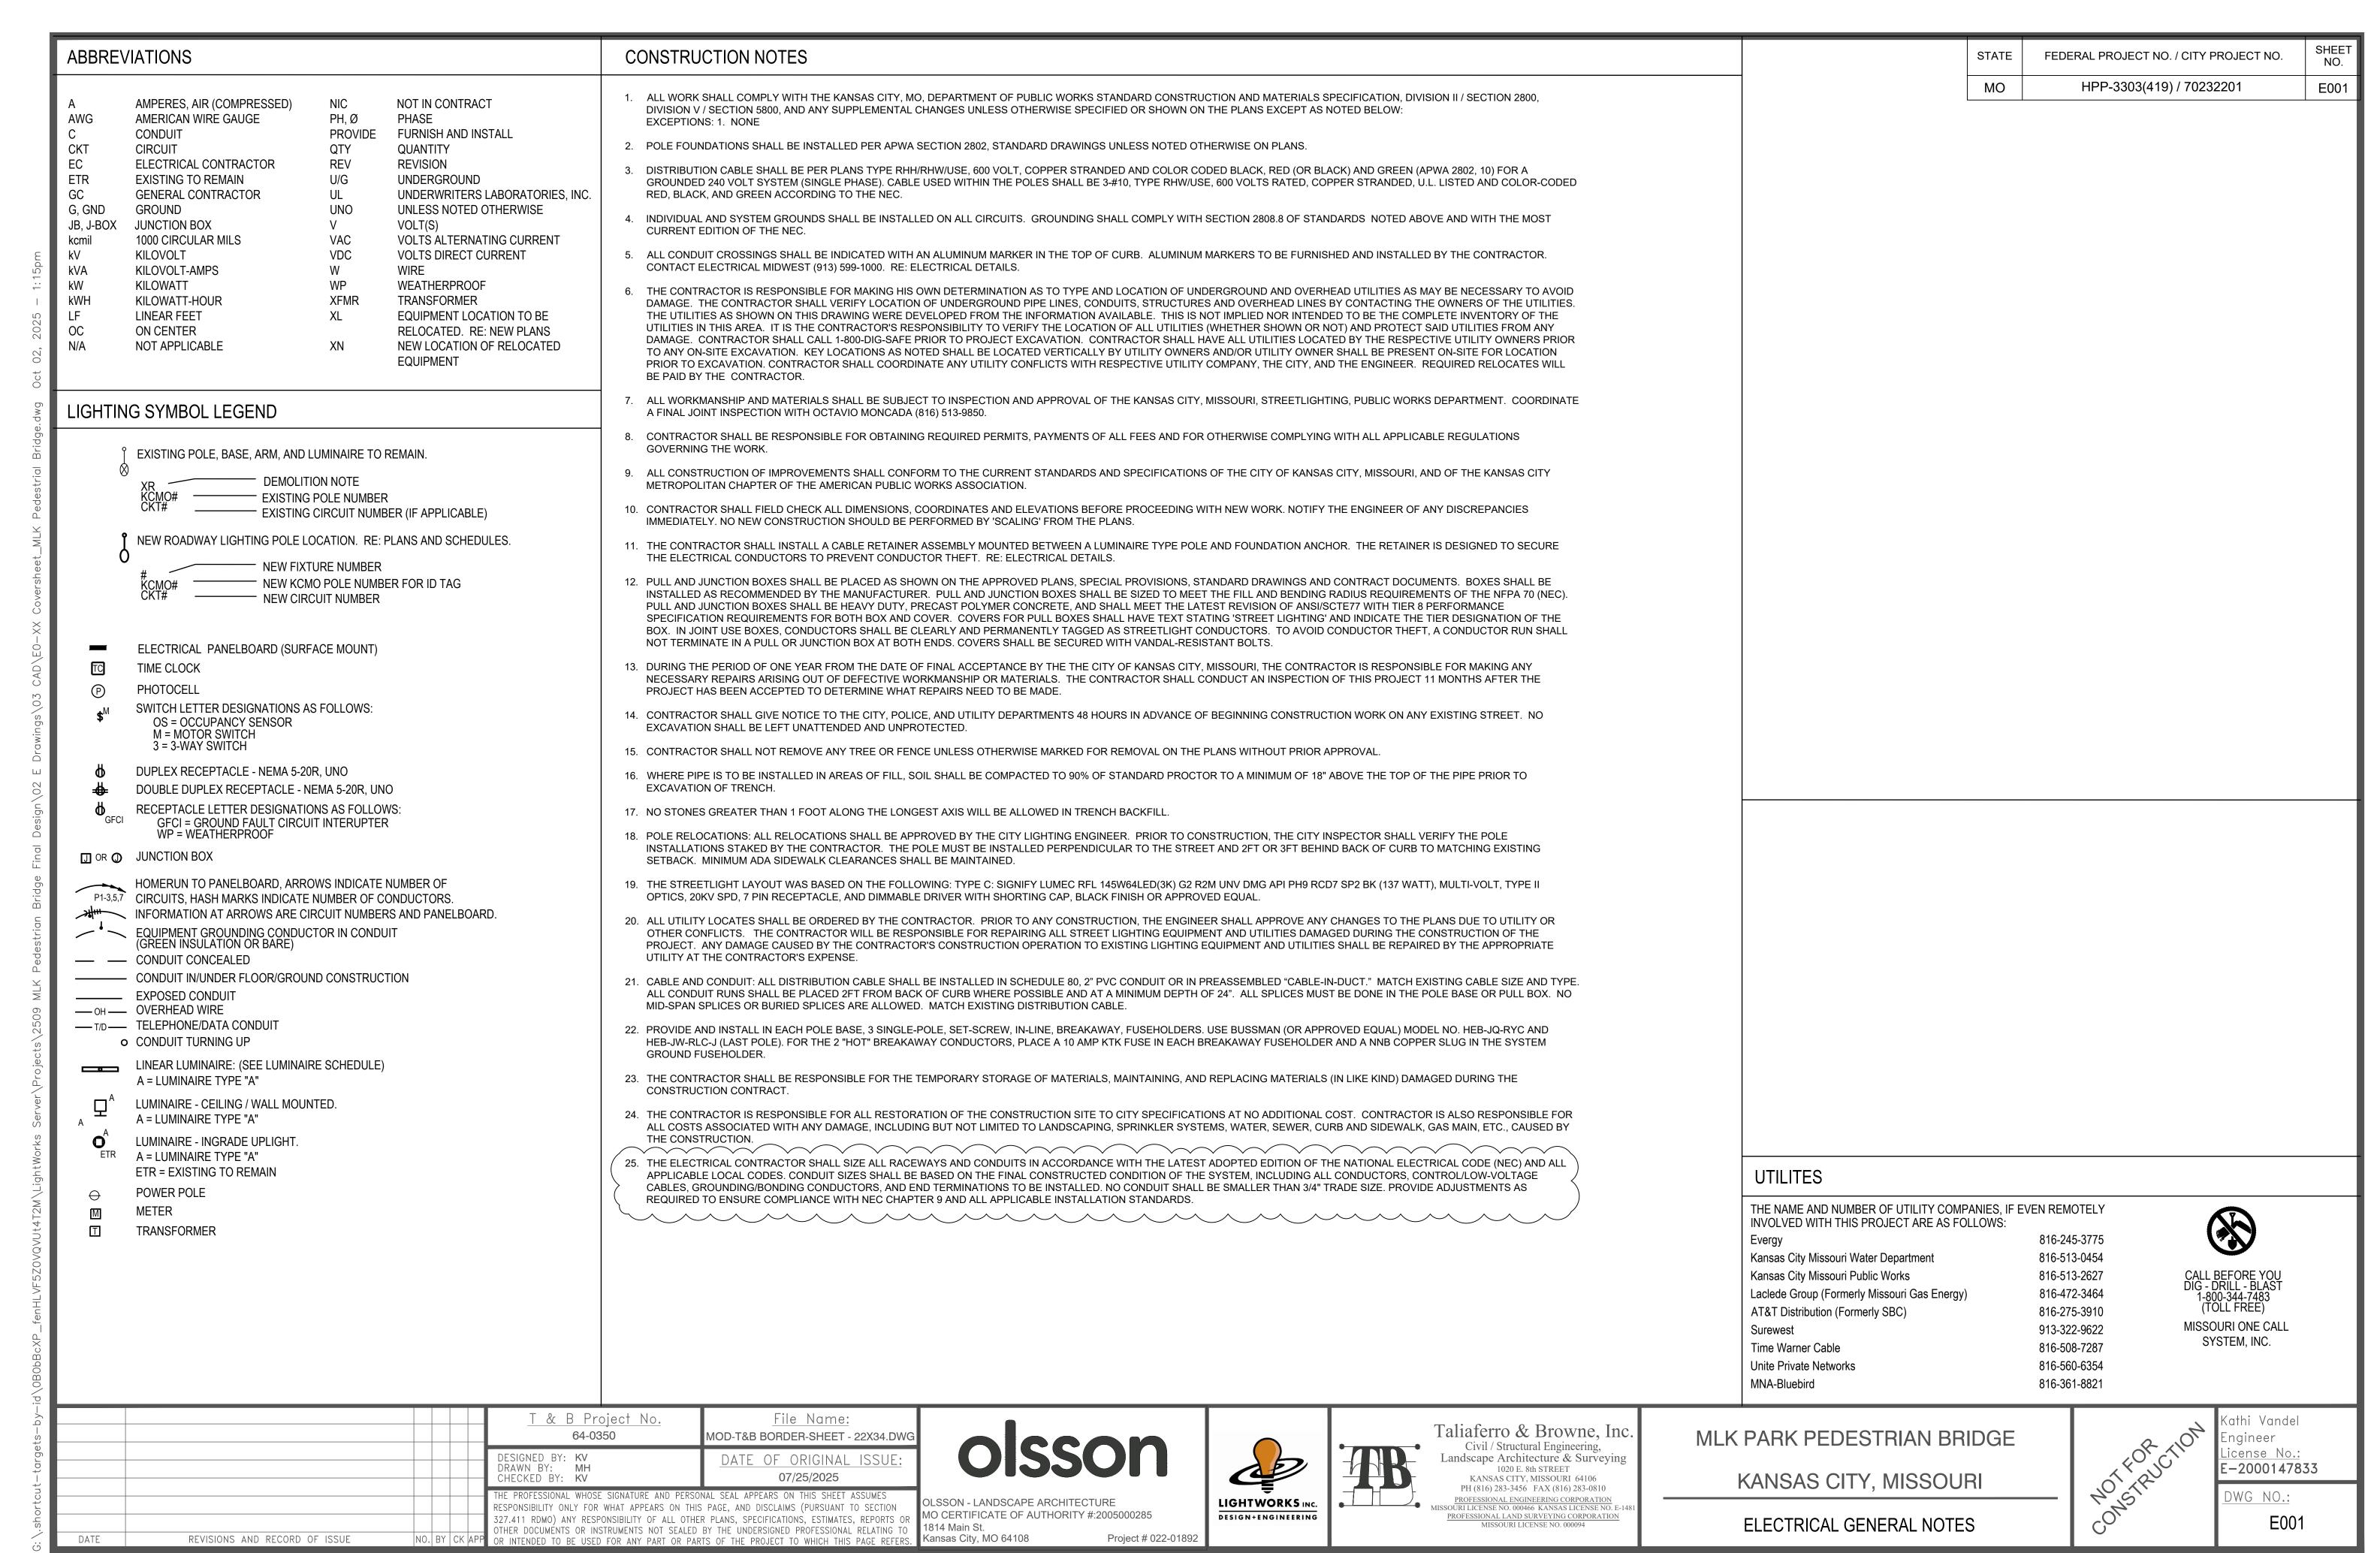

				Lle	GHTING F	IXTURE	SCHEDU	JLE			
SYMBOL	MANUFACTURER	MODEL #	LAMP	COLOR TEMP	DIMMING	WATTS	VOLTAGE	FINISH TBD	DESCRIPTION  2.5" DV 2.5" DV 4.72" LONG COMPACT AD HISTARI E LED	LOCATION	NOTES
LO1a	ECOSENSE OR EQUIVALENT BY INTERLUX OR GVA	F080 1S MO 30 8 40 F / LDCM- PL-120-277-0010V-GR	LED, 731 LUMENS	3000K, 80CRI	0-10V, 5%	7.5 W	110-277	IBD	2.5" BY 2.5" BY 4.72" LONG COMPACT ADJUSTABLE LED DOWNLIGHT, WITH 40 DEGREE BEAM. IP66 RATED FOR EXTERIORS. DIMMABLE TO 5%.	BRIDGE DOWNLIGHT	REF: DETAIL 1/E201
LO1b		F080 1S HO 30 8 E2 F / LDCM- PL-120-277-0010V-GR	LED, 583 LUMENS	3000K, 80CRI	0-10V, 5%	11.5 W	110-277	TBD	2.5" BY 2.5" BY 4.72" LONG COMPACT ADJUSTABLE LED DOWNLIGHT, WITH 30X50 ELLIPTICAL BEAM. IP66 RATED FOR EXTERIORS. DIMMABLE TO 5%.	BRIDGE DOWNLIGHT	REF: DETAIL 1/E201
LO1c		F080 1S MO 30 8 90 F / LDCM- PL-120-277-0010V-GR	LED, 523 LUMENS	3000K, 80CRI	0-10V, 5%	7.5 W	110-277	TBD	2.5" BY 2.5" BY 4.72" LONG COMPACT ADJUSTABLE LED DOWNLIGHT, WITH 90 DEGREE BEAM. IP66 RATED FOR EXTERIORS. DIMMABLE TO 5%.	BRIDGE DOWNLIGHT	REF: DETAIL 1/E201
LO2		LS9260-16D-4CA-67-DC-Q-13- PS-XX / LS6327 / LS6550-2D	LED, 1080 LUMENS	RGBA	DMX	20 W	100-240	TBD	NOMINAL 6" ROUND SURFACE MOUNTED EXTERIOR RATED RGBA LED POINT OF LIGHT. SUITED FOR DIRECT VIEW APPLICATIONS. IP66 RATED FOR EXTERIORS, DMX CONTROLLED.	BRIDGE ARCH	REF: DETAIL 2/E201
LO3	COLOR KINETICS OR EQUIVALENT BY GVA OR INSIGHT	423-000036-29 / 120-000216-04	LED, 555 LUMENS/FT	RGBA	DMX	8.3 W/FT	100-277	TBD	1.66" WIDE BY 48.06" LONG RGBA LED LINEAR PROJECTOR WITH 30X60 OPTICS. IP66 EXTERIOR RATED AND DMX CONTROLLED.	BRIDGE FINS	REF: DETAIL 3/E201
LO4		XE RAF F 36 22 IND 30 NFL E99763	LED, 528.67 LUMENS/FT	3000K, 80CRI	NA	7.5 W/FT	120-277	SILVER	NOMINAL 1.6" WIDE BY 36.2" LONG RECESSED LINEAR LED WITH NARROW FLOOD OPTICS. INTEGRAL DRIVER, RATED IP67.	MLK SIGNAGE UPLIGHT	REF: DETAIL 3/E202
LO5		1SA SARA2 27L 695 3K8 3 UNV / PRA-14-4125-SA-DBT	LED, 6000 LUMENS	3000K, 80CRI	N/A	59 W	120-277	BRONZE	12" BY 17.125" LED SITE LIGHT MOUNTED ON 4" ROUND STRAIGHT 14' POLE. FIXTURE SHALL BE TYPE 3 DISTRIBUTION.	PEDESTRIAN POLE	REF: DETAIL 5/E202

## **GENERAL NOTES:**

A. MANUFACTURER TO PROVIDE PROJECT SPECIFIC SHOP DRAWINGS SHOWING EXACT MOUNTING, FINISH, LENGTH, SHAPE AND LAMPING OF LUMINAIRE. VERIFY CEILING CONDITIONS AND COORDINATE LIGHT FIXTURE MOUNTING HARDWARE AND TRIMS NEEDED TO SUIT CEILING CONDITIONS PRIOR TO ORDERING.

B. VERIFY FINISH AND COLOR WITH ARCHITECT PRIOR TO PLACING ORDER.

LIGHTING	IGHTING COLOR CONTROLLER SCHEDULE										
SCENE	DESCRIPTION	DOWNLIGHTS (LO1)	ARCH (LO2)	FINS EAST (LO3)	FINS WEST (LO3)	SIGNAGE (LO4)	PEDESTRIAN LIGHTS (LO5)				
1	CHIEFS	PC/TC	CHIEFS RED	CHIEFS YELLOW	CHIEFS YELLOW	PC/TC	PC/TC				
2	ROYALS	PC/TC	WHITE	ROYALS BLUE	ROYALS BLUE	PC/TC	PC/TC				
3	CURRENT	PC/TC	HEARTLAND RED	TEAL	TEAL	PC/TC	PC/TC				
4	SPORTING KC	PC/TC	LIGHT BLUE	LIGHT BLUE	LIGHT BLUE	PC/TC	PC/TC				
5	ST PATRICKS DAY	PC/TC	GREEN	GREEN	GREEN	PC/TC	PC/TC				
6	BLACK HISTORY R G Y	PC/TC	xxx	xxx	xxx	PC/TC	PC/TC				
7	PINK (VALENTINES, BREAST CANCER)	PC/TC	PINK	PINK	PINK	PC/TC	PC/TC				
8	BLACK HISTORY MONTH	PC/TC	YELLOW	RED	GREEN	PC/TC	PC/TC				
9	PATRIOTIC	PC/TC	BLUE	RED	RED	PC/TC	PC/TC				
10	ALL WHITE	PC/TC	WHITE	WHITE	WHITE	PC/TC	PC/TC				

ZONE #	DESCRIPTION	FIXTURE TAG	CIRCUIT	CONTROL	RGBW CHANNELS
1	DOWNLIGHTS	LO1	LP1-1	ON/OFF	1
2	ARCH NORTH	LO2	LP1-3	RGBW	4
3	ARCH SOUTH	LO2	LP1-3	RGBW	4
4	FINS EAST	LO3	LP1-2	RGBW	4
5	FINS WEST	LO3	LP1-4	RGBW	4
6	SIGNAGE	LO4	LP1-5	ON/OFF	1
7	PEDESTRIAN LIGHTS SOUTH	LO5	LP1-6	ON/OFF	1
			 TOTAL DMX	CHANNELS:	19

PANEL	LP1	120/	208	L-G VOLTS				100	A. BUS			SERVICE ENTRANCE	
		_	120	L-L VOLTS			_		_	,		-	
			1	PHASE			_	100	A. MAIN	BREAKER		SUBFEED LUGS	
			3	WIRE					MAIN LU	GS ONLY		FEED THRU LUGS	
	FEEDER LENGTH			FT			_	Х	SURFACE	MOUNTI	NG	FLUSH MOUNTING	
CIRC.	CIRCUIT	CIRC.	BRKR.	WIRE	LOAD	CONNECTE	D PER PHASE	LOAD	WIRE	CIRC.	BRKR.	CIRCUIT	CIRC
NO.	DESCRIPTION	AMPS	POLES	SIZE		Α	В		SIZE	AMPS	POLES	DESCRIPTION	NO.
1	Bridge Downlights	20	1	8CU	80	1450		1370	8CU	20	2	Bridge Fine Feet	2
3	Bridge Dots	20	1	6CU	400		1770	1370	000	20	2	Bridge Fins East	4
5	Signage	20	1	8CU	36	1406		1370	8CU	20	2	Bridge Fins West	6
7	Control	20	1	8CU	100		1470	1370	800	20		Bridge Firis West	8
9	Spare	20	1		0	0		0	12CU	20	1	South Ped Poles	10
11	Space Only				0		0	0				Space Only	12
	SUBTOT	AL CONNECT	TED LOAD	WATTS		2856	3240		WATTS				
		TOTAL CON TOTAL CO AL PANELBO PANELBOAR	NNECTED	LOAD (A)	= = = =		6096 29.31 7620 36.63		GFI = G		FAULT	MECLOCK OFF INTERRUPTER	

		T & B Project No. 64-0350	<u>File Name:</u> MOD-T&B BORDER-SHEET - 22X34.DWG	
		DESIGNED BY: <b>KV</b> DRAWN BY: <b>MH</b> CHECKED BY: <b>KV</b>	DATE OF ORIGINAL ISSUE: 07/25/2025	OISSON
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Project # 022-01892






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MLK PARK PEDESTRIAN BRIDGE KANSAS CITY, MISSOURI

ELECTRICAL SCHEDULES

<u>License No.:</u> E-2000147833

DWG NO.: E002

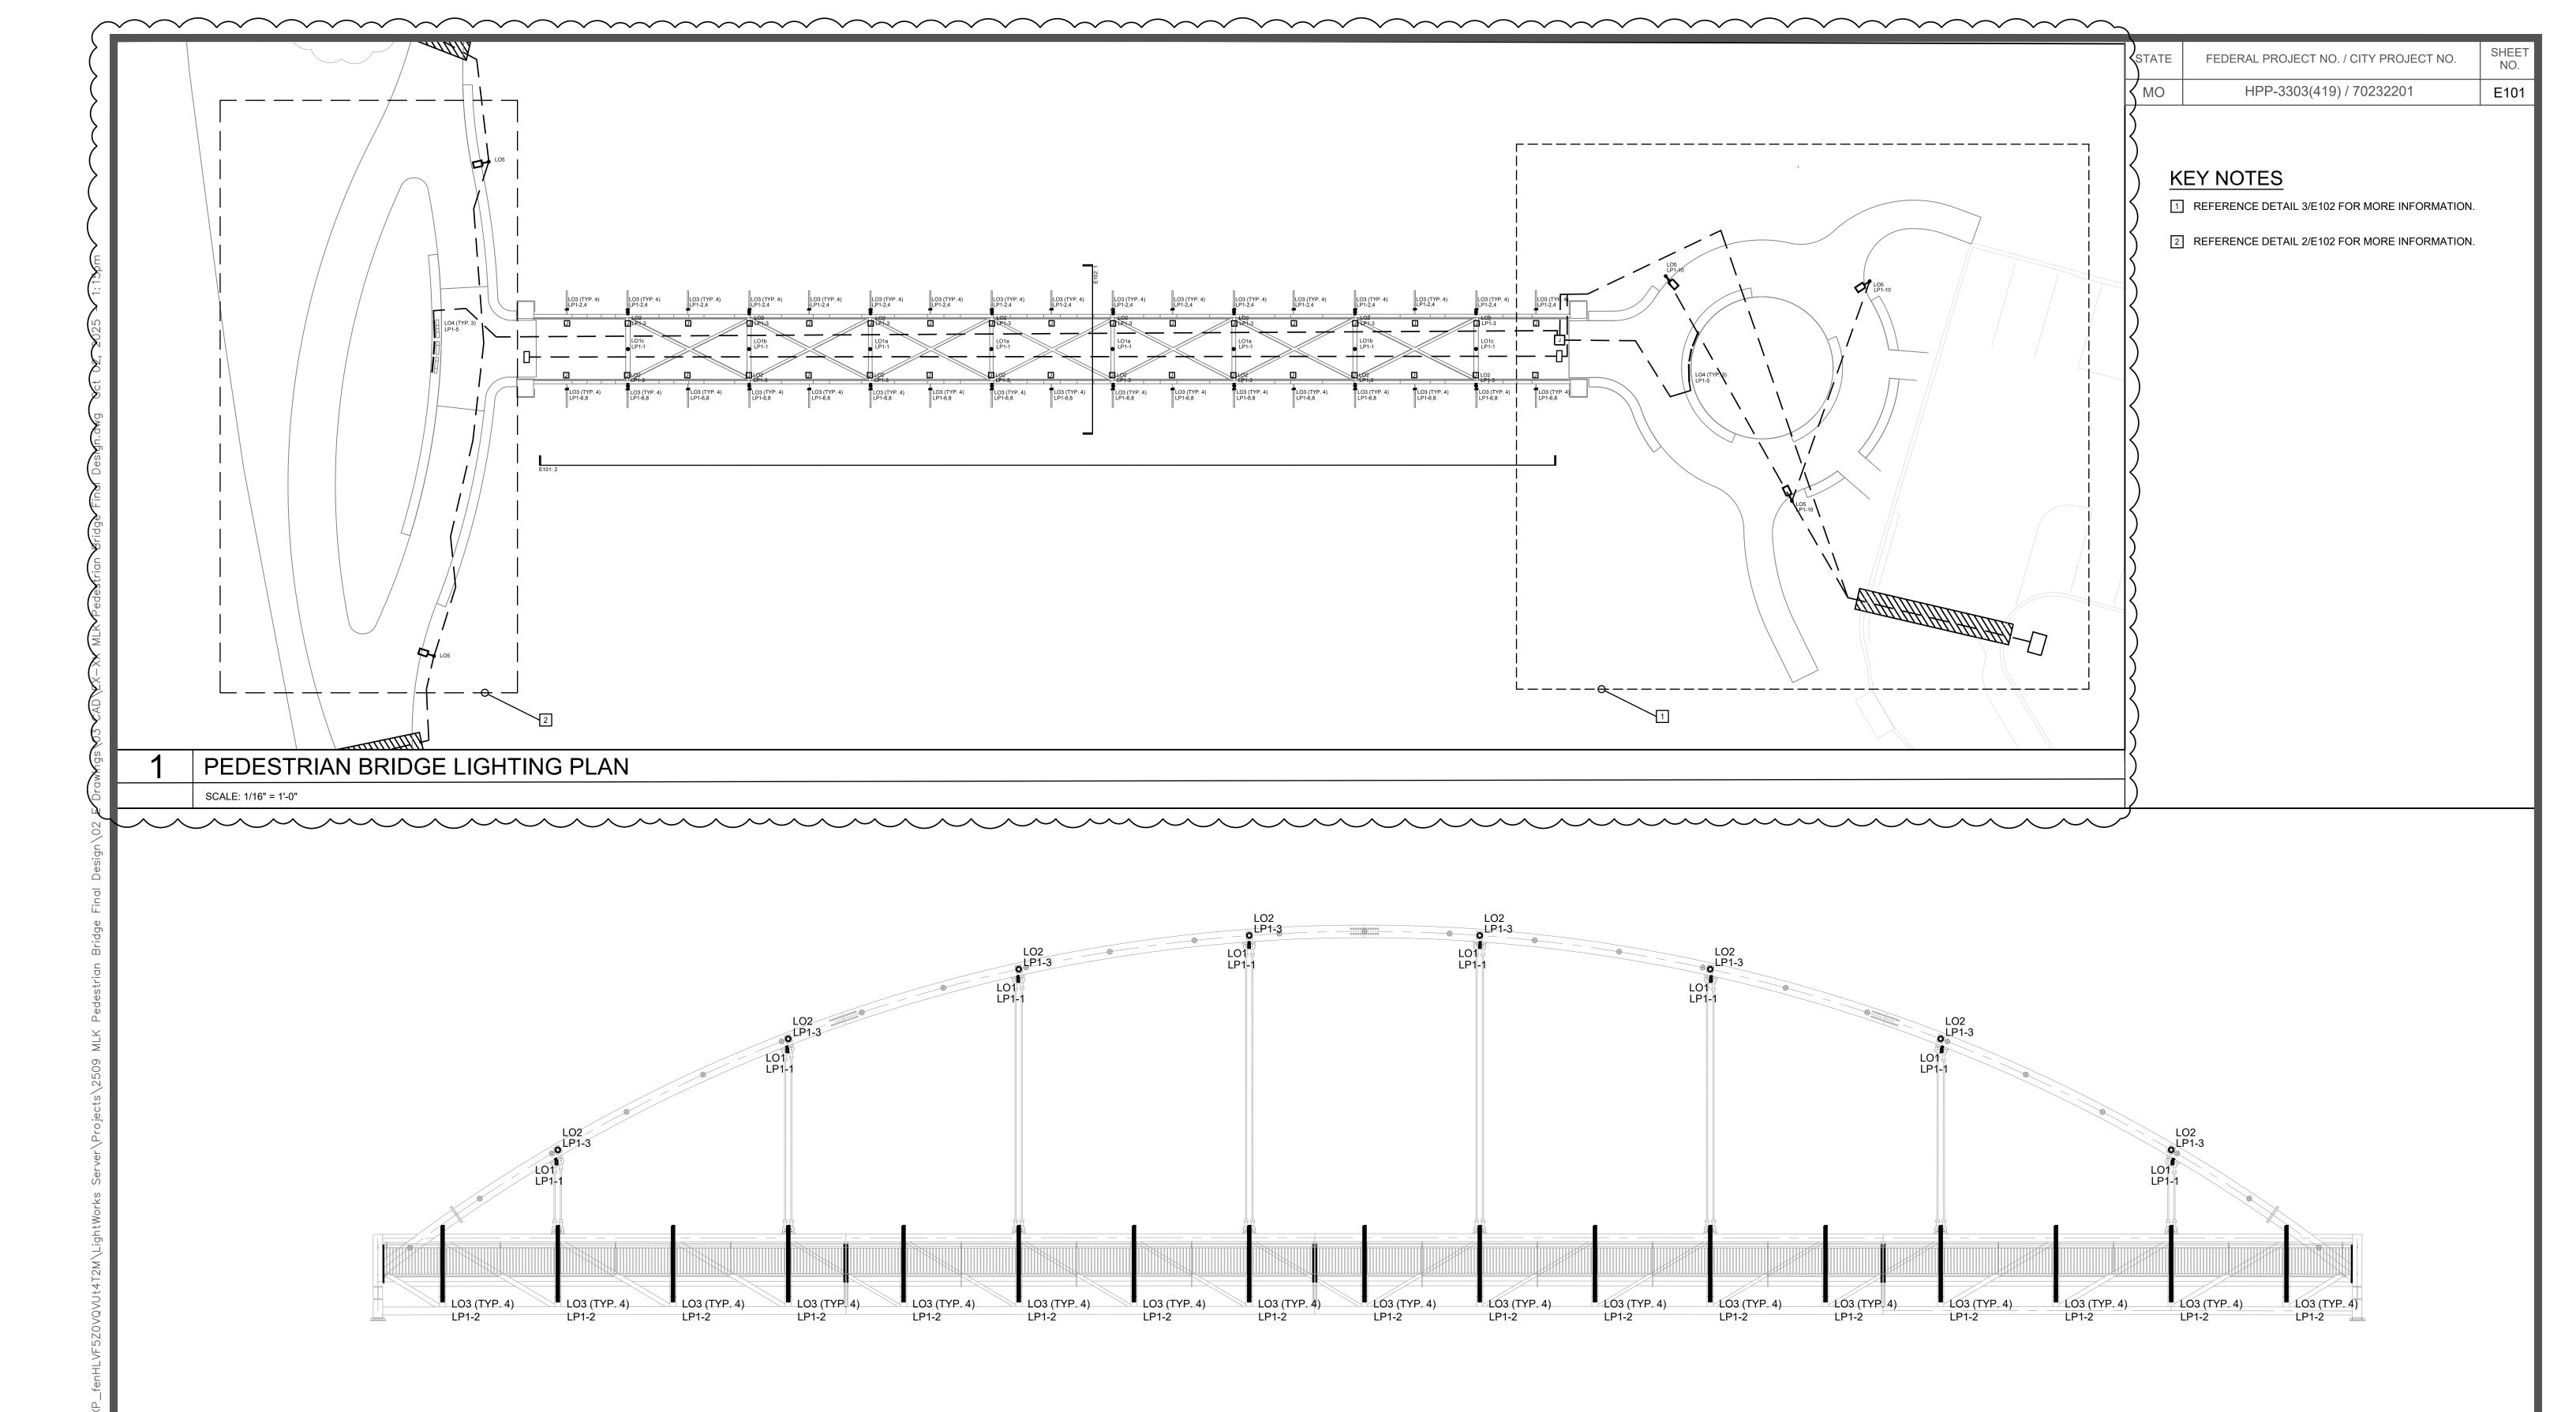

PEDESTRIAN BRIDGE ELEVATION SCALE: 1/8" = 1'-0"

DATE

			<u>I &amp; B Project No.</u>	<u>File Name:</u>	
			64-0350	MOD-T&B BORDER-SHEET - 22X34.DWG	
			DESIGNED BY: KV DRAWN BY: MH CHECKED BY: KV	DATE OF ORIGINAL ISSUE: 07/25/2025	OISSON
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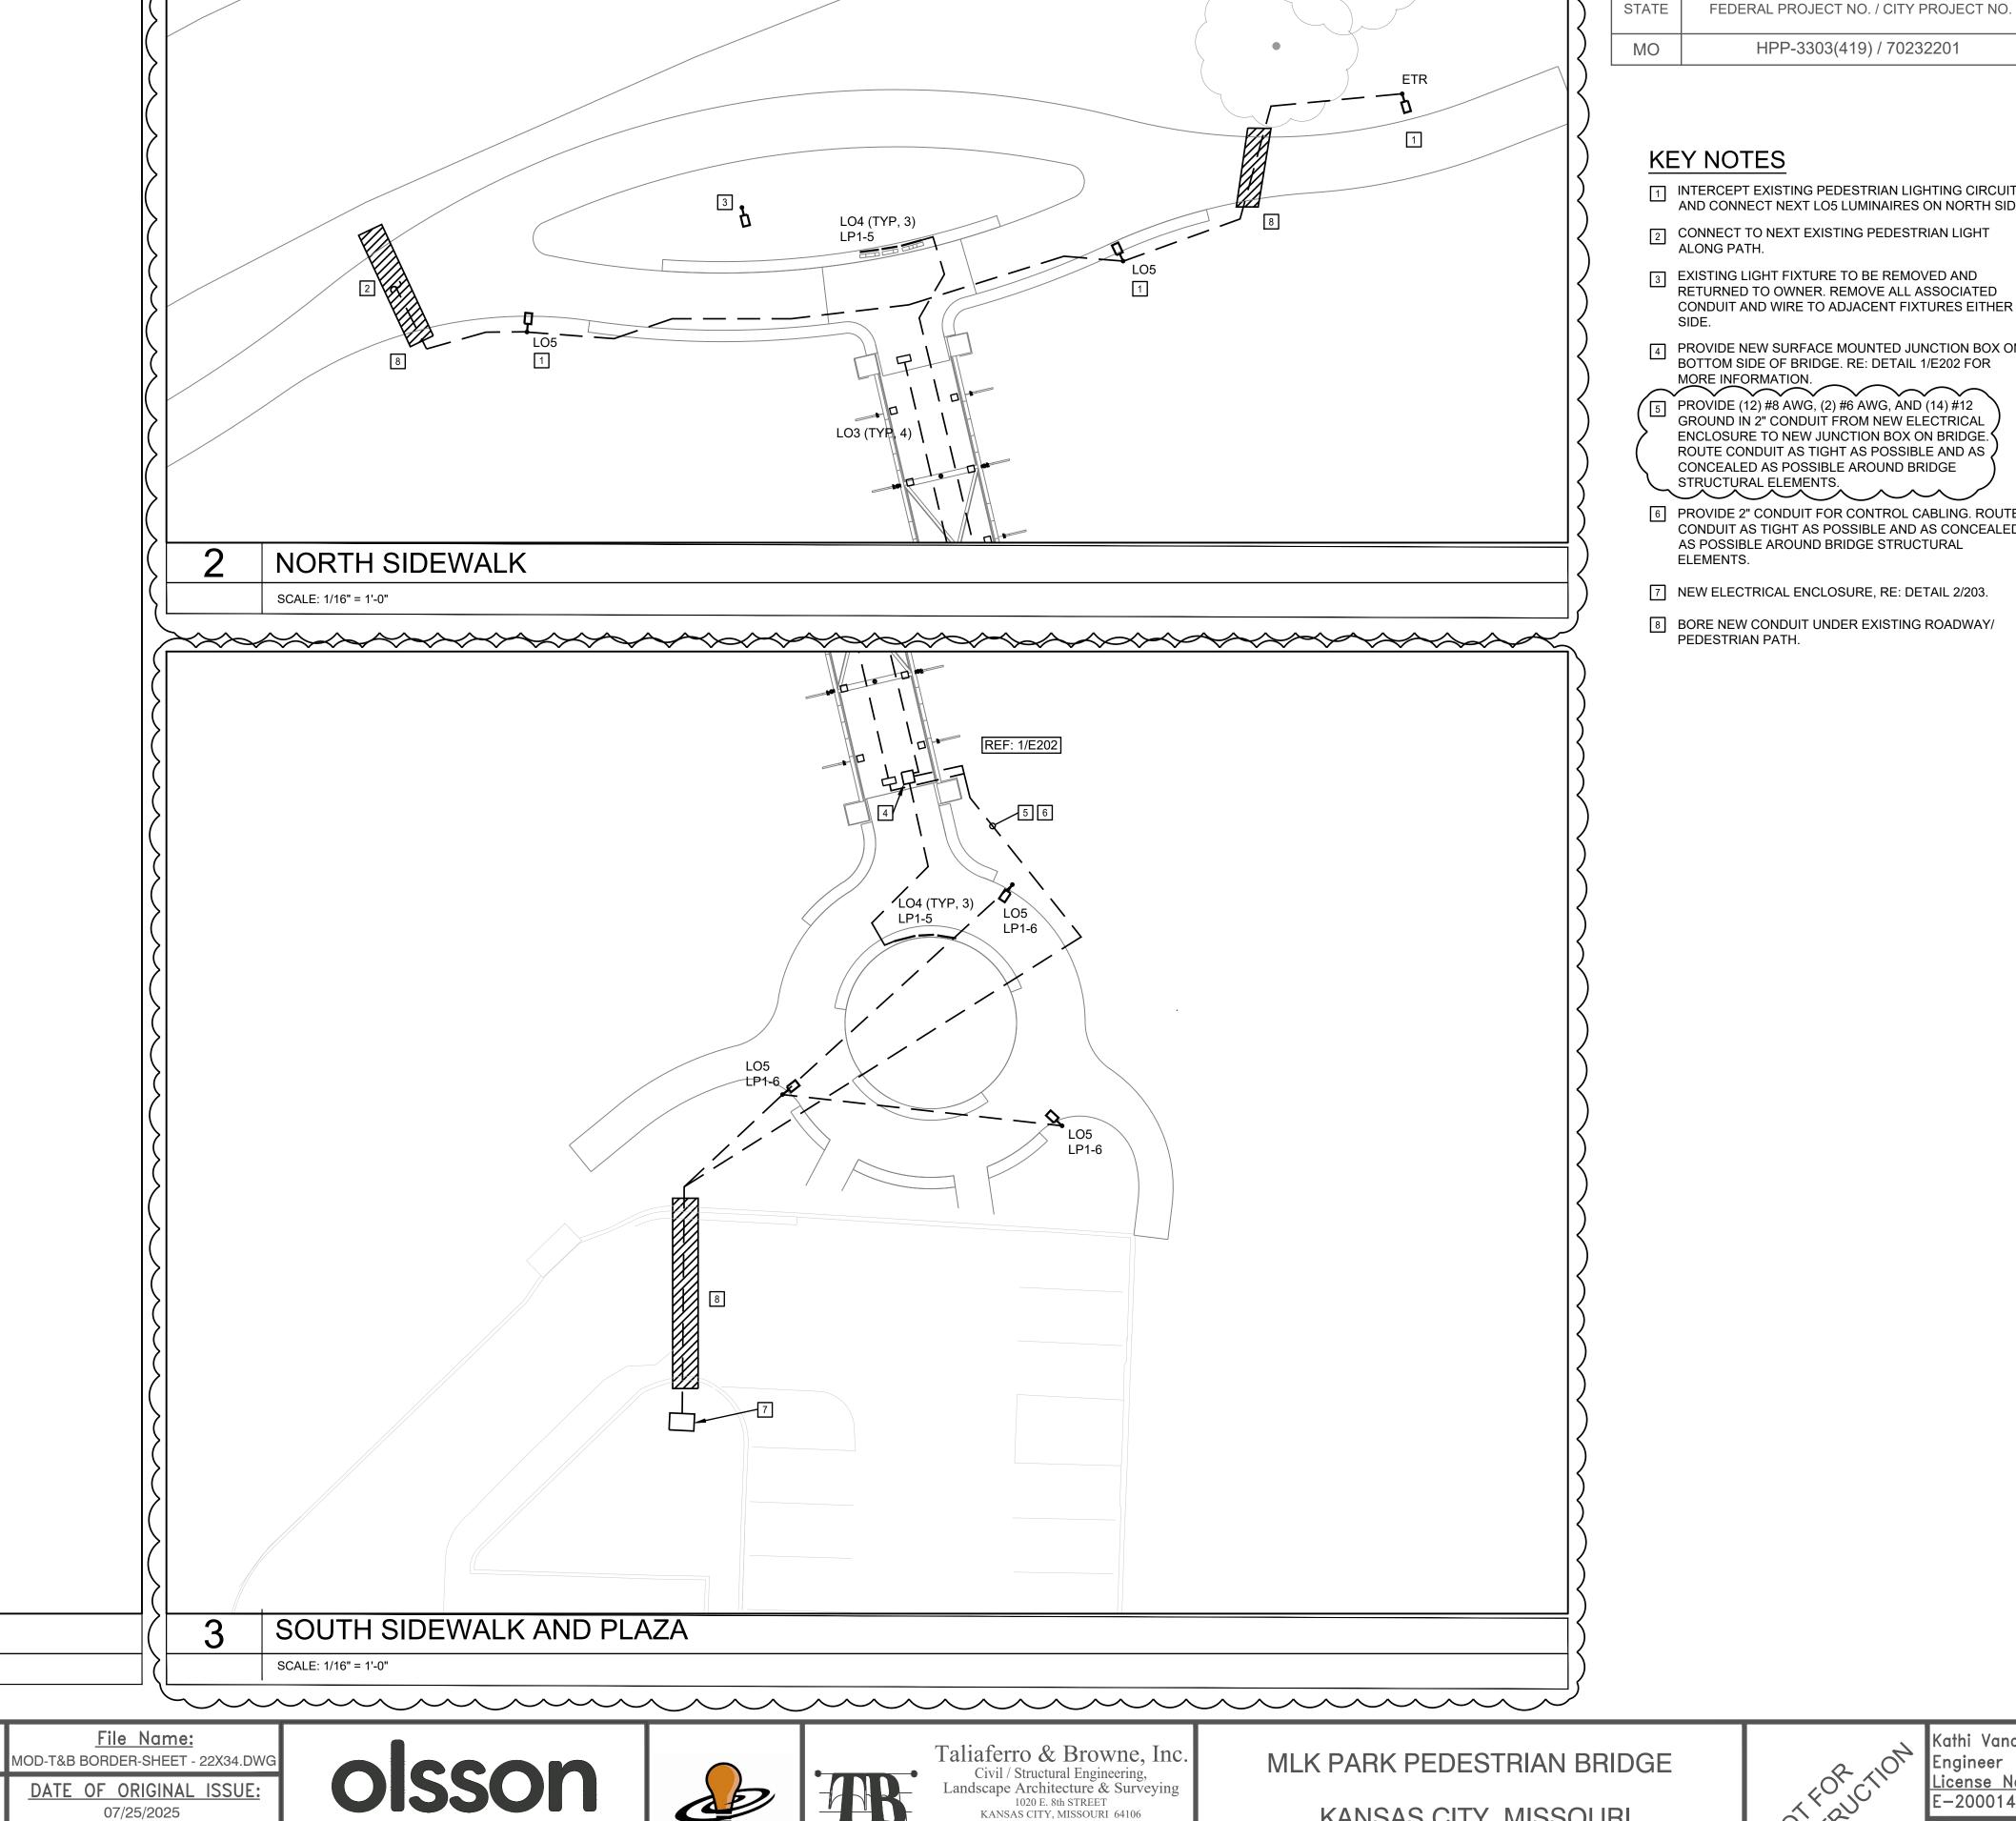


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LIGHTING PLAN AND ELEVATION

License No.: E-2000147833

<u>DWG NO.:</u> E101



INTERCEPT EXISTING PEDESTRIAN LIGHTING CIRCUIT AND CONNECT NEXT LO5 LUMINAIRES ON NORTH SIDE.

E102

2 CONNECT TO NEXT EXISTING PEDESTRIAN LIGHT

3 EXISTING LIGHT FIXTURE TO BE REMOVED AND RETURNED TO OWNER. REMOVE ALL ASSOCIATED CONDUIT AND WIRE TO ADJACENT FIXTURES EITHER

PROVIDE NEW SURFACE MOUNTED JUNCTION BOX ON BOTTOM SIDE OF BRIDGE. RE: DETAIL 1/E202 FOR

FROVIDE (12) #8 AWG, (2) #6 AWG, AND (14) #12 GROUND IN 2" CONDUIT FROM NEW ELECTRICAL ENCLOSURE TO NEW JUNCTION BOX ON BRIDGE. ROUTE CONDUIT AS TIGHT AS POSSIBLE AND AS CONCEALED AS POSSIBLE AROUND BRIDGE STRUCTURAL ELEMENTS.

6 PROVIDE 2" CONDUIT FOR CONTROL CABLING. ROUTE CONDUIT AS TIGHT AS POSSIBLE AND AS CONCEALED AS POSSIBLE AROUND BRIDGE STRUCTURAL

7 NEW ELECTRICAL ENCLOSURE, RE: DETAIL 2/203.

8 BORE NEW CONDUIT UNDER EXISTING ROADWAY/ PEDESTRIAN PATH.

PEDESTRIAN BRIDGE SECTION

REVISIONS AND RECORD OF ISSUE

LO3 (TYP. 4) LP1-6,8

SCALE: 1/8" = 1'-0"

DATE

T & B Project No. 64-0350 DESIGNED BY: KV DRAWN BY: MH CHECKED BY: KV THE PROFESSIONAL WHOSE SIGNATURE AND PERSONAL SEAL APPEARS ON THIS SHEET ASSUMES

LP1-1

LP1-1

LO1

LP1-1

R LP1-1

LO2

LO2

LO2

LP1-3

LO2

LP1-3

LP1-3

LP1-3

LO2

LP1-3

LP1-3


LO3 (TYP. 4) LP1-2,4

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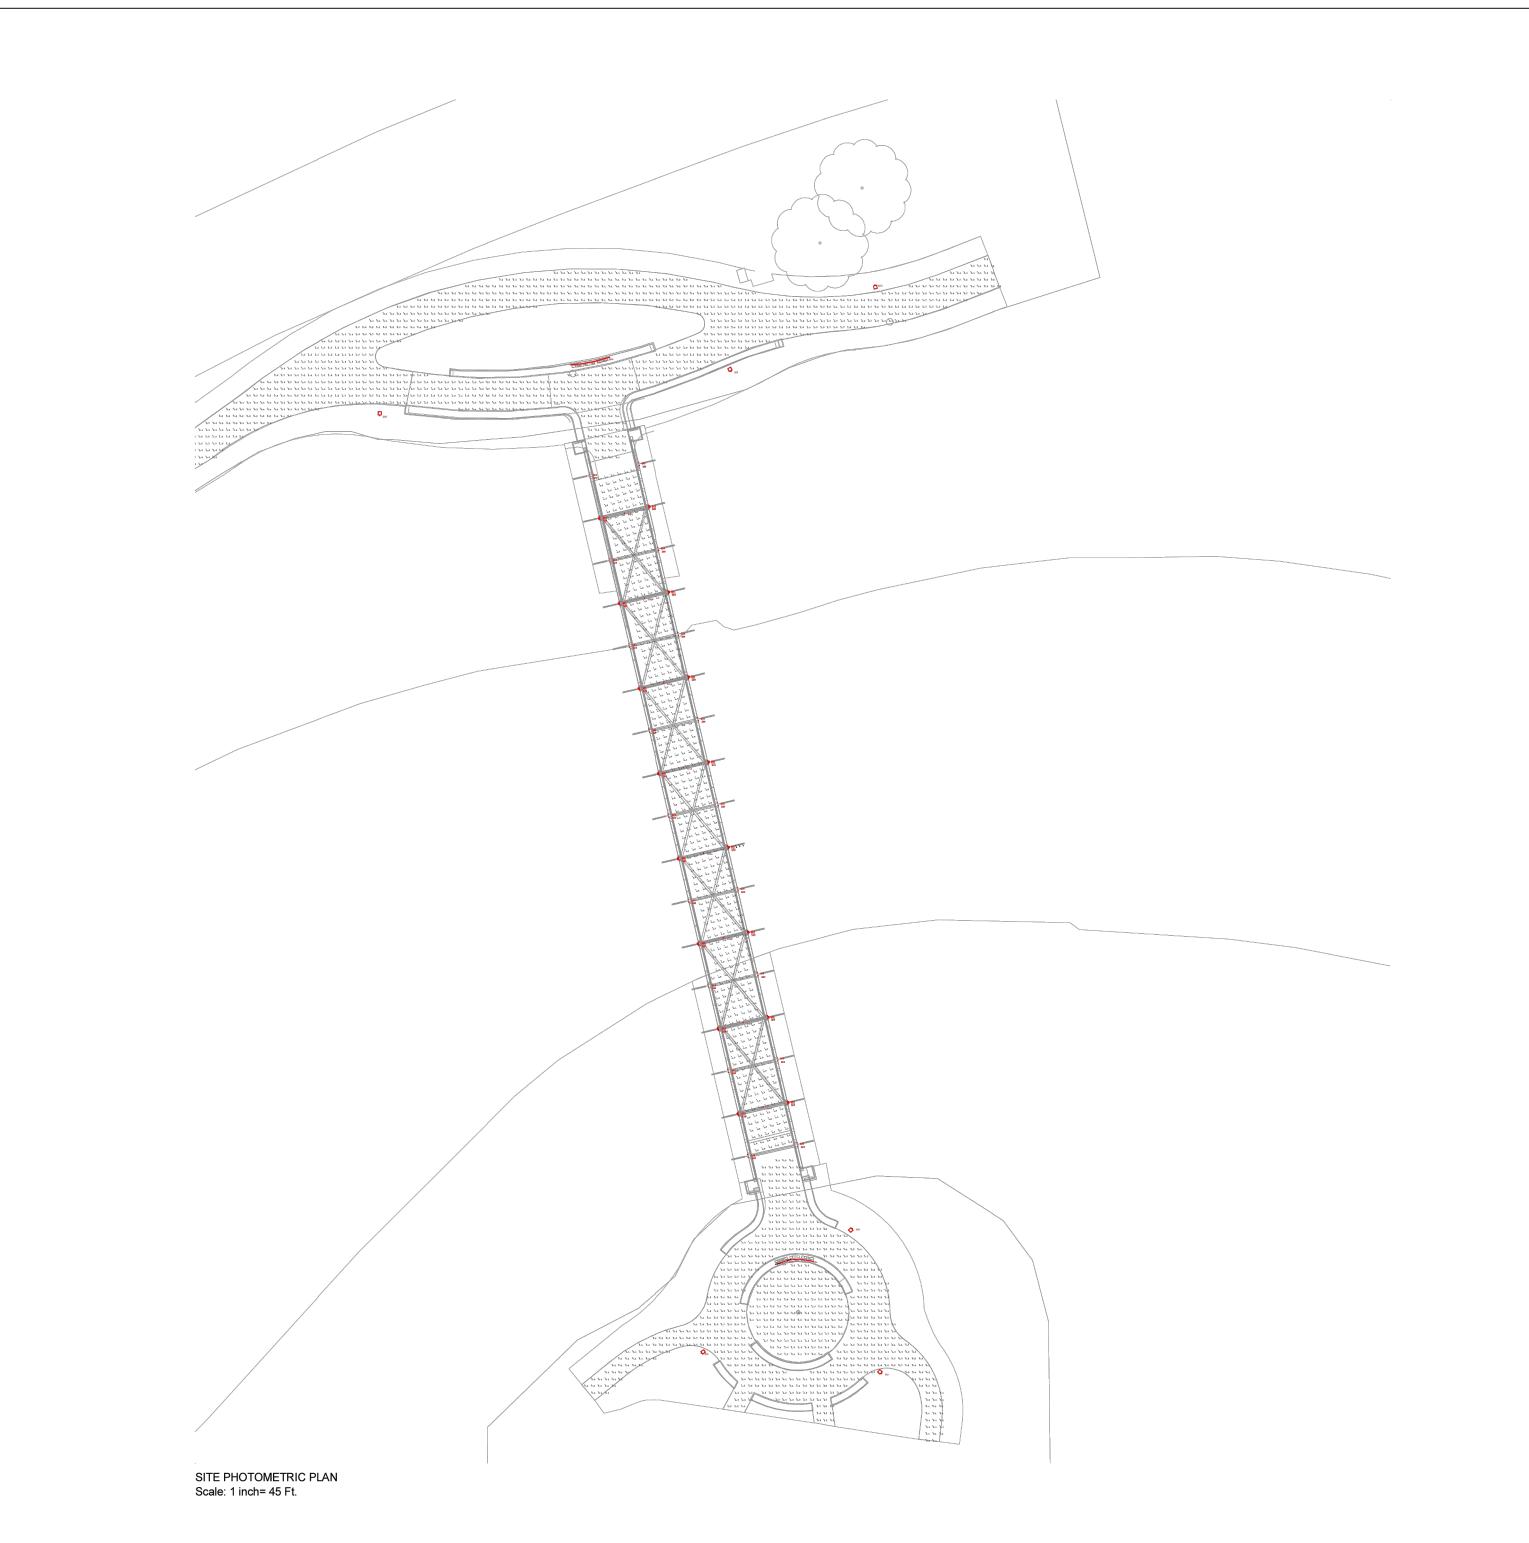
KANSAS CITY, MISSOURI

**BRIDGE LIGHTING SECTION** 

License No.: E-2000147833

DWG NO.:

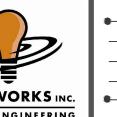E102







Luminaire So					
Scenario: All	On				
Symbol	Label	Description	Lumens	Watts	LLF
E	ATB2	ATB2 P902 R2 3K	35069	245	0.850
	P902 R2				
	3K				
2□	LO5	SAR2-27L-695-3K7-3-BC-CLR	2758	59.87	0.850
1	LO4	ILM47R-1.3-HO-WGS_E48D	816	11.3	0.390
	LO3	L60-E-12-10-RGB4-MULT-15X15-	198	10	0.850
		RED			
$\Box$	LO1c	F080-1S-MO-30-8-90	523	7.5	0.850
<b>(*)</b>	LO2	archipoint-powercore-rgb-	501	28.5	0.850
		translucent-dome-lens-itl72766			
$\blacksquare$	LO1b	F080-1S-HO-30-8-E2	583	11.5	0.850
$\overline{\mathbb{H}}$	LO1a	F080-1S-MO-30-8-40	731	7.5	0.850

Calculation Summary							
Scenario: All On							
Label	Calc Type	Units	Avg	Max	Min	Avg/Min	Max/Mir
Bridge	Illuminance	Fc	0.90	1.4	0.3	3.00	4.67
Fin Surface	Illuminance	Fc	1.64	2	0	N.A.	N.A.
Letter M_1	Illuminance	Fc	11.10	13.9	6.9	1.61	2.01
Letter M_2	Illuminance	Fc	8.93	11.1	6.3	1.42	1.76
Plaza_Plaza	Illuminance	Fc	1.03	2.6	0.1	10.30	26.00
Round Sidewalk_Sidewalk 1	Illuminance	Fc	1.84	4.0	0.1	18.40	40.00
Sidewalk Sidewalk 2	Illuminance	Fc	1.07	3.4	0.0	N.A.	N.A.

## NOTES:

MATERIAL REFLECTANCE: 30
 LIGHT LEVELS TAKEN AT GRADE.
 TYPICAL LLF = .85 LLD


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JUNE 2025

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PHOTOMETRICS



Kathi Vandel
Engineer
License No.:
E-2000147833

DWG NO.: E103

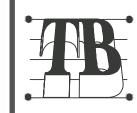