

ADDENDUM NUMBER 2

Project Number CMAQ 3319(412), City Project 70171305
Project Title I-35 and Chouteau Parkway

Interchange Improvements

ISSUE DATE: 11/12/2020

Bidders are hereby notified that the Bidding and Contract Documents for the above project, for which Bids are to be received on **November 18, 2020**, are amended as follows:

<u>Information to Bidders</u> The following is provided to Bidders for information only:

- 1. Agenda of the pre-bid conference meeting held on November 4, 2020 are provided.
- 2. Updated utility information related to existing and proposed Evergy systems are shown on sheet

Q1.	Bid Item No. 15, 672 LF Concrete Safety Barrier (Type C Pier Protection), will the wall be measured for payment along each fact (traffic and trail sides).
A1.	The safety barrier is measured along the back of each wall (refer to spec section 03617). There is a total of four safety barriers.
Q2.	Bid Item No. 15, 672 LF Concrete Safety Barrier (Type C Pier Protection), can the City provide a plan view that details the beginning and ending station for the Type C Pier Protection.
A2.	Start and stop stations have been added to sheet 10 and sheet 12. A note has been added to detail 1 and detail 2 on sheet 36 describing the height transition distance and requirements.
Q3.	The unit prices bid form is different in the spec versus the excel file that is upload on the KCMO plan room in the "bid packet" folder.
A3.	Section 00412 Unit Prices is to be replaced with the attached revised document.
Q4.	Sheet 21 call for a "Decorative Iron Fence" on top of the walls and refers to the specifications. The specifications have several styles of fences described but not a decorative iron fence. This is not enough information to be able to bid the fence correctly. Please specify a particular fence or equal, or otherwise give us more direction.
A4.	Specification section 02308 Fencing is to be replaced with the attached revised documents. The intent of the fencing is to match existing fencing located along the south side of Chouteau Parkway east of NE Parvin Road.

Q5.	It appears that the large block retaining wall bid quantity is reflecting all square feet of face instead of just "exposed face" which is the typical measurement and payment method. Please verify.
A5.	Measurement and payment of the large block retaining walls is from the bottom of the bottom row of blocks to the top of the cap block. Refer to section 02837 Large Block Retaining Wall.
Q6.	Plan Sheet 36 of 102, Sections 1 & 2 show what appears to be a footing directly beneath the Type C Barrier. Is this to be included in the bid item for type C wall? If so can you please provide the dimensions and reinforcing details.
A6.	The concrete pavement under the concrete safety barrier is subsidiary to the Concrete Safety Barrier bid item. Dimensioning and reinforcing details have been added to detail 1 and detail 2 on sheet 36.
Q7.	MoDOT Standard 617.10K does not show any reinforcing steel in the Type C
	wall, however, MoDOT has been known to require steel at pier protection
	locations. Can you confirm the reinforcing requirements at the Type C Pier
	Protection?
A7.	Reinforcing details and requirements are shown on MoDOT drawing 617.10M (sheet 3 of 11).
Q8.	Plan sheet 21 of 102 note 3 of the retaining wall calls out a fence on top of the wall. Is this correct?
A8.	Fencing is required on top of retaining walls. Fencing is subsidiary to the Large Block Retaining Wall bid item.
Q9.	Plan sheet 36 of 102 shows a fence on top of the concrete barrier. Is this
	correct, and if so what type of fence and how is it paid for?
A9.	Fencing is required on top of concrete barrier wall as shown on detail 1
	and detail 2 on sheet 36. Additional fencing information has been added
	to these details. Refer to attached revised section 02308 Fencing. The
	to these details. Refer to attached revised section 02308 Fencing. The intent of the fencing is to match existing fencing located along the south
010	to these details. Refer to attached revised section 02308 Fencing. The intent of the fencing is to match existing fencing located along the south side of Chouteau Parkway east of NE Parvin Road.
Q10.	to these details. Refer to attached revised section 02308 Fencing. The intent of the fencing is to match existing fencing located along the south side of Chouteau Parkway east of NE Parvin Road. The quantity of Type 2 Rock Blanket appears to be in error based on our
Q10.	to these details. Refer to attached revised section 02308 Fencing. The intent of the fencing is to match existing fencing located along the south side of Chouteau Parkway east of NE Parvin Road.

Bidding Requirements

1. N/A

Contracting Requirements

1. N/A

Specifications

- 1. Replace 00412 Unit Prices in its entirety.
- 2. Replace 02308 Fencing in its entirety.

Drawings: Replace the following drawings

- 1. Sheet 3 General Notes, Legend, & Summary of Roadway Quantities
- 2. Sheet 8: NE Chouteau Parkway Plan & Profile
- 3. Sheet 10: NE Chouteau Parkway Plan & Profile
- 4. Sheet 12: NE Chouteau Parkway Plan & Profile
- 5. Sheet 36: Roadway Details

NOTE: Bidders must acknowledge receipt of this Addendum by listing the number and date, where provided, on the Bid Form - Document 00410.

Bidder:

UNIT PRICES

Project Number CMAQ 3319(412), City Project 70171305-ADDENDUM 2

NOTE: IN THE EVENT OF DISCREPANCY, UNIT PRICE SHALL GOVERN.

Item No.	Unit	Quantity	Item Description:	Unit Price	Extension
ROADV	VAY				
1	LS	1	Mobilization		
2	LS	1	Contractor Furnished Surveying		
3	AC	3.3	Clearing, Grubbing, & Demolition		
4	CY	4489	Unclassified Excavation		
5	CY	59	Embankment		
6	SY	8857	Subgrade Stablization (9", Fly Ash and Compaction)		
7	SY	8704	Untreated Compacted Aggregate (6" - Roadway)		
8	SY	2048	Untreated Compacted Aggregate (4" - Median & Sidewalk)		
9	SY	2928	Milling & Overlay (2")		
10	SY	7574	Asphaltic Concrete Base: RC-Type 1-01 (8" - Roadway)		
11	SY	7574	Asphaltic Concrete Surface: Type 5-01 (2" - Roadway)		
12	SY	598	Asphaltic Concrete Base: RC-Type 1-01 (4" - Roadway)		
13	LF	2396	Concrete Curb & Gutter (Type CG)		
14	LF	615	Concrete Curb (Type C)		
15	LF	672	Concrete Safety Barrier (Type C Pier Protection)		
16	VSF	2165	Large Block Retaining Wall		
17	SY	266	Concrete Median (4")		
18	SY	550	Concrete Median (4") (Stamped & Colored)		
19	SY	1431	Concrete Multi Use Trail (6")		
20	SY	209	Concrete Sidewalk Ramp		
21	SY	341	Type 2 Rock Blanket		
22	EA	1	KCMO Type 1 Curb Inlet (5'x4')		
23	EA	1	KCMO Type 1 Curb Inlet (8'x4')		
24	EA	1	KCMO Type 2 Curb Inlet (5'x4')		
25	EA	1	KCMO Junction Box (4'x4')		
26	EA	4	MODOT Type A Drop Inlet (2'x2')		
27	EA	2	MODOT Type S Drop Inlet (5'x3')		
28	EA	1	MODOT Type E Drop Inlet (4'x4')		
29	LF	28	12" RCP (Class III)		
30	LF	30	15" RCP (Class III)		
31	LF	9	18" RCP (Class III)		
32	EA	2	MoDOT Type A Pipe Collar		
33	EA	1	Connect to Existing RCB		
34	EA	1	Connect to Existing Storm Sewer Structure		
35	EA	13	Curb/Drop Inlet Protection		
36	EA	5	Tree Protection		
37	EA	2	Culvert Inlet Protection		
38	EA	2	Project Information Signs		

Bidder:

Item No.	Unit		Item Description:	Unit Price	Extension
TEMPO	RARY TRAF	FIC CONT	ROL		-
39	EA	7	Temporary Sign, G020-1D		
40	EA	9	Temporary Sign, G020-2		
41	EA	21	Temporary Sign, W020-1		
42	EA	2	Temporary Sign, W020-2D		
43	EA	4	Temporary Sign, W20-5L		
44	EA	1	Temporary Sign, W20-5R		
45	EA	3	Temporary Sign, W4-2R		
46	EA	3	Temporary Sign, W4-2L		
47	EA	2	Temporary Sign, W9-3T		
48	EA	1	Temporary Sign, W20-5R		
49	EA	1	Temporary Sign, R1-1		
50	EA	3	Temporary Sign, R1-2		
51	EA	8	Temporary Sign, R2-1		
52	EA	2	Temporary Sign, R3-1		
53	EA	1	Temporary Sign, R3-2		
54	EA	2	Temporary Sign, R3-4		
55	EA	2	Temporary Sign, R3-5L		
56	EA	4	Temporary Sign, R3-7L		
57	EA	1	Temporary Sign, R3-7R		
58	EA	3	Temporary Sign, R4-7		
59	EA	3	Temporary Sign, R11-2		
60	EA	16	Temporary Sign, M1-4		
61	EA	1	Temporary Sign, M6-3		
62	EA	5	Temporary Sign, M6-1		
63	EA	3	Temporary Sign, M5-1L		
64	EA	16	Temporary Sign, M3-1		
65	EA	9	Temporary Sign, M4-8		
66	EA	2	Temporary Sign, M04-8a		
67	EA	4	Temporary Sign, CW6-3		
68	EA	2	Temporary Sign, CW12-1		
69	EA	3	Temporary Sign, E5-2a		
70	EA	500	Channelizers		
71	LF	6750	Temporary Pavement Marking - Striping		
72	LF	72	Temporary Pavement Marking - Stop Bar		
73	LF	465	Pavement Marking Removal - Striping		
74	LF	68	Pavement Marking Removal - Stop Bar		
75	EA	10	Type III Barricades		
76	EA	3	Changeable Message Signs		
SIGNAC	SE .	!			
77	SF	560	Flat Sheet Sign		
78	EA	28	Sign Post		
79	EA	2	Tubular Support - Type S-1312 (70'-0" Span)		
	l	1	1		

Bidder:

Item No.	Unit	Quantity	Item Description:	Unit Price	Extension
	ENT MARKII			13	
80	LF	3,200	Preformed Thermoplastic Pavement Marking, 4 In. White		
81	LF	1,160	Preformed Thermoplastic Pavement Marking, 4 In. Yellow		
82	LF	950	Preformed Thermoplastic Pavement Marking, 6 In. White		
83	LF	800	Preformed Thermoplastic Pavement Marking, 12 In White (Crosswalks)		
84	LF	40	Preformed Thermoplastic Pavement Marking, 12 In. Yellow		
85	LF	290	Preformed Thermoplastic Pavement Marking, 24 In. White		
86	EA	22	Preformed Thermoplastic Pavement Marking, Yield Line Triangles		
87	EA	16	Preformed Thermoplastic Pavement Marking, Left Arrow		
88	EA	6	Preformed Thermoplastic Pavement Marking, Right Arrow		
89	EA	2	Preformed Thermoplastic Pavement Marking, Thru Arrow		
ITS				1	
90	LF	572	Conduit (3") Pushed		
91	LF	629	Conduit (3") Trench		
92	LF	761	Fiber Single Mode		
93	EA	4	Service Box (KCMO Type II)		
TRAFFI	C SIGNALS	- CHOUTE	AU & I-35	1	
94	LS	1	Cabinet, Controller, Conflict Monitor		
95	LS	1	Electric Service		
96	EA	3	Pedestal Poles (10')		
97	EA	1	Type CL - Mast Arm (35')		
98	EA	1	Type CL - Mast Arm (48')		
99	EA	1	Type BL - Mast Arm (42')(32')		
100	EA	1	Type BL - Mast Arm (50')(30')		
101	EA	4	Signal Pole Foundation		
102	EA	3	Pedestal Pole Foundation		
103	EA	1	Pull Box (Class 1)		
104	EA	2	Pull Box (Class 2)		
105	EA	5	Pull Box (Class 3)		
106	EA	9	Ground Rods (1/2" x 10') w/ clamps		
107	LF	96	Conduit (2") Trench		
108	LF	40	Conduit (3") Trench		
109	LF	187	Conduit (3") Pushed		
110	LF	262	Conduit (4") Trench		
111	LF	235	Conduit (4") Pushed		
112	LF	144	Cable (1c#2)		
113	LF	1917	Cable (3c#10)		
114	LF	1138	Cable (2c#16)		
115	LF	1138	Cable (5c#16)		
116	LF	4814	Cable (7c#16)		
117	LF	2000	Cable (COAX)		
118	LF	2000	Cable (3c#16)		
119	LF	4	Accessible Pedestrian Push Button Assembly		
120	LS	1	Radar Detection System		
121	EA	4	Pedestrian Countdown Heads		
122	EA	13	Vehicle Signal Heads (3 Section - 12")		
123	EA	2	Vehicle Signal Heads (4 Section - 12")		

Bidder:

Item No.	Unit	Quantity	Item Description:	Unit Price	Extension
124	EA	6	Illuminated Street Name Sign	G	ZXIONON
125	LS	1	Paint Poles		
126	EA	4	Signs (Mast arm mounted)		
127	EA	4	Signs (Pedestrian crossing)		
128	LS	1	Remove Existing Equipment (I-35)		
TRAFFI	C SIGNALS	- CHOUTE	AU & CLEVELAND		
129	EA	1	Pad Mounted Cabinet Assembly Housing, Controller w/ Software and Accessories and BBS/UPS		
130	EA	4	Pedestal Poles (10')		
131	EA	4	Signal Poles (32'-6")		
132	EA	2	Mast Arm (28')		
133	EA	1	Mast Arm (30')		
134	EA	1	Mast Arm (38')		
135	EA	4	Luminaire Arm LED		
136	EA	5	Service Box (Type I)		
137	EA	1	Service Box (Type II)		
138	EA	4	Signal Pole Foundation		
139	EA	4	Pedestal Pole Foundation (10')		
140	EA	1	Controller Base (Type P)		
141	LF	410	Conduit (2")		
142	LF	140	Conduit (3")		
143	LF	400	Conduit (4")		
144	LF	100	Conduit (2") - Power		
145	LF	20	Conduit (3") - Power		
146	LF	100	Cable (1c#6, ground)		
147	LF	1292	Cable (2c#14)		
148	LF	1402	Cable (5c#14)		
149	LF	1475	Cable (7c#14)		
150	LF	100	Cable (#4 AWG, service power)		
151	LF	1480	Video Cable (PTZ)		
152	LF	740	6c (radar cable)		
153	LF	740	2-1c#14 (IISNS)		
154	LF	762	M-138 (Opticom)		
155	EA	7	Accessible Pedestrian Push Button Assembly		
156	EA	740	Radar Cable		
157	EA	4	Radar Detection		
158	EA	8	Pedestrian Countdown Heads		
159	EA	14	Vehicle Signal Heads (3 Section - 12")		
160	EA	4	IISNS (relocated)		
161	EA	7	Signs (Pedestrian crossing)		
162	EA	8	Ground Rods (1/2" x 10') w/ clamps		
163	EA	1	Remove Existing Signal		

Item No.	Unit	Quantity	Item Description:	Unit Price	Extension
STREET	Γ LIGHTING				
164	EA	17	Type "A" Phillips Gardco LED LED Light Fixture		
165	EA	17	Type "A" Pole 35'-0" Mounting Height		
166	EA	1	Type "B" Phillips Gardco LED Light Fixture (Twin) On Traffic Signal Pole		
167	EA	4	Type "C" Lithonia 400 watt HPS on MoDOT Traffic Signal Pole		
168	EA	2	Type "D" Phillips Gardco LED Light Fixture On MoDOT Traffic Signal Pole		
169	EA	8	Underpass Light Fixture Type "F" 39 Watt LED		
170	EA	4	Underpass Light Fixture Type "E" 73 Watt LED		
171	LF	2500	#10 RHW/USE Internal Pole Wire		
172	LF	750	2 #8 RHH/RHW/USE, 1 #8 CU GND., 2CID		
173	LF	2250	2 #4 RHH/RHW/USE, 1 #4 CU GND., 2CID		
174	EA	50	Fuse Kits		
175	EA	25	Non-Fused Fuse Kits		
176	EA	17	Cable Retainers		
177	EA	17	Lighting Screw in Pole Base		
178	EA	33	ID Tags		
179	EA	17	Pull Box		
180	EA	8	12"x12"x6" Weatherproof Junction Box		
181	LF	3000	Trench and Backfill		
182	LS	1	Removal of Luminaire, Arm, and Metal Pole (Qty. 26)		
LANDS	CAPING				
183	SY	1791	Sod		
184	EA	10	Ornamental Tree (1.5" Caliper)		
185	EA	5	Street Tree (2.5" Caliper)		
186	EA	179	Shrub (5 Gallon)		
187	EA	33	Grass (3 Gallon)		
188	EA	69	Grass (1 Gallon)		
189	LF	950	Cultivated Landscape Edge		
190	SF	6665	Hardwood Mulch (3" Thick)		
			Total Unit Prices: (LAST PAGE ONLY)		•
			•		

Note: May be printed, for manual fill-in, or filled in on electronic excel spreadsheet version.





Pre-Bid Meeting Agenda

I-35 and Chouteau Parkway Interchange Improvements Federal Project No.: CMAQ 3319(412) City Project No.: 70171305

I. Introductions

- James Wang, P.E., KCMO Parks & Recreation, City Project Manager
- Rebecca Martinez, KCMO Parks & Recreation, Contract Administration
- Mike Haake, P.E., Walter P Moore, Consulting Engineer
- TranSystems

II. Project Scope & Overview

- Roadway widening for traffic & pedestrians
- Full depth reconstruction and mill & overlay
- MoDOT cost share
- KCMO Public Works, KCMO Parks & Recreation, & MoDOT requirements.

III. Utility Information

- Refer to Section 20070 for contact information
- Evergy: Currently relocating equipment at northwest corner of Chouteau & Cleveland.
- Google: One vault at southwest corner of Chouteau & Cleveland.
- AT&T: Currently relocating one vault at northeast corner of Chouteau & Cleveland.

IV. General Requirements

- Bid Opening: 2pm, November 18th, 2020
- Notice to Proceed: Anticipated March/April of 2021
- Calendar days: 329 days
- Liquated Damages: Refer to Section 00210
- Prevailing Wage project
- Addendum to be posted no later than November 13th, 2020.

V. Traffic / Construction Phasing

- Limited duration of I-35 ramp closures. Refer to Section 00210 for durations and liquated damages.
- Maintain continuous traffic along Chouteau throughout construction
- Temporary traffic control signage & equipment will be required.
- Construction phasing shown on plans. Changes to the plans are to be pre-approved and meet requirements described on plans.

VI. Questions?

02308 FENCING

A. GENERAL

All the requirements of the Kansas City Metropolitan Chapter of the American Public Works Association (APWA), *Standard Specifications and Design Criteria* apply as amended and supplemented by the Department of Public Works of the City of Kansas City, Missouri (KCMO). Sections of said Specifications will be hereinafter referred to as "APWA-KCMO." The City's current standards can be found online under the Kansas City Public Works Department website under "Public Works Design & Construction Standards:" http://kcmo.gov/publicworks/design-construction-standards/

Fencing shall conform to <u>APWA-KCMO Section 2308</u> with the following modifications, deletions, or additions. All provisions that are not so amended, removed, or supplemented remain in full force and effect.

1. Section 2308.2 shall be replaced with the following:

Materials:

- A. **Black Decorative Fencing:** Black powder coated galvanized steel with 3/4" square railings & pickets, 42" picket height, 3-rail system with top rail, commercial rated, conforming to ASTM A653. All fencing materials and styles on the project shall match.
- 2. Section 2308.3 shall be replaced with the following:

Construction Details:

- A. Fencing shall be installed at the locations shown on the plans or as directed by the Engineer.
- B. Retaining wall fencing installation, details, and anchoring systems shall be coordinated with retaining wall block manufacturer, Contractor's retaining wall engineer, and shown on retaining wall shop drawings.
- C. Concrete safety barrier fencing installation, details, and anchoring systems shall be coordinated with concrete safety barrier and is the responsibility of Contractor.
- D. Installation of fencing shall be in accordance with the recommendations and requirements of the fencing manufacturer and approved shop drawings.
- 3. Section 2308.4 shall be replaced with the following:

Measurement and Payment:

A. No separate measure and payment will be made for fencing. All work associated with fencing is subsidiary to other bid items.

END OF SECTION

GENERAL NOTES:

- THE CONSTRUCTION COVERED BY THESE PLANS SHALL CONFORM TO THE CURRENT "CITY STANDARDS" AND SPECIFICATIONS OF THE PARKS & RECREATION DEPARTMENT, KANSAS CITY, MISSOURI, EXCEPT AS NOTED.
- 2. ALL WORK WITHIN THE MODOT ROW SHALL CONFORM TO THE REQUIREMENTS OF THE 2020 MISSOURI STANDARD SPECIFICATIONS FOR HIGHWAY CONSTRUCTION UNLESS OTHERWISE NOTED IN THE PLAN AND/OR PROJECT SPECIFICATIONS.
- 3. THIS PROJECT WAS BASED ON BOUNDARY AND TOPOGRAPHIC SURVEY PROVIDED LOVELACE AND ASSOCIATES.
- 4. ALL MANHOLES, CATCH BASINS, UTILITY VALVES, AND METER PITS SHALL BE ADJUSTED OR REBUILT TO GRADE AS REQUIRED.
- 5. ASPHALTIC CONCRETE SURFACE COURSE SHALL CONTAIN ONLY VIRGIN MATERIALS. BASE COURSE MAY CONTAIN RECYCLED CONTENT.
- 6. IT SHALL BE THE RESPONSIBILITY OF THE CONTRACTOR TO CONTROL DOWNSTREAM EROSION AND SILTATION DURING ALL PHASES OF CONSTRUCTION. EROSION CONTROL SYSTEMS AND PROCEDURES SHALL BE IN PLACE PRIOR TO ANY GRADING OPERATIONS.
- 7. PRIOR TO ORDERING PRE-CAST STRUCTURES, SHOP DRAWINGS ARE TO BE SUBMITTED TO THE DESIGN ENGINEER FOR APPROVAL.
- 8. THE CONTRACTOR SHALL BE RESPONSIBLE FOR RECORDING ROCK ELEVATIONS AT 25 FOOT (MAXIMUM) INTERVALS WHERE ENCOUNTERED, AND FURNISHING THIS INFORMATION TO THE DESIGN ENGINEER FOR USE ON "AS-BUILT" PLANS.
- 9. THE LOCATIONS OF EXISTING UTILITIES AS SHOWN ARE APPROXIMATE. IT SHALL BE THE RESPONSIBILITY OF THE CONTRACTOR TO VERIFY THE LOCATIONS OF ALL EXISTING UTILITIES.
- 10. SUBSURFACE EXPLORATION FOR THE DETERMINATION OF AND/OR THE LOCATION OF EXISTING ROCK HAS BEEN MADE AND IS INCLUDED IN THE PROJECT SPECIFICATIONS.
- 11. THE CITY OF KANSAS CITY, MISSOURI SHALL PROVIDE EARTHWORK AND MATERIAL TESTING SERVICES.
- 12. UTILITIES CROSSING PUBLIC STREETS SHALL CONFORM TO THE FLOWABLE FILL REQUIREMENTS AS PER THE REVISED STANDARD SPECIFICATIONS SECTION 2602.21; WITH SUPPLEMENT.
- 13. CONSTRUCTION STAKING SHALL BE PROVIDED BY THE CONTRACTOR AS OUTLINED IN THE SPECIFICATIONS.
- 14. CONTRACTOR SHALL CONTACT AND COORDINATE WITH APPROPRIATE UTILITY COMPANY FOR REMOVALS OR RELOCATIONS OF UNDERGROUND MAINS. UNDERGROUND SERVICE LINES AND ABOVE GROUND UTILITY APPURTENANCES (SUCH AS POWER POLES) SEEN OR UNSEEN WITHIN THE GRADING LIMITS THAT ARE IN CONFLICT WITH PROPOSED CONSTRUCTION.
- 15. ALL EXISTING ROADWAY SURFACES WITHIN THE GRADING LIMITS ARE TO BE REMOVED UNLESS INDICATED OTHERWISE.
- 16. ALL EXISTING STORM SEWER PIPE AND STRUCTURES SEEN OR UNSEEN WITHIN THE GRADING LIMITS SHALL BE REMOVED UNLESS INDICATED ON PLANS TO REMAIN.
- 17. ALL EXISTING DRIVEWAYS WITHIN THE GRADING LIMITS ARE TO BE REMOVED AND REPLACED AS INDICATED ON THE PLANS.
- 18. ALL EXISTING SIDEWALKS WITHIN THE GRADING LIMITS ARE TO BE REMOVED UNLESS INDICATED ON THE PLANS TO REMAIN IN PLACE.
- 19. ALL LANDSCAPING, INCLUDING SHRUBS, WITHIN THE GRADING LIMITS SHALL BE REMOVED AS NECESSARY FOR PROPOSED CONSTRUCTION UNLESS INDICATED ON THE PLANS TO LEAVE IN PLACE. SALVAGE ITEMS TO PROPERTY OWNERS AS REQUESTED.
- 20. SAWCUT EXISTING PAVEMENT, INCLUDING SIDEWALKS, FULL DEPTH WHERE IT MEETS NEW PAVEMENT.
- 21. CONTRACTOR SHALL RESET ALL PROPERTY SURVEY MONUMENTS, INCLUDING PROPERTY CORNERS, SECTION CORNERS, AND KCMO BENCHMARKS. DESTROYED OR REMOVED DUE TO CONSTRUCTION.
- 22. EXISTING WATER SERVICE LINES AND WATER MAINS WITHIN THE PROJECT LIMITS ARE TO BE PROTECTED. ALL WORK RELATED TO WATER MAINS AND WATER SERVICE LINES IS TO CONFORM TO THE STANDARD AND REQUIREMENTS OF THE CITY OF KANSAS CITY WATER SERVICES DEPARTMENT.
- 23. THE CONTRACTOR IS RESPONSIBLE FOR COMPLETING THE REMAINING PORTIONS OF THE STORM WATER POLLUTION PREVENTION PLAN (SWPPP) FOR WHICH HE IS RESPONSIBLE PRIOR TO CONSTRUCTION. THE CONTRACTOR IS RESPONSIBLE FOR MAINTAINING AND UPDATING THE SWPPP AS REQUIRED BY FEDERAL, STATE, AND CITY REGULATIONS. REFER TO PROJECT SPECIFICATION SECTION 01563 FOR ADDITIONAL INFORMATION.

TYPICAL ABBREVIATIONS

0	- AT	PC	_	POINT OF CURVATURE
&	- AND	PI	_	POINT OF INTERSECTION
ADA	- AMERICANS WITH DISABILITIES ACT	የ	_	PROPERTY LINE
APWA	- AMERICAN PUBLIC WORKS ASSOCIATION	PROP	_	PROPOSED
APPROX	- APPROXIMATE	PVC	_	POINT OF CURVATURE ON VERTICAL CUR
AWWA	- AMERICAN WATER WORKS ASSOCIATION	PVC		POLYVINYL CHLORIDE PIPE
BM	- BENCHMARK	PVT		POINT OF TANGENCY ON VERTICAL CURVI
CJ	- CONTROL JOINT	QTY		QUANTITY
Q	- CENTER LINE	R		RADIUS
СMР	- CORRUGATED METAL PIPE	RCAP		REINFORCED CONCRETE ARCH PIPE
CU FT	- CUBIC FEET	RCP		REINFORCED CONCRETE PIPE
CU YD	- CUBIC YARD	RE:	_	REFERENCE
DIA	- DIAMETER	REV	_	REVISION
DIP	- DUCTILE IRON PIPE	R/W	_	RIGHT OF WAY
DWG	- DRAWING	ROW		RIGHT OF WAY
EA	- EACH	RWE		RETAINING WALL EASEMENT
EL	- ELEVATION	SF		SQUARE FEET
EQ	- EQUAL	SSD		STOPPING SIGHT DISTANCE
ESMT	- EASEMENT	SY		SQUARE YARD
FH	- FIRE HYDRANT	STA		STATION
F_	- FLOW LINE	STD		STANDARD
ñ	- FEET	TCE	_	TEMPORARY CONSTRUCTION EASEMENT
K	- RATE OF VERTICAL CURVATURE	THRU	_	THROUGH
KCMO	- CITY OF KANSAS CITY MISSOURI	TYP	_	TYPICAL
LF	- LINEAR FEET	VC	_	VERTICAL CURVE
L/L	- LOT LINE	W/	_	WITH
MH	- MANHOLE	W/O		WITHOUT
MUTCD	- MANUAL ON UNIFORM TRAFFIC CONTROL DEVICES	WL	_	WATER LINE
NA	- NOT APPLICABLE	WM		WATER METER
NTS	- NOT TO SCALE	WWF		WIELDED WIRE FABRIC
=		** ** *		

SURVEY I FGEND

GRADING LEGEND

PROPOSED CONTOUR

--XXX-- - EXISTING CONTOUR

SURVEY	LEGEND		
•	SECTION CORNER	● MB	MAILBOX
0	PROPERTY CORNER	• FOM	FIBER OPTIC MARKER
•	BENCHMARK	₽ TL	TRAFFIC SIGNAL LIGHT
\triangle	CONTROL POINT	• BOL	BOLLARD
∘R/W Marker	RIGHT-OF-WAY MARKER		YARD LIGHT
O G-POLE	GUY POLE	• CW	CROSSWALK SIGNAL
ф тр	TELEPHONE POLE		SIGN
ϕ PP	POWER POLE	□ <i>A</i> / <i>C</i>	AC UNIT
☆ LP	LIGHT POLES	•GP	GATE POST
○E-Ped	ELECTRIC PEDESTAL	•GRD	GUARD POST
○T-Ped	TELEPHONE PEDESTAL	⊠RD	ROOF DRAIN
	ELECTRIC TRANSFORMER		MANHOLE (SAN., STORM, TEL.)
Ē	ELECTRIC MANHOLE		TREE (DIA.)
○CTV-Ped	CABLE TELEVISION PEDESTAL		PINE TREE (DIA.)
\downarrow	ANCHOR		BUSH
• CO	CLEANOUT	CITS	TORNADO SIREN
	SPRINKLER CONTROL VALVE	• WS	WATER SPIGOT
CV	COMMUNICATION VAULT	●FP	FLAG POLE
EV	ELECTRIC VAULT	₩P	WOOD POST
EB	ELECTRIC BOX	● <i>GP</i>	GOALPOST
SV	STREET LIGHT VAULT		TREE LINE
OEM	ELECTRIC METER	X	FENCE
OWM	WATER METER	OHP	OVERHEAD POWER LINE
OGM	GAS METER	OH-TEL	OVERHEAD TELEPHONE LINE
\otimes GV	GAS VALVE	OHP&T	OVERHEAD POWER & TELEPHONE LINE
$\otimes WV$	WATER VALVE	G	GAS LINE
	MONITORING WELL	W	WATER LINE
OGR	GAS REGULATOR	UGP	UNDERGROUND POWER
⊙ FH	FIRE HYDRANT	UGT	UNDERGROUND TELEPHONE
≪ FDC	FIRE DEPARTMENT CONNECTION	C	UNDERGROUND CABLE TELEVISION
(W)	WATER MANHOLE		

PLAN LEGEND:

XXX.XX TC	- TOP OF CURB ELEVATION		- APPROX. GRADING LIMITS
XXX.XX	- SPOT ELEVATION		- RIGHT OF WAY (R/W)
XXX.XX LC	- LIP OF CURB ELEVATION		- PROPERTY LINE (P/L)
XXX.XX G	- GUTTER ELEVATION		- STORM SEWER LINE
XXX.XX ME	- MATCH EXISTING ELEVATION	×	- REMOVE TREE OR SHRUB
XXX.XX TW	- TOP OF WALL ELEVATION	8	- PROTECT TREE OR SHRUB
XXX.XX BW	- BOTTOM OF WALL ELEVATION		- FULL DEPTH ASPHALT PAVEMI
XXX.XX HP	- HIGH POINT		- 2" MILL & OVERLAY
XXX.XX LP	- LOW POINT	4	- CONCRETE MULTI-USE TRAIL
[VVV]	DDODOCED CONTOLID		- COLORED & STAMPED MEDIAN



	• • •
_	PROPERTY LINE (P/L)
-	STORM SEWER LINE
-	REMOVE TREE OR SHRUB
_	PROTECT TREE OR SHRUB
-	FULL DEPTH ASPHALT PAVEMENT
_	2" MILL & OVERLAY
_	CONCRETE MULTI-USE TRAIL
_	COLORED & STAMPED MEDIAN

EMERGENCY UTILITY SERVICE NUMBERS

SUMMARY OF ROADWAY QUANTITIES

ITEM DESCRIPTION

Unclassified Excavation

Milling & Overlay (2")

Concrete Curb (Type C)

Large Block Retaining Wall

Concrete Multi Use Trail (6")

KCMO Type 1 Curb Inlet (5'x4')

KCMO Type 1 Curb Inlet (8'x4')

KCMO Type 2 Curb Inlet (5'x4')

MODOT Type A Drop Inlet (2'x2')

MODOT Type S Drop Inlet (5'x3')

MODOT Type E Drop Inlet (4'x4')

KCMO Junction Box (4'x4')

12" RCP (Class III)

15" RCP (Class III)

18" RCP (Class III)

Tree Protection

MoDOT Type A Pipe Collar

Connect to Existing RCB

Curb/Drop Inlet Protection

Culvert Inlet Protection

Project Information Signs

Connect to Existing Storm Sewer Structure

Concrete Sidewalk Ramp

Type 2 Rock Blanket

Concrete Median (4")

Contractor Furnished Surveying

Clearing, Grubbing, & Demolition

Concrete Curb & Gutter (Type CG)

Subgrade Stablization (9", Fly Ash and Compaction)

Untreated Compacted Aggregate (4" - Median & Sidewalk)

Asphaltic Concrete Base: RC-Type 1-01 (8" - Roadway)

Asphaltic Concrete Surface: Type 5-01 (2" - Roadway)

Asphaltic Concrete Base: RC-Type 1-01 (4" - Roadway)

Concrete Safety Barrier (Type C Pier Protection)

Concrete Median (4") (Stamped & Colored)

Untreated Compacted Aggregate (6" - Roadway)

Mobilization

Embankment

QUANTITY

3.3

4,489

59

8,857

8,704

2,048

2,928

7,574

7,574

598

2,396

615

672

2,165

266

550

1,431

209

341

28

30

13

2

UNIT

LS

LS

AC

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CY

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AT&T	1-800-246-8464
CENTURYLINK	1-800-283-4237
COMCAST	888-262-5101
GOOGLE FIBER NOC	1-866-954-1572
KCMO PARKS & RECREATION	816-513-7500
KCMO STREET AND TRAFFIC DIVISION	311, OR 816-513-0421
KCMO STREET LIGHTING/BLACK & MCDONALD	816-483-0257
KCMO WATER SERVICES DEPT DISPATCHER	311, OR 816-513-1313
KCMO WATER SERVICES POLLUTION CONTROL	311, OR 816-513-1313
KCP&L	1-888-544-4852
LEVEL 3	1-877-2LEVEL3
MAGELLAN MIDSTREAM PARTNERS LP	1-800-720-2417
MISSOURI GAS ENERGY	1-800-582-0000
MISSOURI DEPARTMENT OF TRANSPORTATION	1-888-275-6636
NKC SCHOOL DISTRICT	816-390-6998
SPRINT / ERICSSON	1-800-521-0579
SUREWEST	913-825-3000
TIME WARNER CABLE	1-866-967-7611
TW TELECOM	800-829-0420
UNITE PRIVATE NETWORKS	866-963-4237
VEOLIA ENERGY	816-889-4950
VERIZON COMMUNICATIONS INC.	1-800-624-9675
ZAYO	1-866-236-2824



Walter P Moore and Associates, Inc. 1100 Walnut, Suite 1825 Kansas City, Missouri 64106

816.701.2100 walterpmoore.com MO PE Corporation No. 1999141112

IN ASSOCIATION WITH

PROJECT NAME

NE CHOUTEAU PARKWAY TRAIL CONNECTION

KANSAS CITY, MISSOURI CITY PROJECT NO. 70171305 FEDERAL PROJECT NO.

CMAQ 3319(412)



NO. DATE SUBMITTALS 1 06/30/2017 MODOT COST SHARE 2 11/17/2017 MODOT REVIEW 3 12/22/2017 90% CDs 4 09/13/2019 FLOODPLAIN APPLICATION 5 12/13/2019 FINAL PLANS 6 05/27/2020 MODOT COMMENTS 7 11/12/2020 ADDENDUM #2

DESIGNED BY

REVIEWED BY D.L.B DRAWN BY

D.M.B. PROJECT NUMBER

M08-17001-00

27 MAY 2020 SHEET TITLE


GENERAL NOTES. LEGENDS, & SUMMARY OF ROADWAY **QUANTITIES**

SHEET NUMBER

3 OF 102

M.J.H.

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REFER TO STREET LIGHTING PLANS

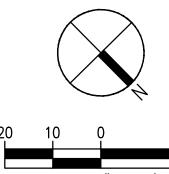2" MILL & OVERLAY

CONCRETE MULTI-USE TRAIL

CONCRETE MEDIAN

D.M.B.

PROJECT NUMBER

DATE

NO. DATE

1 06/30/2017

2 11/17/2017

3 12/22/2017

4 09/13/2019

5 12/13/2019

6 05/27/2020

7 11/12/2020

DESIGNED BY


REVIEWED BY

SHEET NUMBER


8 OF 102

M.J.H.

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REMOVE TREE OR SHRUB

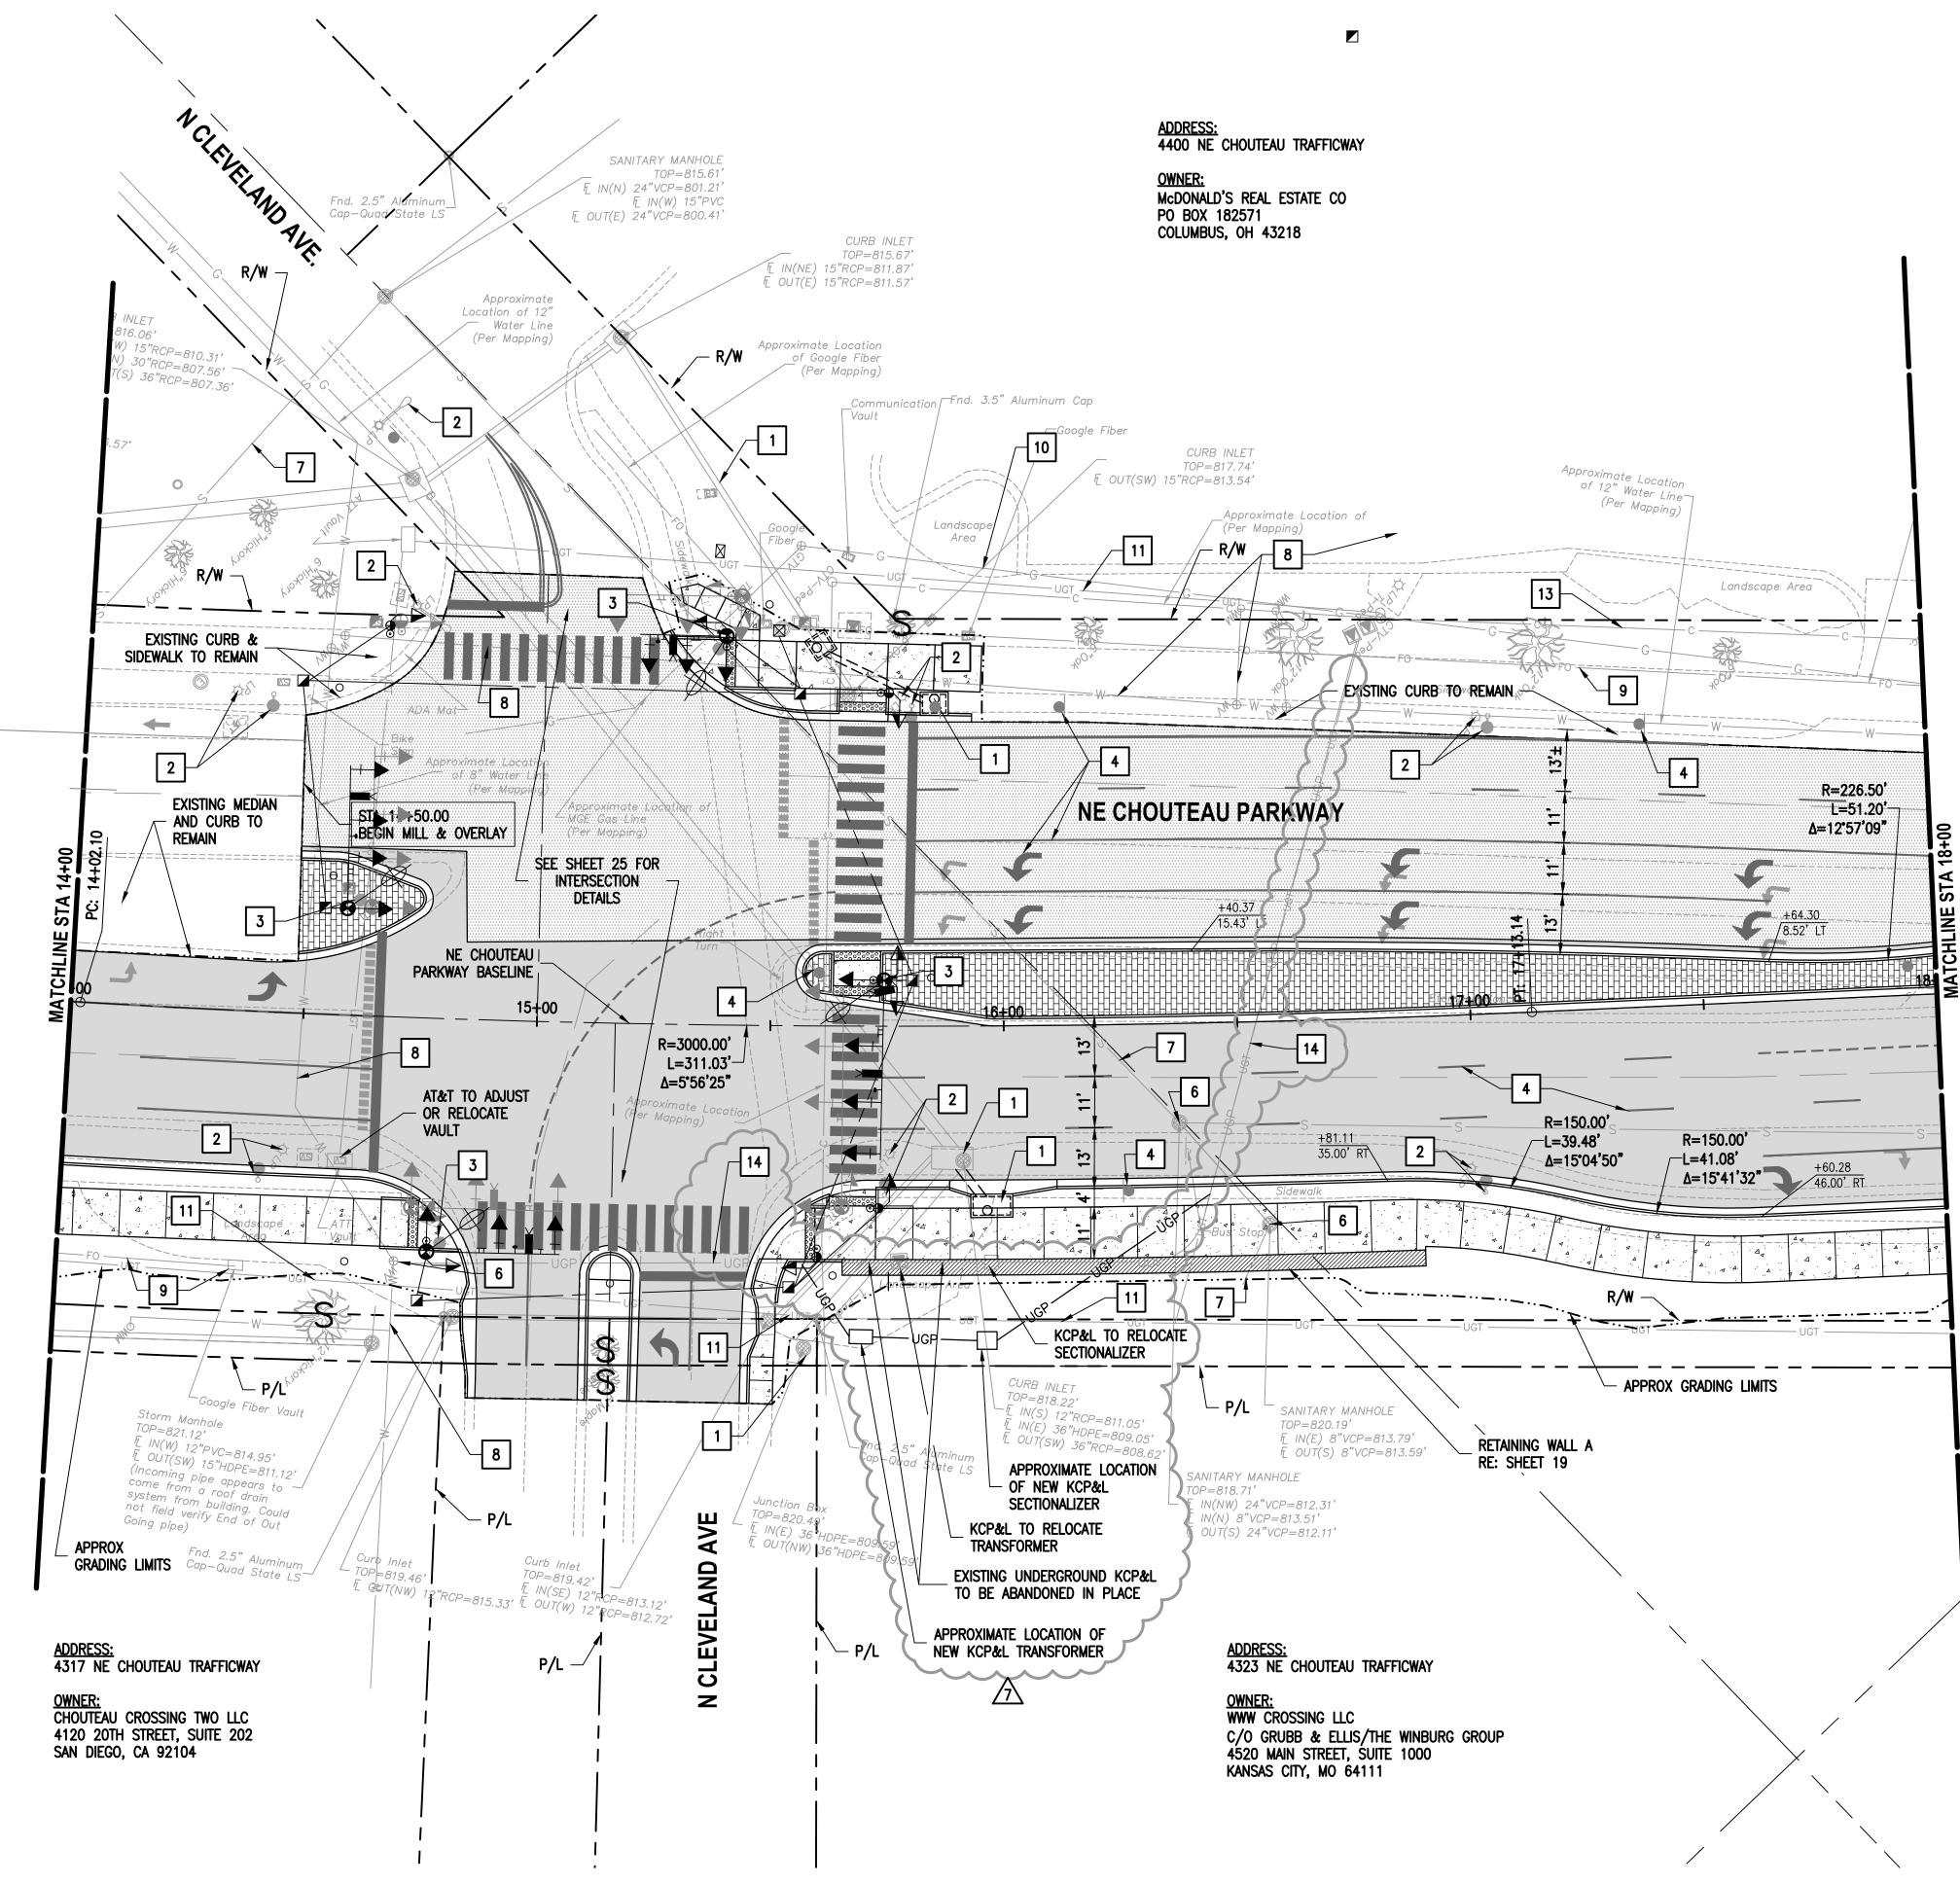S PROTECT TREE OR SHRUB

1 REFER TO STORM SEWER PLANS

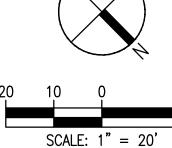REFER TO TRAFFIC SIGNAL PLANS

4 REFER TO PAVEMENT MARKING & SIGNAGE PLANS

5 REFER TO LANDSCAPE PLANS

9 EXISTING GOOGLE FIBER SYSTEM TO REMAIN UNDISTURBED

EXISTING CHARTER SYSTEM TO REMAIN UNDISTURBED

THE LOCATION, DEPTH AND SIZE OF EXISTING AND PROPOSED UTILITY SYSTEMS ARE SHOWN BASED ON THE BEST AVAILABLE INFORMATION AND MAY NOT BE ACCURATE. THE CONTRACTOR SHALL FIELD VERIFY EXISTING AND PROPOSED UTILITY SYSTEMS AND NOTIFY THE ENGINEER AND UTILITY COMPANY IN THE EVENT THERE IS A CONFLICT.

FULL DEPTH ASPHALT PAVEMENT

COLORED & STAMPED MEDIAN

KEYNOTES:

6 CONTRACTOR TO ADJUST TOP OF UTILITY STRUCTURE TO PROPOSED GRADE

7 EXISTING KCMO SANITARY SEWER SYSTEM TO REMAIN UNDISTURBED

8 EXISTING KCMO WATER LINE TO REMAIN UNDISTURBED

10 EXISTING MGE SYSTEM TO REMAIN UNDISTURBED

11 EXISTING AT&T SYSTEM TO REMAIN UNDISTURBED

12 EXISTING CENTURY LINK SYSTEM TO REMAIN UNDISTURBED

EXISTING KCP&L SYSTEM TO REMAIN UNDISTURBED

UTILITY NOTE:

PAVEMENT LEGEND:

D.L.B DRAWN BY

walter

Walter P Moore and Associates, Inc.

MO PE Corporation No. 1999141112

NE CHOUTEAU

CONNECTION

CITY PROJECT NO. 70171305

FEDERAL PROJECT NO.

KANSAS CITY, MISSOURI

MICHAEL

JOSEPH

HAAKE NUMBER

SUBMITTALS

90% CDs

FINAL PLANS

ADDENDUM #2

MODOT COST SHARE

MODOT COMMENTS

FLOODPLAIN APPLICATION

MODOT REVIEW

@ I-35

CMAQ 3319(412)

PARKWAY TRAIL

1100 Walnut, Suite 1825 Kansas City, Missouri 64106

p moore

816.701.2100

IN ASSOCIATION WITH


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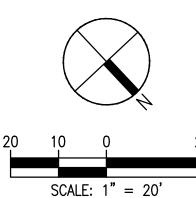
walterpmoore.com

M08-17001-00

27 MAY 2020 SHEET TITLE

PLAN - NE CHOUTEAU PARKWAY



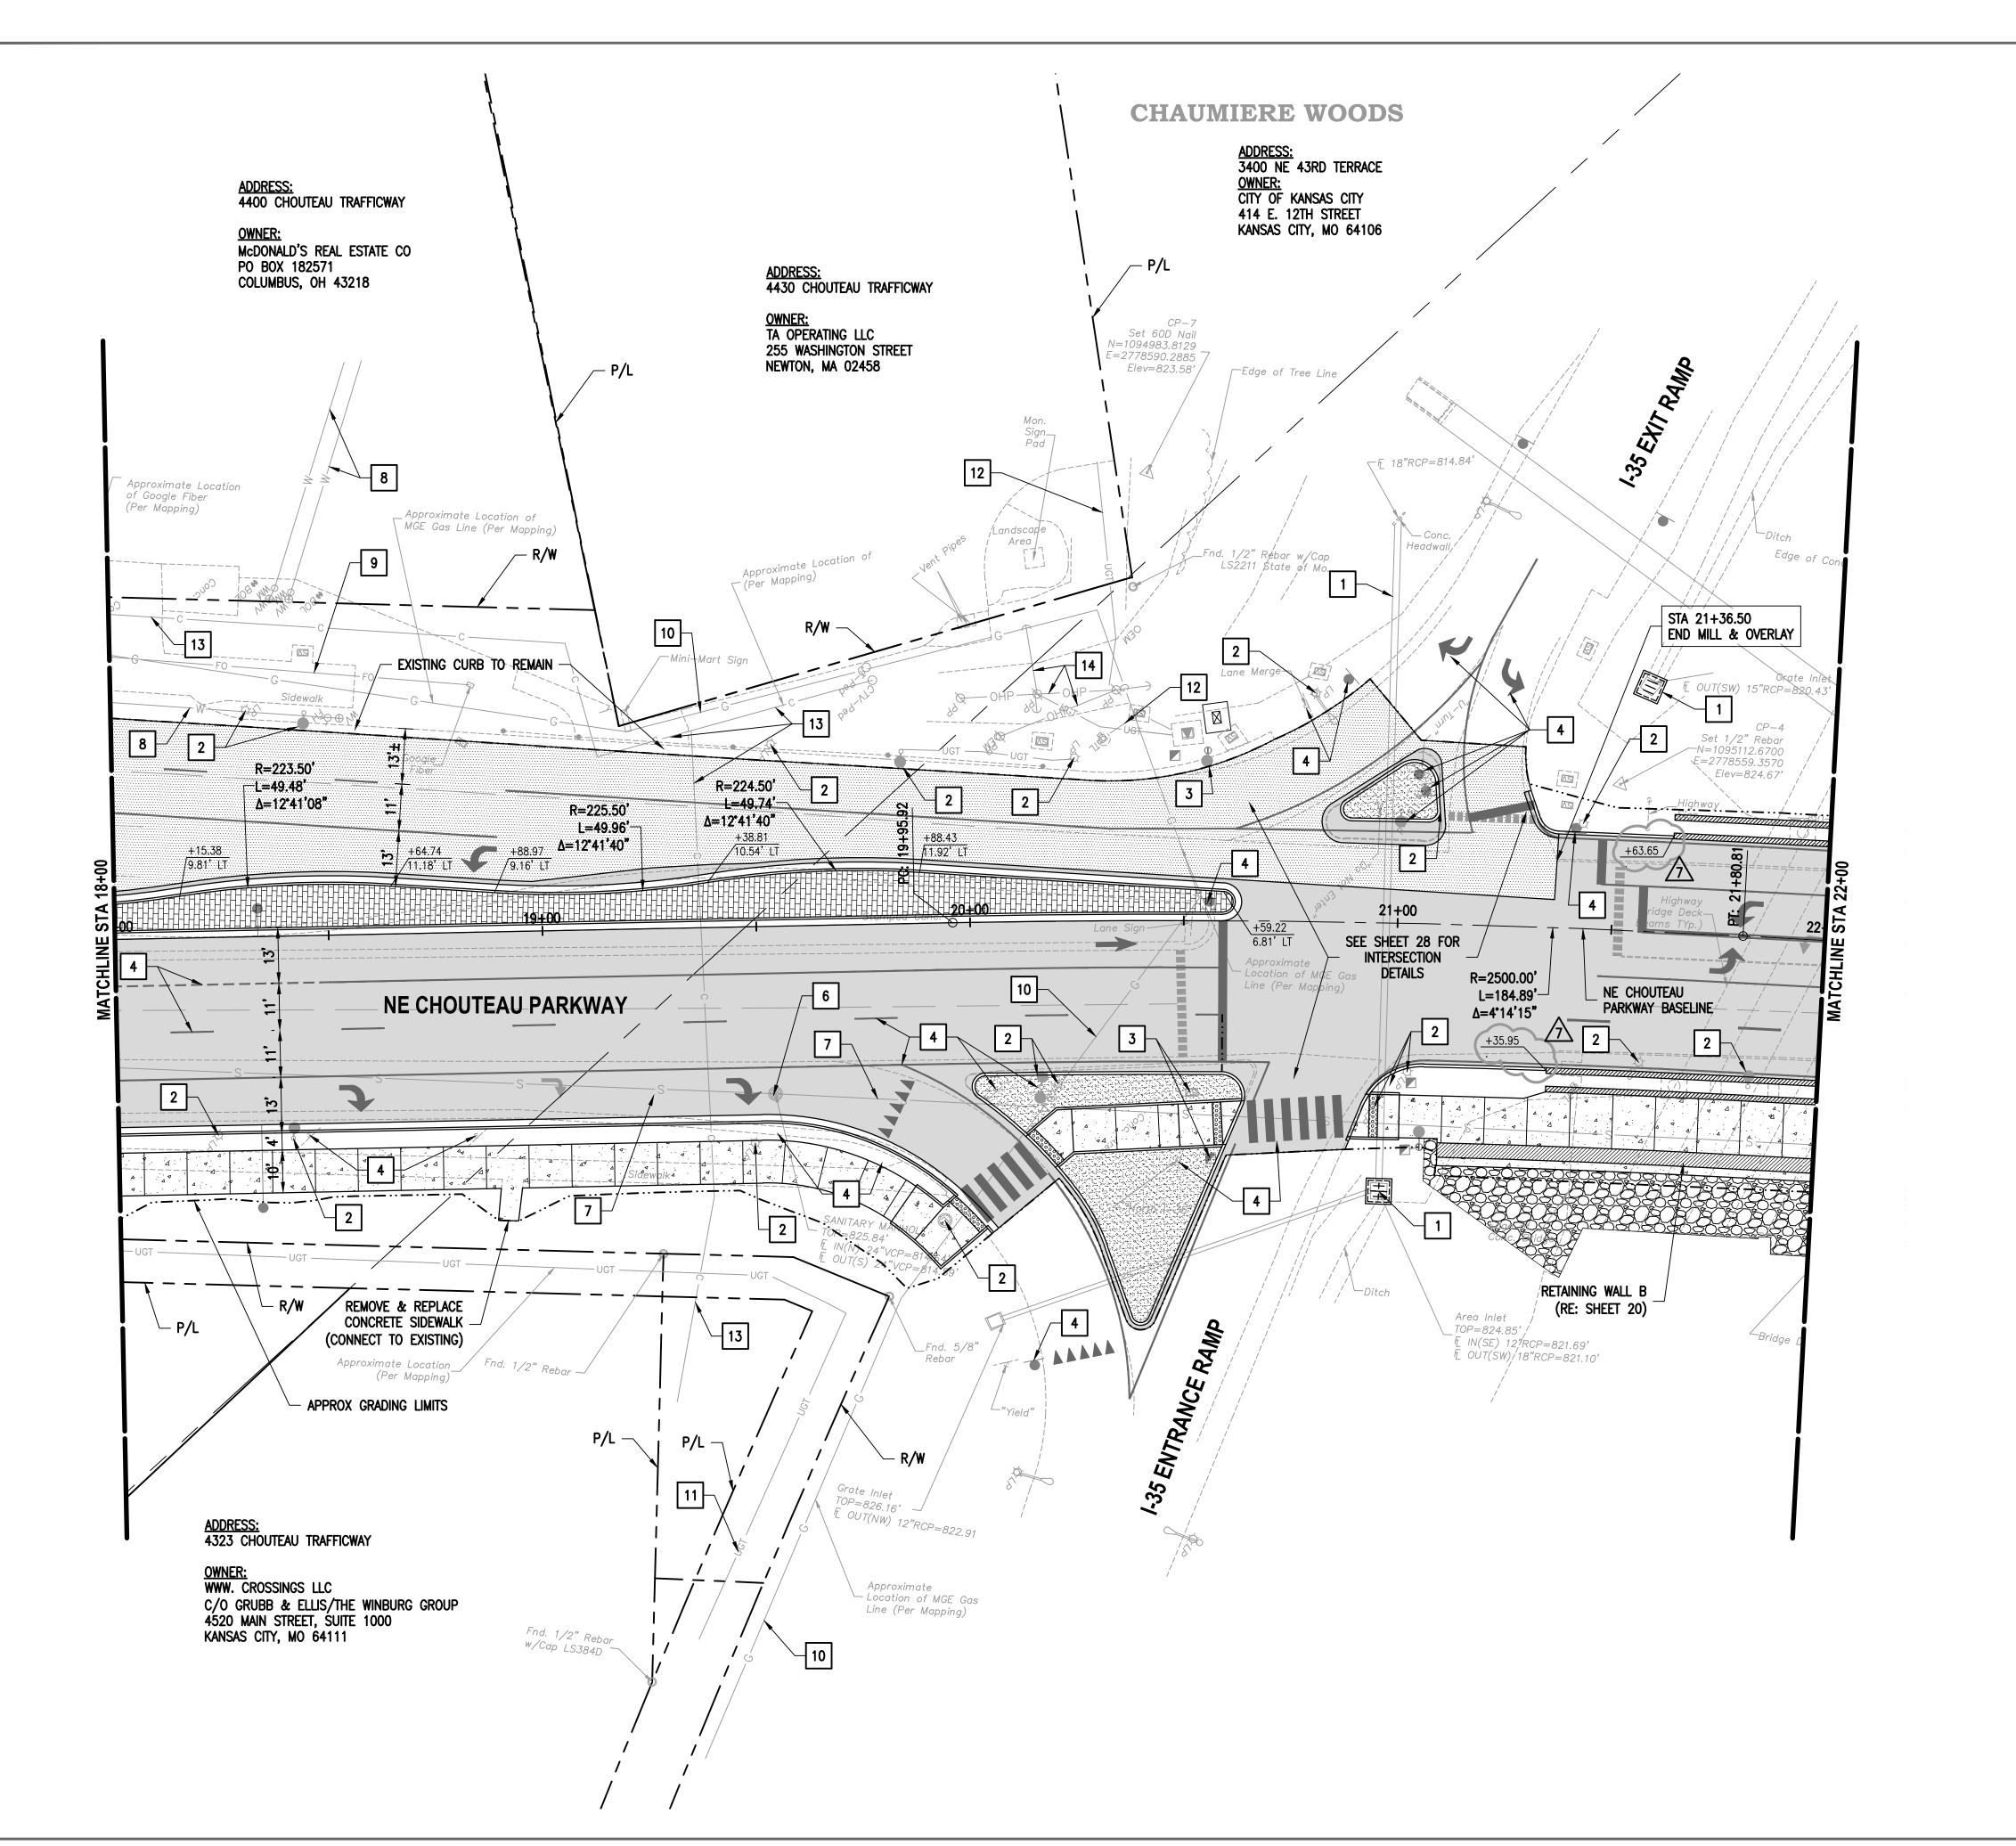

KEYNOTES:

REMOVE TREE OR SHRUB

S PROTECT TREE OR SHRUB

1 REFER TO STORM SEWER PLANS

2 REFER TO STREET LIGHTING PLANS

3 REFER TO TRAFFIC SIGNAL PLANS

REFER TO PAVEMENT MARKING & SIGNAGE PLANS

5 REFER TO LANDSCAPE PLANS

6 CONTRACTOR TO ADJUST TOP OF UTILITY STRUCTURE TO PROPOSED GRADE

7 EXISTING KCMO SANITARY SEWER SYSTEM TO REMAIN UNDISTURBED

8 EXISTING KCMO WATER LINE TO REMAIN UNDISTURBED

9 EXISTING GOOGLE FIBER SYSTEM TO REMAIN UNDISTURBED

10 EXISTING MGE SYSTEM TO REMAIN UNDISTURBED

EXISTING AT&T SYSTEM TO REMAIN UNDISTURBED

EXISTING CENTURY LINK SYSTEM TO REMAIN UNDISTURBED

REMAIN UNDISTURBED

EXISTING CHARTER SYSTEM TO REMAIN UNDISTURBED

EXISTING KCP&L SYSTEM TO REMAIN

EXISTING KCP&L SYSTEM TO REMAIN UNDISTURBED

UTILITY NOTE:

THE LOCATION, DEPTH AND SIZE OF EXISTING AND PROPOSED UTILITY SYSTEMS ARE SHOWN BASED ON THE BEST AVAILABLE INFORMATION AND MAY NOT BE ACCURATE. THE CONTRACTOR SHALL FIELD VERIFY EXISTING AND PROPOSED UTILITY SYSTEMS AND NOTIFY THE ENGINEER AND UTILITY COMPANY IN THE EVENT THERE IS A CONFLICT.

PAVEMENT LEGEND:

FULL DEPTH ASPHALT PAVEMENT

2" MILL & OVERLAY

COLORED & STAMPED MEDIAN

CONCRETE MEDIAN

CONCRETE MULTI-USE TRAIL

walter p moore

Walter P Moore and Associates, Inc. 1100 Walnut, Suite 1825 Kansas City, Missouri 64106

816.701.2100 walterpmoore.com MO PE Corporation No. 1999141112

IN ASSOCIATION WITH

PROJECT NAME

NO. DATE

NE CHOUTEAU PARKWAY TRAIL CONNECTION

L-35KANSAS CITY, MISSOURI
CITY PROJECT NO. 70171305
FEDERAL PROJECT NO.
CMAQ 3319(412)



SUBMITTALS

1 06/30/2017	MODOT COST SHARE
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5 12/13/2019	FINAL PLANS
6 05/27/2020	MODOT COMMENTS
7 11/12/2020	ADDENDUM #2
DESIGNED BY	
	M.J.H.
REVIEWED BY	
	D.L.B
DRAWN BY	
	D.M.B.
PROJECT NUMBER	

PLAN - NE CHOUTEAU PARKWAY

SHEET NUMBER


DATE

SHEET TITLE

10 OF 10

M08-17001-00

27 MAY 2020

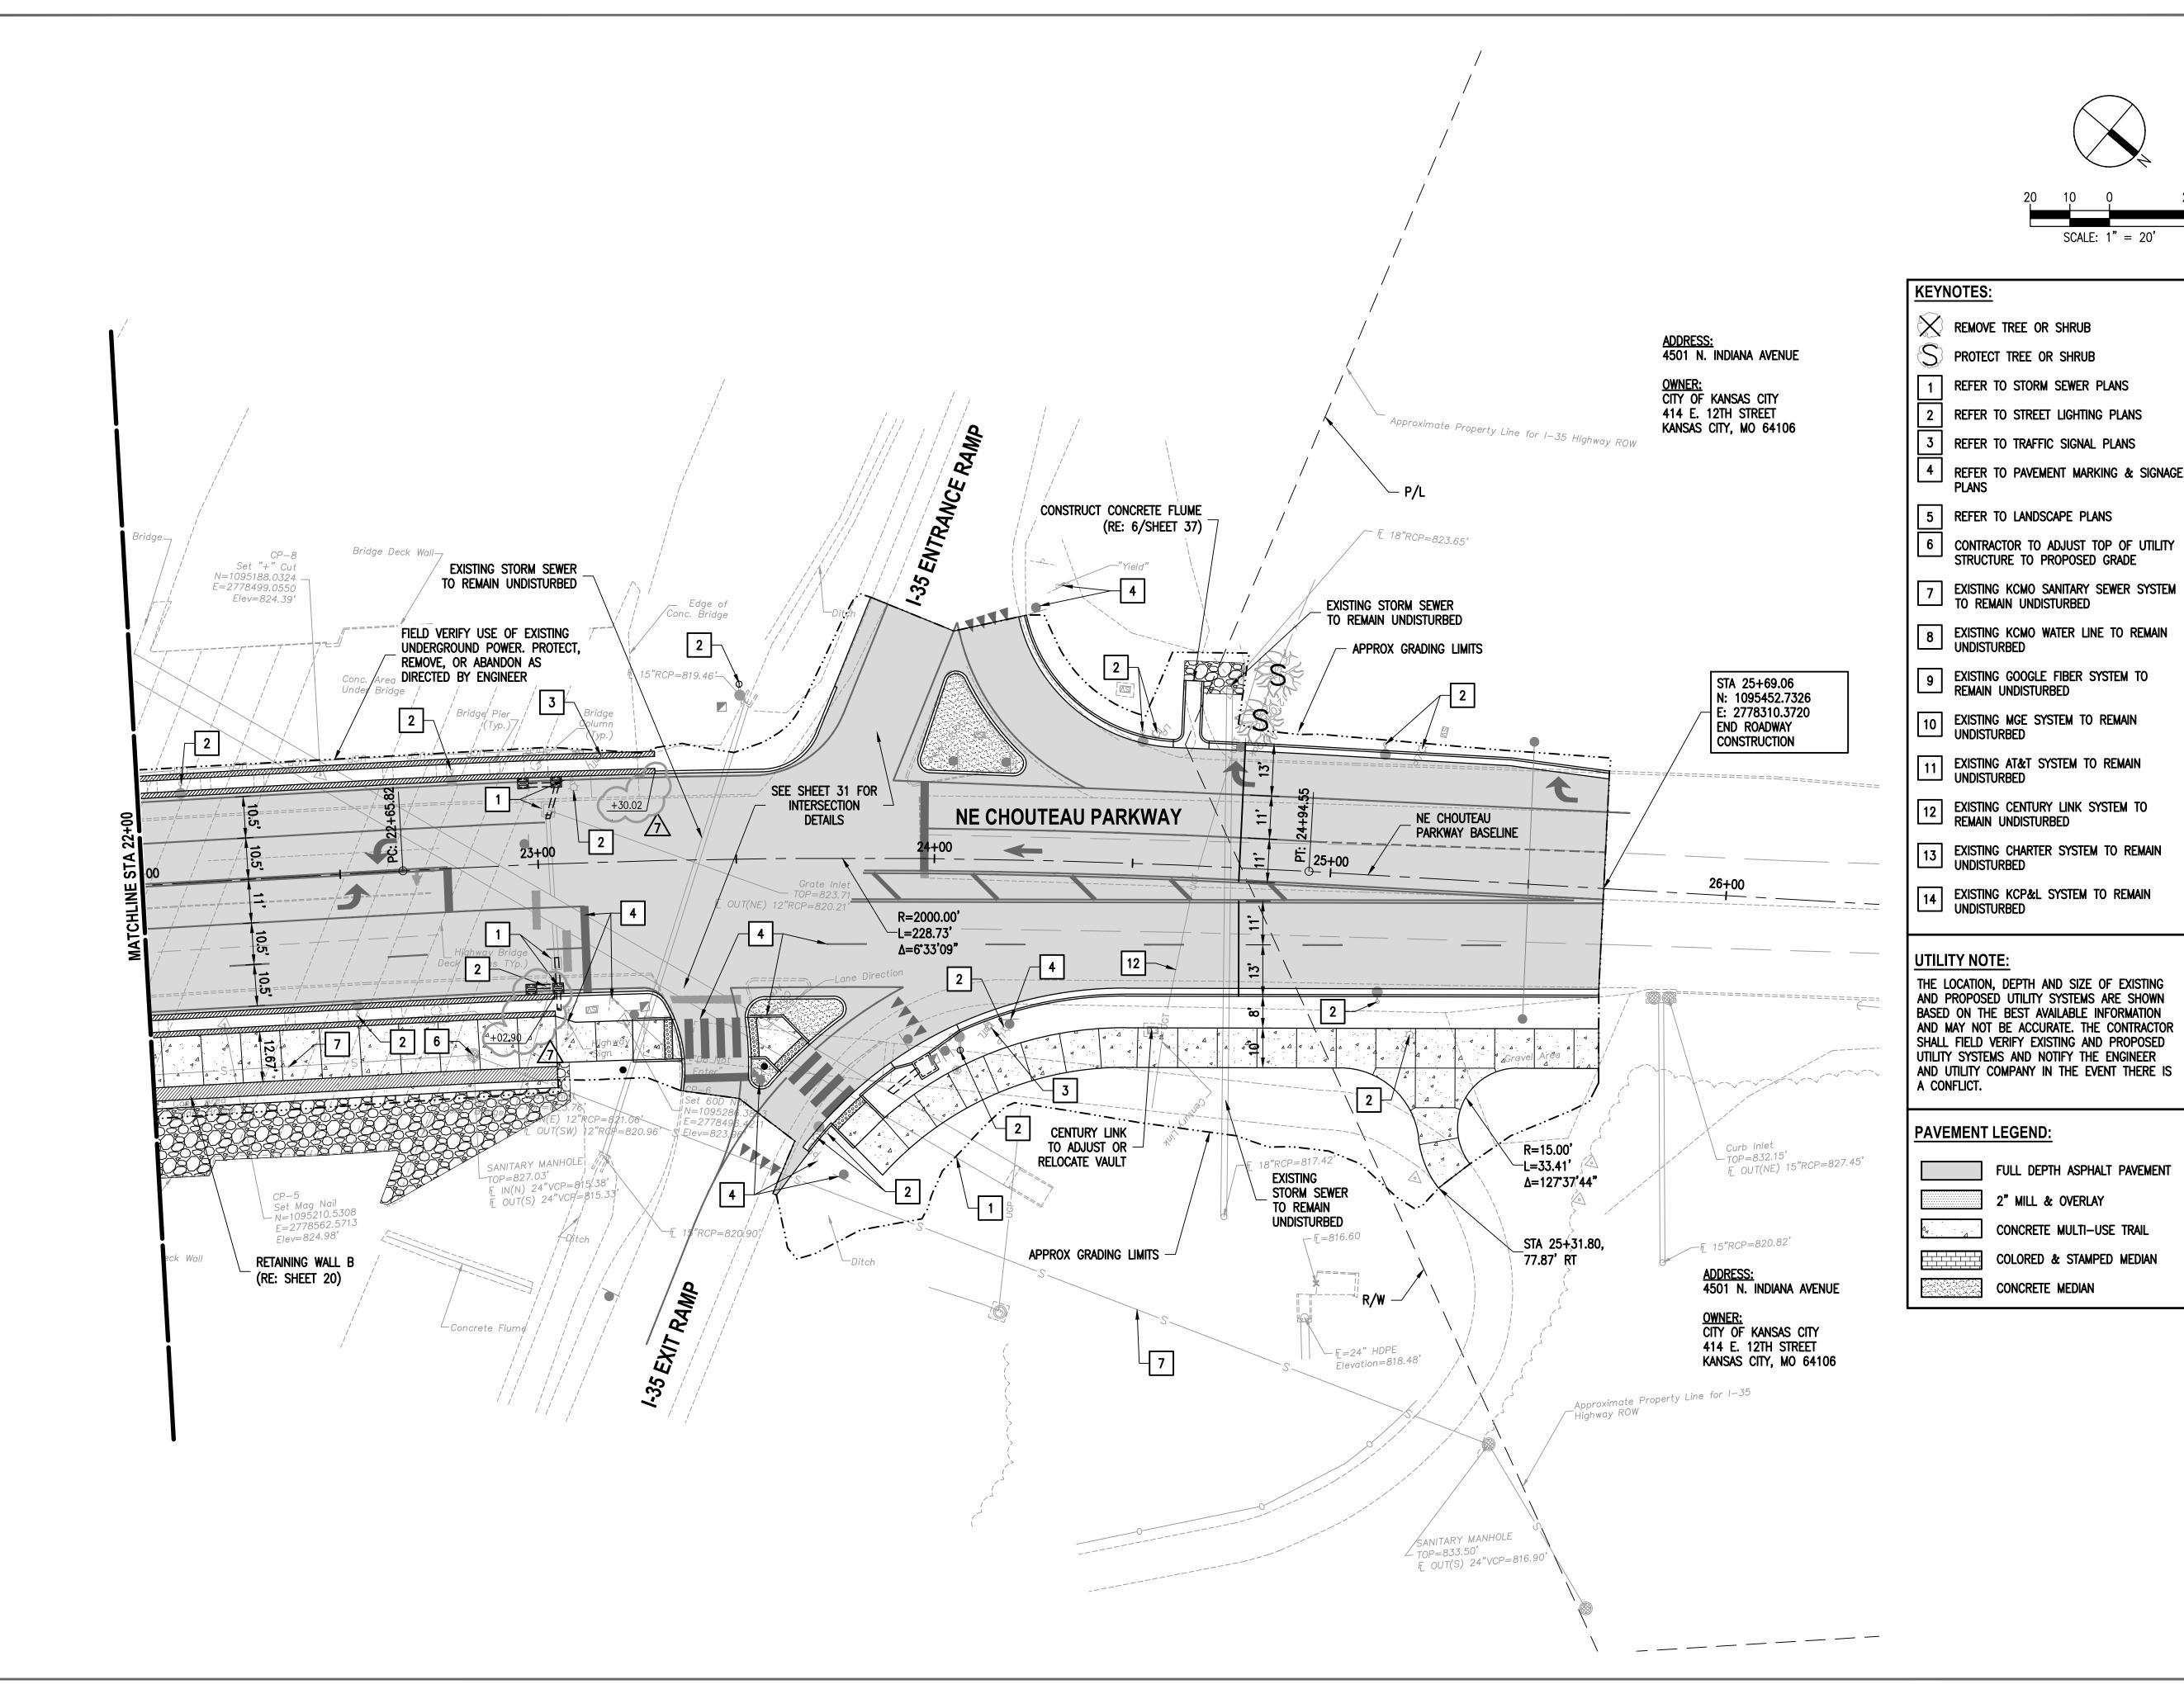



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816.701.2100 walterpmoore.com MO PE Corporation No. 1999141112

IN ASSOCIATION WITH

SCALE: 1" = 20'

PROJECT NAME

NE CHOUTEAU PARKWAY TRAIL CONNECTION

@ I-35 KANSAS CITY, MISSOURI CITY PROJECT NO. 70171305 FEDERAL PROJECT NO. CMAQ 3319(412)



NO. DATE	SUBMITTALS
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DESIGNED BY M.J.H. REVIEWED BY D.L.B DRAWN BY

D.M.B. PROJECT NUMBER

M08-17001-00 DATE

SHEET TITLE


PLAN - NE CHOUTEAU

SHEET NUMBER

PARKWAY

27 MAY 2020

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IN ASSOCIATION WITH

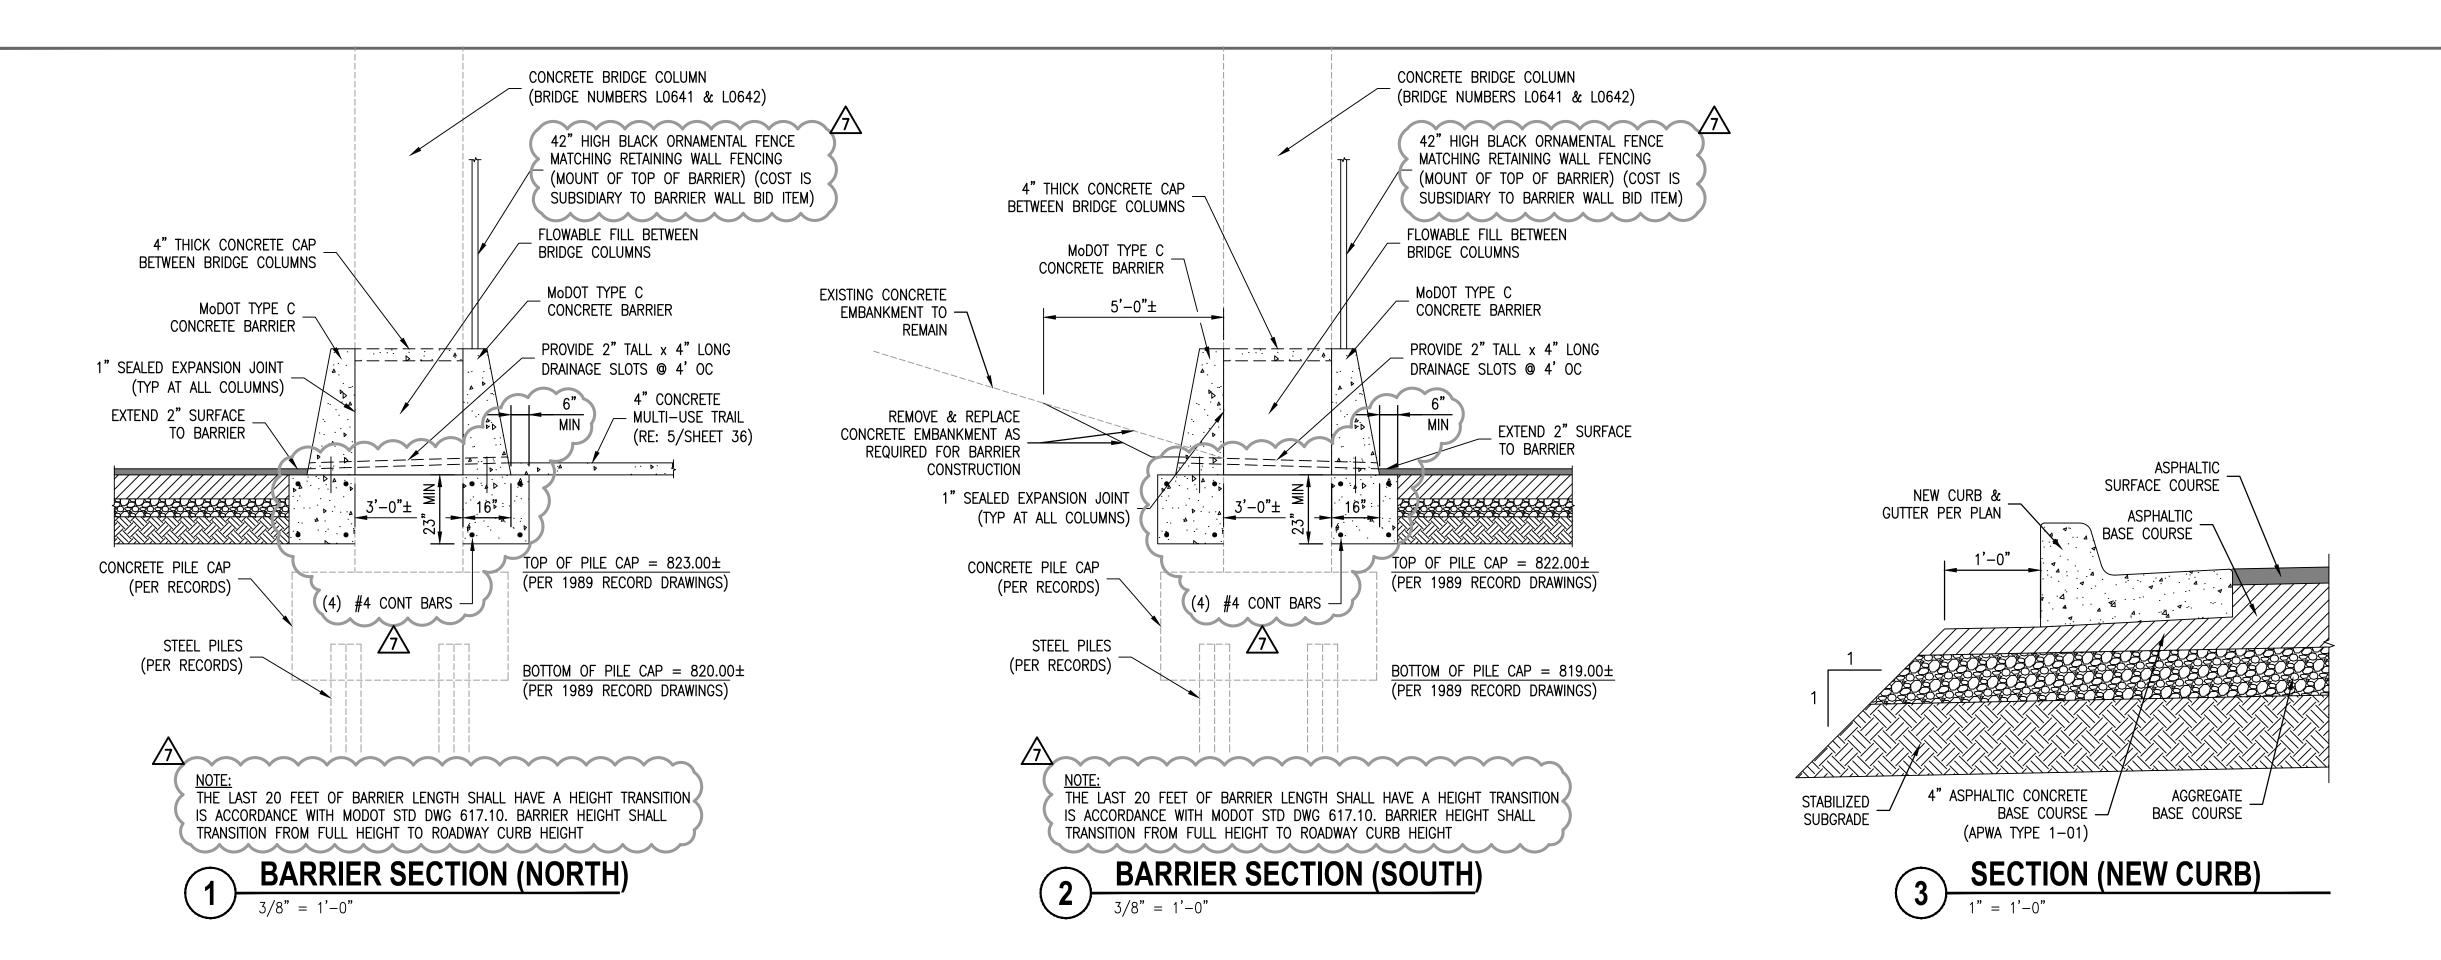PROJECT NAME

NO. DATE

NE CHOUTEAU PARKWAY TRAIL CONNECTION

@ I-35 KANSAS CITY, MISSOURI

CITY PROJECT NO. 70171305 FEDERAL PROJECT NO. CMAQ 3319(412)




SUBMITTALS


1 06/30/2017	MODOT COST SHARE			
2 11/17/2017	MODOT REVIEW			
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7 11/12/2020	ADDENDUM #2			
DESIGNED BY				
	M.J.H.			
REVIEWED BY				
	D.L.B			
DRAWN BY				
	D.M.B.			
PROJECT NUMBER				
	M08-17001-00			
DATE				
	27 MAY 2020			
SHEET TITLE				

ROADWAY DETAILS SHEET NUMBER

36 OF 102

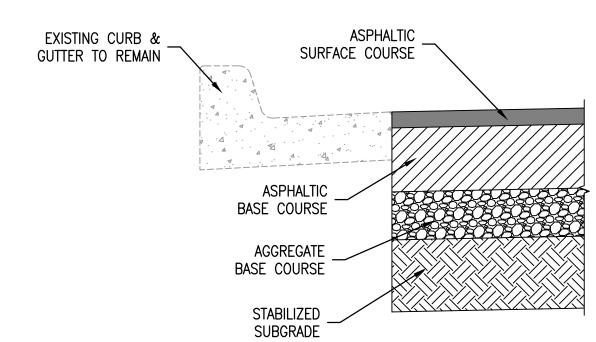



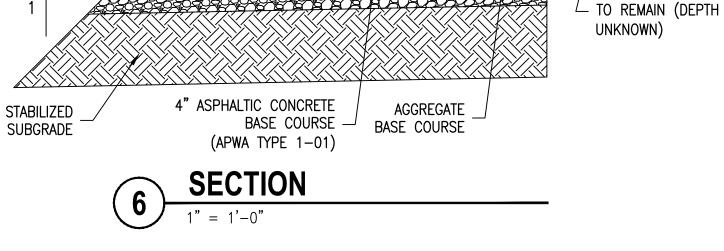

ASPHALTIC SURFACE COURSE

ASPHALTIC

BASE COURSE

SAWCUT PAVEMENT

EXISTING PAVEMENT

FULL DEPTH

NEW CURB &

CONCRETE PAVEMENT (EXTEND TO

NEW CURB &

GUTTER PER PLAN

BOTTOM OF EXISTING ADJACENT

AGGREGATE BASE COURSE

(4" MIN THICKNESS)

ASPHALT PAVEMENT

2" MILL &

OVERLAY

SAWCUT PAVEMENT

FULL DEPTH

1'-0"