

CITY OF LEE'S SUMMIT, MISSOURI 220 S.E. GREEN STREET LEE'S SUMMIT, MISSOURI 64063 (816) 969-1800

PUBLIC WORKS ENGINEERING DIVISION

Bid No. 36-322-1-C City of Lee's Summit, Missouri

Douglas Street / Lee's Summit Road Improvements, Colbern Road to Gregory Boulevard,

STP-3301 (455),

#### ADDENDUM NO. 1

BID OPENING DATE AND TIME REMAIN THE SAME Thursday, MAY 28, 2015 AT 2:00 P.M.

The original Request for Bid for *Bid No. 36-322-1C City of Lee's Summit, Missouri Douglas Street / Lee's Summit Road Improvements, Colbern Road to Gregory Boulevard, STP-3301 (455),* remains in effect except as revised by the following changes, which shall take precedence over anything to the contrary in the specifications.

The Bid Documents and Drawings for the above referenced project dated May 1, 2015 are hereby amended as follows. All other conditions remain unchanged.

Issued: Monday, May 11, 2015

### **Project Drawings and Details: ADD Water Main Relocation Plans**

Add plans entitled "Water Main Relocation, Lee's Summit Road from KCMO City Limits to Gregory Blvd., Section 18 and 19, Township 48N, Range 31W, Kansas City, Jackson County, Missouri." Plans consist of 12 sheets prepared for the Kansas City Water Services Department (KCWS). Plans are for relocating water mains owned and operated by KCWS.

Add plans entitled "Douglas St. & Lee's Summit Road from Colbern Road to KCMO City Limits, Water Main Relocation, Lee's Summit, Jackson County, Missouri, Project No. 363161-C." Plans consist of 17 sheets prepared for the City of Lee's Summit.

### **Enclosures**

- 2 Water Main Relocation Plan Sets:
- 1) Water Main Relocation, Lee's Summit Road from KCMO City Limits to Gregory Blvd., Section 18 and 19, Township 48N, Range 31W, Kansas City, Jackson County, Missouri (12 sheets)
- 2) Douglas St. & Lee's Summit Road from Colbern Road to KCMO City Limits, Water Main Relocation, Lee's Summit, Jackson County, Missouri, Project No. 363161-C (17 sheets)


### **ACKNOWLEDGEMENT**

Each bidder shall acknowledge receipt of this Addendum No. 1 of Bid No. 36-322-1C City of Lee's Summit, Missouri Douglas Street / Lee's Summit Road Improvements, Colbern Road to Gregory Boulevard, STP-3301 (455), by his/her signature affixed hereto, and shall attach this Addendum to the original bid submitted. Failure to sign and submit this addendum may render your bid Non-Responsive.

CERTIFICATION BY BIDDER:
SIGNATURE
TITLE
COMPANY
DATE

## WATER MAIN RELOCATION LEE'S SUMMIT ROAD FROM KCMO CITY LIMITS TO GREGORY BLVD.

SECTION 18 AND 19, TOWNSHIP 48N, RANGE 31W KANSAS CITY, JACKSON COUNTY, MISSOURI

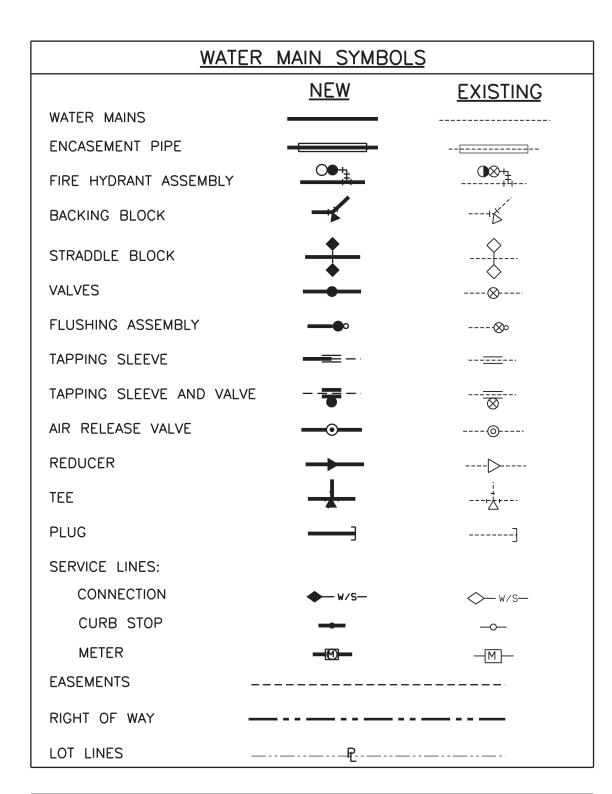


	OTHER UTILITIES	
(UNDERGROUND	UNLESS INDICATED	OTHERWISE)
	<u>NEW</u>	<b>EXISTING</b>
CABLE TV	TV	CATV
OVERHEAD ELECTRIC	OE	OE
NATURAL GAS	NG	NG
MANHOLE	<del></del>	
SANITARY SEWER	SAN	SAN
STORM SEWER	ST	ST
TELEPHONE	т	T
POWER POLE		O PP
LIGHT POLE	Ø	Ç LP

### PLANS PREPARED BY:



2400 PERSHING ROAD SUITE 400 KANSAS CITY, MISSOURI 64108 PHONE: 816 329-8600 FAX: 816 329-8602 CONTACT PERSON: MITCH LAMBETH TSC PN: P101090353

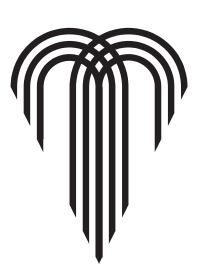

### WATER SERVICES DEPARTMENT **ENGINEERING DIVISION**



### **UTILTY CONTACTS**

TIME WARNER CABLE COMMUNICATION CONTACT ROY BELLIS TELEPHONE: (913) 643-1914 CONTACT BRAIN CORNISH TELEPHONE (913) 345-7524 COMMUNICATION GAS ENERGY CONTACT CHRIS COLLINS TELEPHONE: (816) 472-3413 STORM SEWER

LINE LOCATION

KANSAS CITY POWER AND LIGHT CONTACT MARCUS ROBINSON TELEPHONE: (816) 245-3777 CONTACT JOE BULLIMORE MISSOURI UTILITY

TELEPHONE: (816) 325-5658

WATER SERVICES DEPARTMENT CONTACT HEATHER MASSEY TELEPHONE (816) 513-0460

UNITE PRIVATE NETWORKS CONTACT JIM SKAGGS TELEPHONE: (816)-365-1465

CITY OF KANSAS CITY, MISSOURI WATER SERVICES DEPARTMENT CONTACT HEATHER MASSEY TELEPHONE (816) 513-0460 MISSOURI ONE CALL 1-800-DIG-RITE

(1-800-344-7483)LAW REQUIRES YOU TO CALL 48 HOURS BEFORE YOU DIG




### **INDEX OF SHEETS**

SHEET NO. TITLE

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3	CONTROL DATA SHEET
4	6" AND 8" MAIN IN LEE'S SUMMIT ROAD PLAN AND PROFILE
5	8" MAIN IN LEE'S SUMMIT ROAD PLAN AND PROFILE
6	8" AND 12" MAIN IN LEE'S SUMMIT ROAD PLAN AND PROFILE
7	12" MAIN IN LEE'S SUMMIT ROAD PLAN AND PROFILE
8	12" MAIN IN LEE'S SUMMIT ROAD PLAN AND PROFILE
9	12" MAIN IN LEE'S SUMMIT ROAD PLAN AND PROFILE
10	12" MAIN IN LEE'S SUMMIT ROAD PLAN AND PROFILE
11	12" MAIN IN LEE'S SUMMIT ROAD PLAN AND PROFILE
12	8" MAIN IN 85TH ST. AND 6" MAIN TRUMAN MEDICAL CENTER
	PLAN AND PROFILE

APPROVED: DATE ANDY SHIVELY, P.E., ENGINEERING OFFICER FOR TERRY LEEDS, DIRECTOR, WATER SERVICES DEPARTMENT

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KANSAS CITY, MISSOURI, WATER SERVICES DEPARTMENT
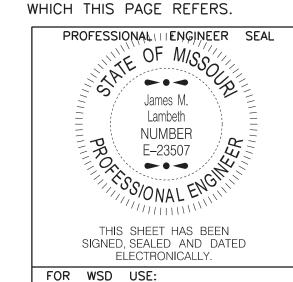
### WATER MAIN RELOCATION FOR

LEE'S SUMMIT ROAD

LEE'S SUMMIT ROAD FROM KCMO CITY LIMITS TO GREGORY BLVD., JACKSON COUNTY, MISSOURI

**COVER SHEET** 

DRAWN BY:	CHECKED BY:	DATE S	SUBMITTE	D:	RANGE		TOW	NSHIP	SEC	MOIT
CAS	DRW	01-0	04-2013	<b>,</b>	31W		4	8N	18	& 1
	CONTRACTOR				D	ΑT	E C	OMPLE	TED	
CONTRACT NO.	CONTRACT DATE		NO.	wo	RK ORDI	ER	NO.	DRA	WING	NO.
		_	J-4949 J-5151							-
PROJECT NO.										
					SHEET	1	OF	12		




## (INDICATED ON THE DRAWINGS, LOCATED AT GRADE BY A UTILITY LOCATING SERVICE, OR EVIDENT FROM UTILITY COMPANY INFORMATION) 10. STREETS AND PARKING AREAS ARE TO BE TO GRADE AND CURBS IN PLACE PRIOR TO CONSTRUCTION OF WATER MAINS. WATER MAINS SEPARATION OF 10 FEET, A WATER MAIN MAY BE LAID CLOSER THAN 10 FEET TO A SEWER, PROVIDED THAT THE WATER MAIN IS LAID IN A SEPARATE TRENCH, OR ON AN UNDISTURBED EARTH SHELF LOCATED ON ONE SIDE OF THE SEWER, AT SUCH AN ELEVATION THAT THE BOTTOM OF THE WATER MAIN IS AT LEAST 18 INCHES ABOVE THE TOP OF THE SEWER. WATER MAINS SHALL BE LAID SUCH THAT VERTICAL SEPARATION OF 18 INCHES BETWEEN THE BOTTOM OF THE SEWER AND THE TOP OF THE WATER MAIN SHALL BE MAINTAINED.

	KCMO SUMMARY OF QUA	ANTITIES	
NO.	BID ITEM	UNITS	QUANTITY
	WATER LINE QUANTITIES		
1	REDUCER (8"x6")	EA.	1
2	REDUCER (12"x6")	EA.	1
3	REDUCER (12"x8")	EA.	1
4	TEE (12"x6")	EA.	1
5	TEE (12"x8")	EA.	1
6	TEE (12"x12")	EA.	1
7	TEE (20"x12")	EA.	1
8	SOLID SLEEVE (6")	EA.	1
9	SOLID SLEEVE (8")	EA.	1
10	SOLID SLEEVE (16")	EA.	2
11	SOLID SLEEVE (20")	EA.	2
12	BEND (6") (22.5 DEGREE)	EA.	1
13	BEND (6") (90 DEGREE)	EA.	2
14	BEND (8") (45 DEGREE)	EA.	3
15	BEND (12") (11.25 DEGREE)	EA.	1
16	BEND (12") (22.5 DEGREE)	EA.	10
17	BEND (12") (45 DEGREE)	EA.	2
18	BEND (12") (90 DEGREE)	EA.	1
19	GATE VALVE (6")	EA.	2
20	GATE VALVE (8")	L.F.	2
21	GATE VALVE (12")	L.F.	5
22	DIP WATER MAIN (6") (CLASS 52)	L.F.	673
23	DIP WATER MAIN (8") (CLASS 52)	L.F.	1,916
24	DIP WATER MAIN (12") (CLASS 52)	L.F.	4,128
25	DIP WATER MAIN (16") (CLASS 54)	L.F.	10
26	DIP WATER MAIN (20") (CLASS 54)	EA.	10
27	FIRE HYDRANT ASSEMBLY (NEW)	EA.	7
28	AIR RELEASE VALVE	EA.	2
29	TYPICAL FLUSHING ASSEMBLY	EA.	1
30	AS-BUILT WATER PLANS	EA.	1

SUMMARY OF QUANTITIES ARE PROVIDED FOR BID PURPOSES ONLY. ANY ITEMS NOT LISTED ARE TO BE CONSIDERED SUBSIDIARY TO THE ITEMS LISTED ABOVE.

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PROFESSIONAL I LENGINEER SEAL James M. Lambeth NUMBER E-23507 THIS SHEET HAS BEEN SIGNED, SEALED AND DATED ELECTRONICALLY. FOR WSD USE:

KANSAS CITY, MISSOURI, WATER SERVICES DEPARTMENT
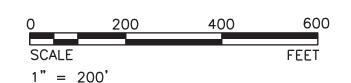
## WATER MAIN RELOCATION

LEE'S SUMMIT ROAD

LEE'S SUMMIT ROAD FROM KCMO CITY LIMITS TO GREGORY BLVD., JACKSON COUNTY, MISSOURI

GENERAL LAYOUT **GENERAL NOTES AND** SUMMARY OF QUANTITIES

DRAWN BY:	CHECKED BY:	DATE S	SUBMITTE	D:	RANGE	TOW	NSHIP	SE	CTI	NC
CAS	DRW	01-0	04-2013		31W	4	8N	18	&	19
	CONTRACTOR				DA	ATE C	OMPLE	TED		
ONTRACT NO.	CONTRACT DATE		NO.	wo	RK ORDE	R NO.	DRA	WINC	N	0.
		J-4749 J-5149	J-4949 J-5151							
ROJECT NO.										
					SHEET	2 OF	12			

16. COVERS, LIDS, AND STANDPIPES ON ALL ABANDONED VALVES SHALL BE REMOVED TO AT LEAST TWO FEET (2') BELOW GRADE AND THE AREA SHALL BE PROPERLY BACKFILLED. IN PAVED AREAS REMOVAL OF VALVE LID AND FILLING OF VALVE BOX WITH CONCRETE MAY BE ALLOWED AT WATER SERVICES DEPARTMENT DISCRETION.

SPECIFICATIONS, WHICH ARE MADE A PART HEREOF BY REFERENCE. EROSION CONTROL PLANS SHALL BE SUBMITTED TO THE CITY

THE LOCATIONS OF EXISTING UTILITIES, AS SHOWN, ARE APPROXIMATE. IT SHALL BE THE RESPONSIBILITY OF THE CONTRACTOR TO VERIFY THE LOCATIONS AND ELEVATIONS OF ALL EXISTING UTILITIES. CONTRACTORS SHALL POTHOLE AND EXPOSE ALL UTILITIES

SHALL BE INSTALLED WITH A MINIMUM GROUND COVER OF 42 INCHES BELOW FINISHED GRADE. SIXTEEN (16)-INCH AND LARGER

11. WATER MAINS SHALL BE LAID AT LEAST 10 FEET, HORIZONTALLY FROM ANY SEWER, WHEN LOCAL CONDITIONS PREVENT A HORIZONTAL

THERE IS A MINIMUM OF 18 INCHES CLEARANCE BETWEEN THE PIPE WALL AND THE EXTERIOR OF ANY MANHOLE AND/OR INLET ON

A FULL LENGTH OF WATER MAIN PIPE SHALL BE CENTERED ON THE SEWER TO BE CROSSED SO THAT THE JOINTS WILL BE EQUALLY DISTANT FROM THE SEWER AND AS FAR AWAY AS POSSIBLE. THE 18-INCH VERTICAL SEPARATION SHALL BE MAINTAINED FOR THAT

WHEN IT IS IMPOSSIBLE TO OBTAIN PROPER HORIZONTAL SEPARATION AS STIPULATED ABOVE, OR WHEN A WATER MAIN MUST CROSS UNDER A SEWER. THE SEWER MUST BE RECONSTRUCTED OF DUCTILE IRON PIPE MEETING THE REQUIREMENTS OF SECTION 02618 OF THE STANDARDS AND SPECIFICATIONS FOR WATER MAIN EXTENSIONS AND RELOCATIONS; PRE-STRESSED CONCRETE CYLINDER PIPE MEETING THE REQUIREMENTS OF SECTION 02619; OR PVC PRESSURE PIPE CONFORMING TO AWWA C-900 OR C-905, AND SHALL BE

PRESSURE TESTED TO ASSURE WATER TIGHTNESS BEFORE BACKFILLING. THE REQUIRED LENGTH OF SEWER TO BE REPLACED OR

WHERE THESE CONDITIONS CANNOT BE MET, THE WATER SERVICES DEPARTMENT SHALL BE CONSULTED AS TO THE PRECAUTIONS TO

FOR ALL SANITARY AND STORM SEWER CROSSINGS REFER TO STANDARDS AND SPECIFICATIONS FOR WATER MAIN EXTENSIONS AND

12. AN EXCAVATION PERMIT MUST BE OBTAINED FROM THE CITY ENGINEER PRIOR TO COMMENCING CONSTRUCTION WITHIN THE PUBLIC

CONSTRUCTED OF PRESSURE PIPE WILL BE THE LENGTH NECESSARY TO ACHIEVE 10 FEET HORIZONTAL SEPARATION.

RELOCATIONS: STANDARD DETAILS #01016-1, #01016-2, #01016-3, #01016-6-4, AND #01016-5 AS REQUIRED.

13. A STREET CLOSURE PERMIT MAY BE REQUIRED FOR THIS WORK. CONTACT THE STREET AND TRAFFIC DIVISION AT CITY HALL.

14. ALL WORK SHALL CONFORM TO THE LATEST REVISION OF THE KANSAS CITY, MISSOURI EROSION AND SEDIMENT CONTROL

ENGINEER, PUBLIC WORKS DEPARTMENT FOR REVIEW AND APPROVAL PRIOR TO THE START OF THIS PROJECT.

WHENEVER A WATER MAIN MUST CROSS ABOVE A SEWER, A VERTICAL SEPARATION OF 18 INCHES BETWEEN THE BOTTOM OF THE

WATER MAIN AND THE TOP OF THE SEWER SHALL BE MAINTAINED. WHENEVER A WATER MAIN MUST CROSS UNDER A SEWER, A

THE CONTRACTOR SHALL COMPLY WITH STATE LAW REQUIRING ANY PERSON OR FIRM DOING EXCAVATION ON THE PUBLIC

RIGHT-OF-WAY DO SO ONLY AFTER GIVING NOTICE TO AND OBTAINING INFORMATION FROM UTILITY COMPANIES.

WATER MAINS SHALL BE INSTALLED WITH A MINIMUM GROUND COVER OF 60 INCHES BELOW FINISHED GRADE.

PORTION OF THE WATER MAIN LOCATED WITHIN 10 FEET, HORIZONTALLY, OF ANY SEWER IT CROSSES.

RIGHT-OF WAY. CONTACT THE PUBLIC WORKS DEPARTMENT PERMIT COUNTER AT CITY HALL.

15. THE END OF ALL ABANDONED WATER MAINS SHALL BE PLUGGED WITH CONCRETE

AT LEAST 500 FEET IN ADVANCE OF WATER MAIN CONSTRUCTION, DETERMINING THE DEPTH, SIZE, AND MATERIAL OF THE UTILITIES IN PROXIMITY TO THE PROPOSED WATER MAIN ALIGNMENT. DEFLECT PIPE TO MAINTAIN MINIMUM 5 FEET HORIZONTAL AND 18 INCH

17. EXISTING FIRE HYDRANTS THAT ARE REMOVED SHALL BE RETURNED TO THE WATER SERVICES DEPARTMENT STORE YARD AT 2409 E. 18TH ST.

RESTRAINING DEVICES AND STRADDLE BLOCKS IN LIEU OF BACKING BLOCKS.

THE SEWER LINE.

BE TAKEN TO PROTECT THE PUBLIC WATER SUPPLY.


VERTICAL CLEARANCES BETWEEN PROPOSED WATER MAIN AND ALL EXISTING UTILITIES.

18. WATER SERVICE LINES CONNECTED TO MAINS BEING ABANDONED SHALL BE RECONNECTED TO NEW MAINS IN ACCORDANCE WITH THE RULES AND REGULATIONS FOR WATER SERVICES LINES OF THE WATER SERVICES DEPARTMENT, UNLESS SHOWN OTHERWISE. EXISTING WATER SERVICE LINES BEING TRANSFERRED TO NEW MAINS WILL BE UPGRADED TO MEET CURRENT REGULATIONS.

19. THE CONTRACTOR SHALL VERIFY THE OUTSIDE DIAMETER (O.D.) OF THE EXISTING WATER MAIN PRIOR TO SCHEDULING CONNECTION. PROVIDE SOLID SLEEVES AS REQUIRED.


20. CONTRACTORS SHALL PROTECT EXISTING POWER POLES AND LIGHT POLES FROM DAMAGE AND SHALL PROVIDE BRACING, SHORING, OR OTHER WORK NECESSARY FOR SUCH PROTECTION. ANY STRUCTURES REMOVED DURING CONSTRUCTION OPERATIONS SHALL BE

21. PRIOR TO REMOVING EXISTING TRANSMISSION MAINS 16" AND LARGER FROM SERVICE, CONTRACTOR SHALL COORDINATE WITH KCWSD REGARDING THE TIMING AND DURATION OF THE INTERRUPTION OF SERVICE. NO TRANSMISSION MAIN SHALL BE TAKEN OUT OF SERVICE IN PEAK DEMAND TIMES (MAY 15TH THRU SEPT. 15TH).

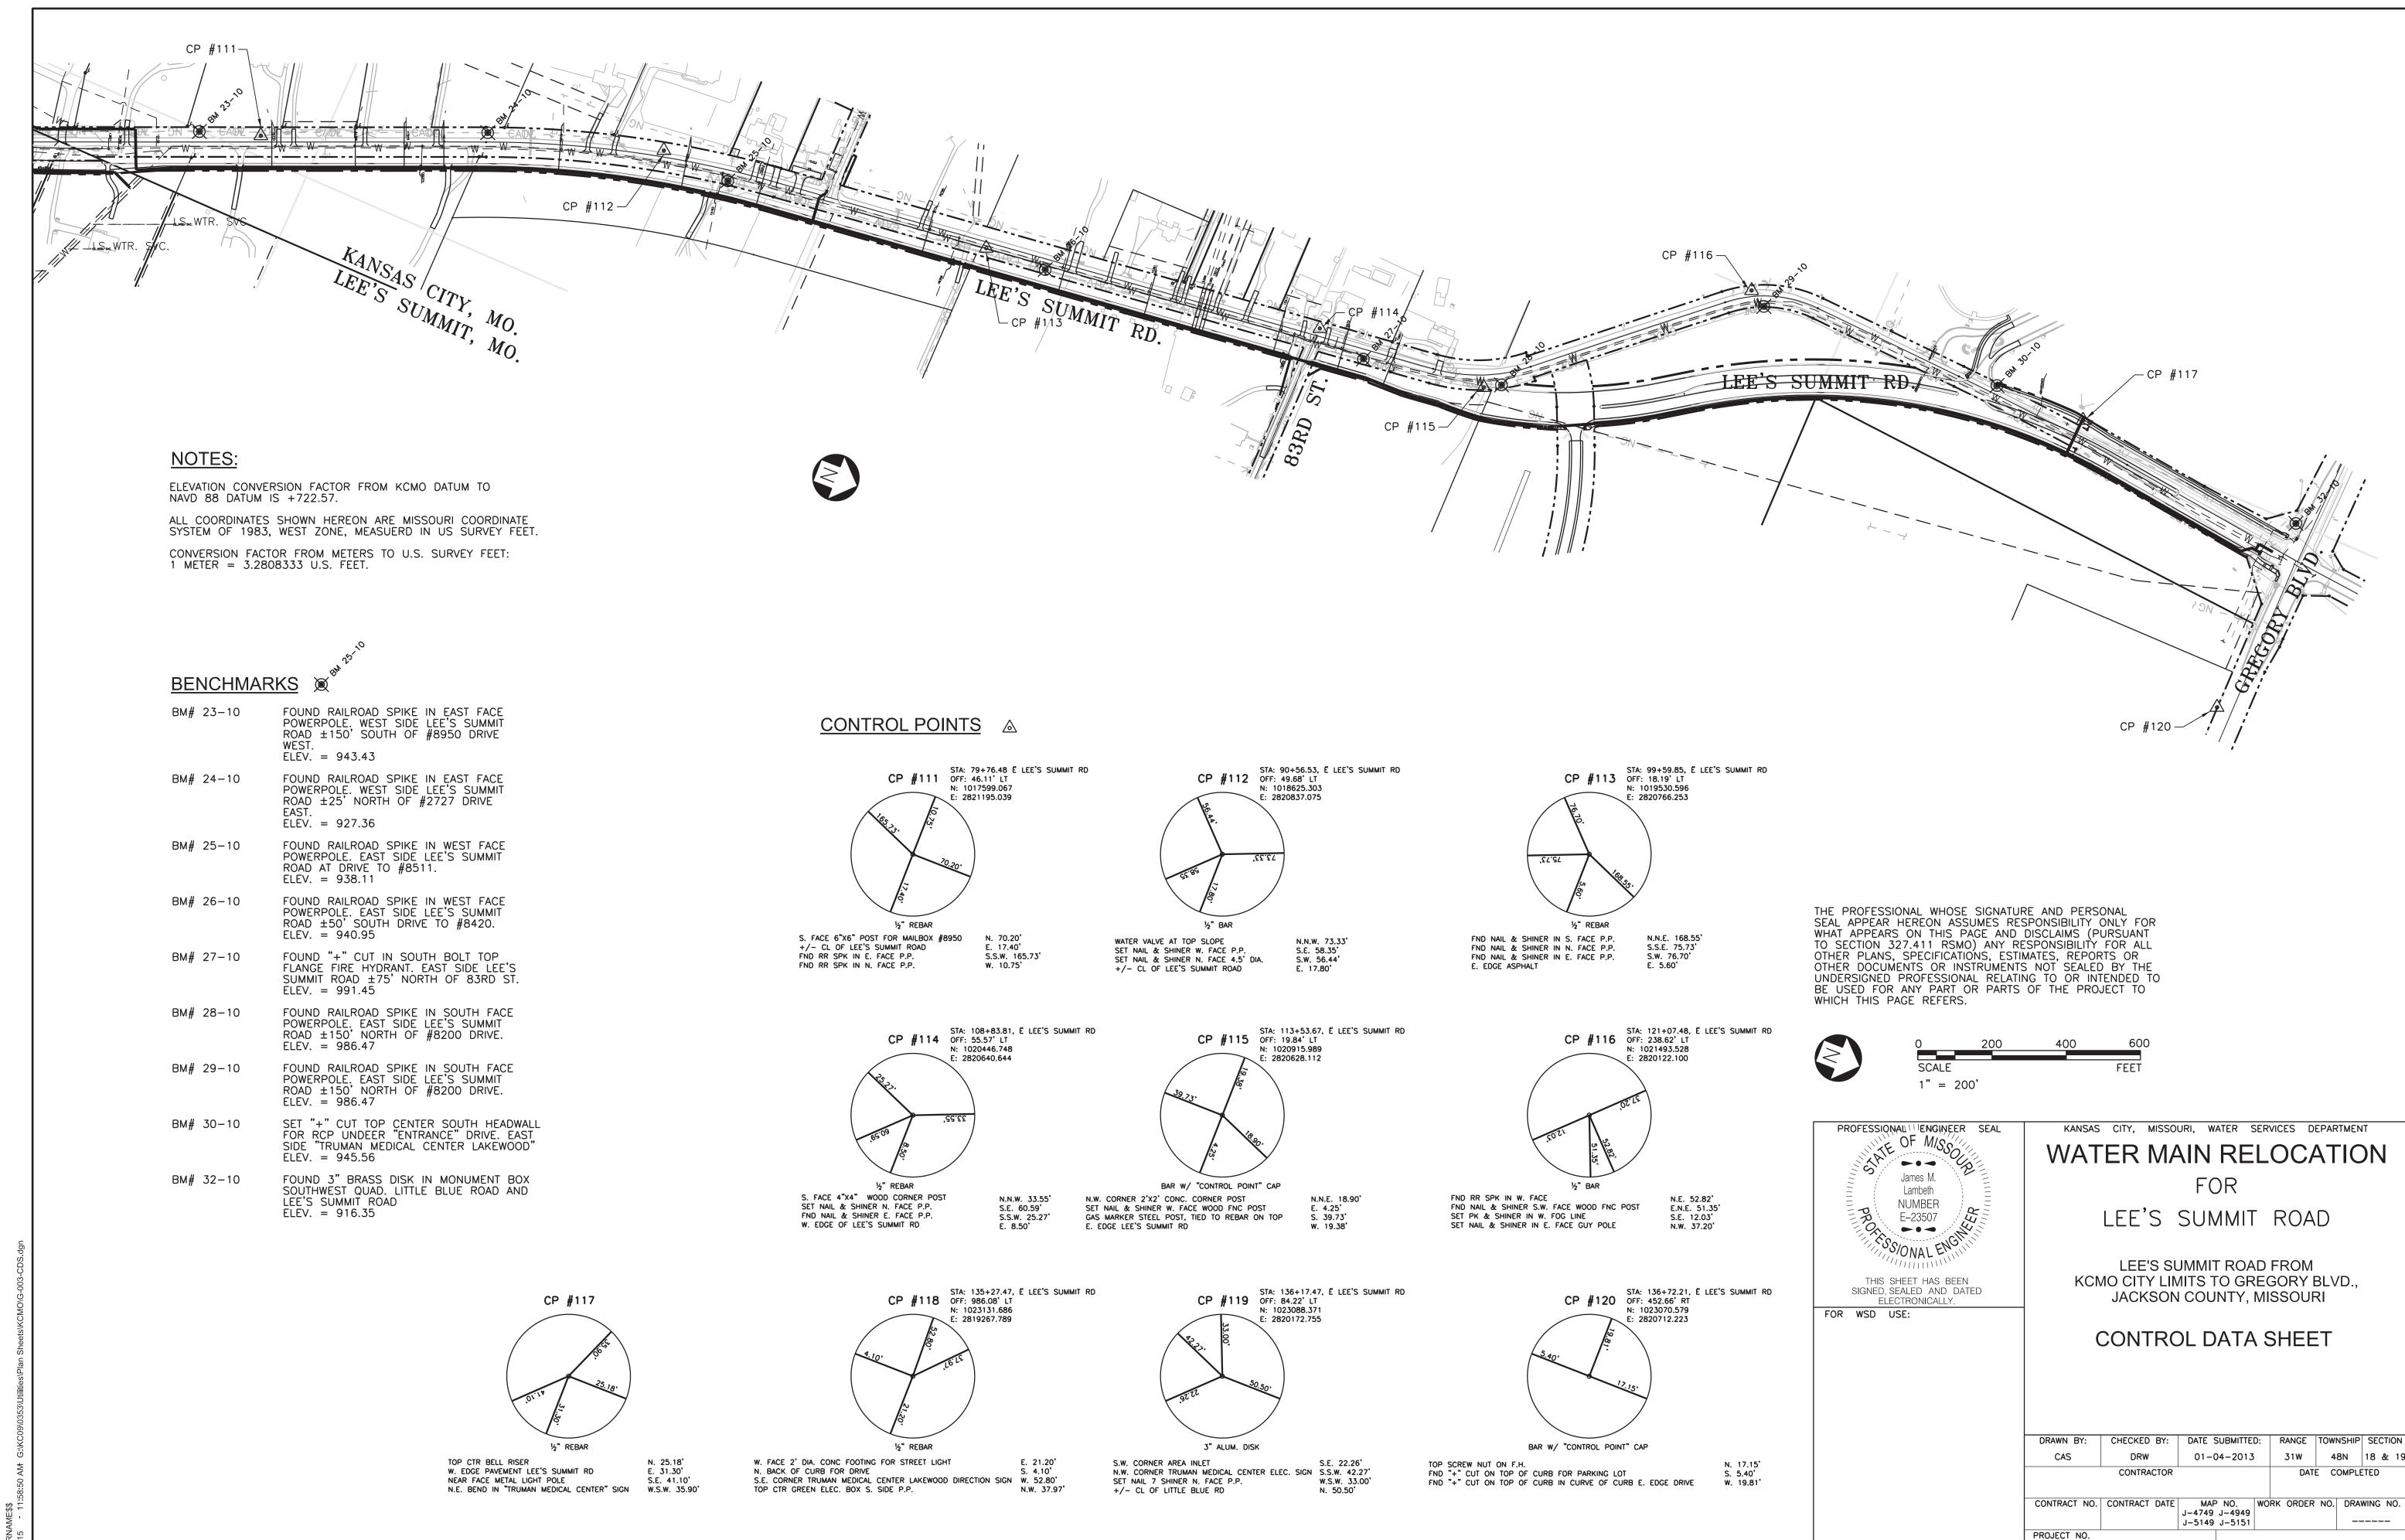

SHEET 3 OF 12

\_\_\_\_\_

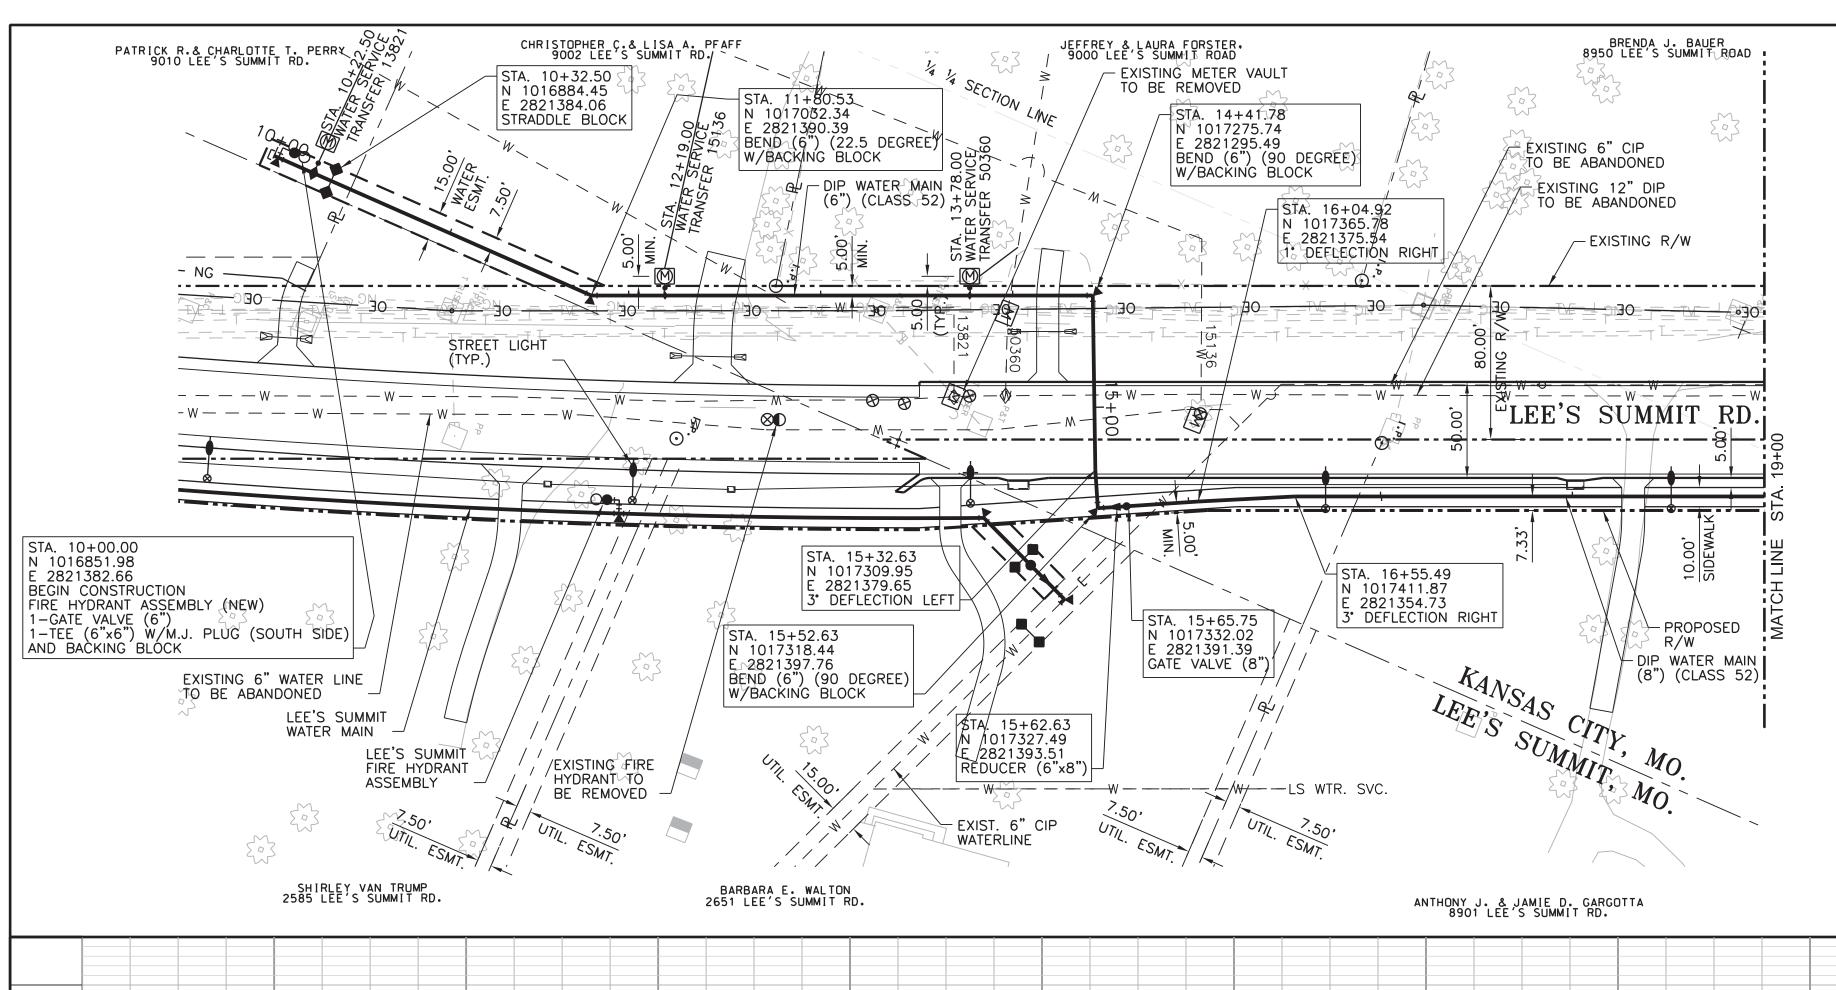

	EXISTING W	ATER SER	VICES TO E	BE TRANS	FERRED		
ADDRESS	REGISTER NUMBER	MAINT	O CURB	CUF	RB IN	INSTALL CURB BOX	INSTALL /
	NUMBER	SIZE	TYPE	SIZE	TYPE	CORPRO	METER
9000 Lees Summit road	50360	3/4 "	K	3/4 "	K	YES	YES
9002 Lees Summit road	15136	3/4 "	K	3/4 "	K	YES	YES
9010 Lees Summit road	13821	3/4 "	К	3/4 "	К	YES	YES


1. CONTRACTOR TO FIELD VERIFY HORIZONTAL AND VERTICAL LOCATION OF ALL EXISTING UTILITIES AND FIELD ADJUST NEW WATER MAIN AS NECESSARY TO COORDINATE ALL ALIGNMENT MODIFICATIONS WITH THE KANSAS CITY, MO. WATER SERVICES DEPARTMENT.


### **LEGEND**

944.16 = PROPOSED GRADE ELEV. ABOVE WATER MAIN

939.66 = FLOWLINE ELEV. OF WATER MAIN

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WATER MAIN RELOCATION

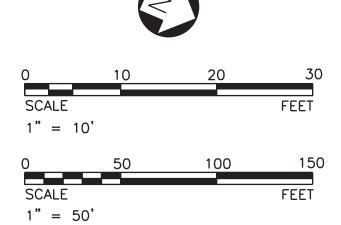
FOR

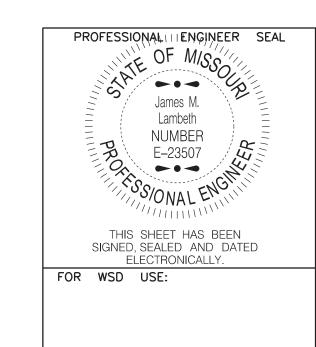
LEE'S SUMMIT ROAD

LEE'S SUMMIT ROAD FROM KCMO CITY LIMITS TO GREGORY BLVD., JACKSON COUNTY, MISSOURI

> 6" AND 8" MAIN IN LEE'S SUMMIT ROAD PLAN AND PROFILE

DRAWN BY:	CHECKED BY:	DATE S	SUBMITTE	D:	RANGE	TOW	NSHIP	SE	CTI	NC
CAS	DRW	01-0	04-2013	,	31W	4	8N	18	&	19
	CONTRACTOR				DATI	E C	OMPLE	TED		
CONTRACT NO.	CONTRACT DATE		NO. J-4949	wo	RK ORDER	NO.	DRA	WING	N	0.
			J-5151							
PROJECT NO.										
					SHEET 4	OF	12			

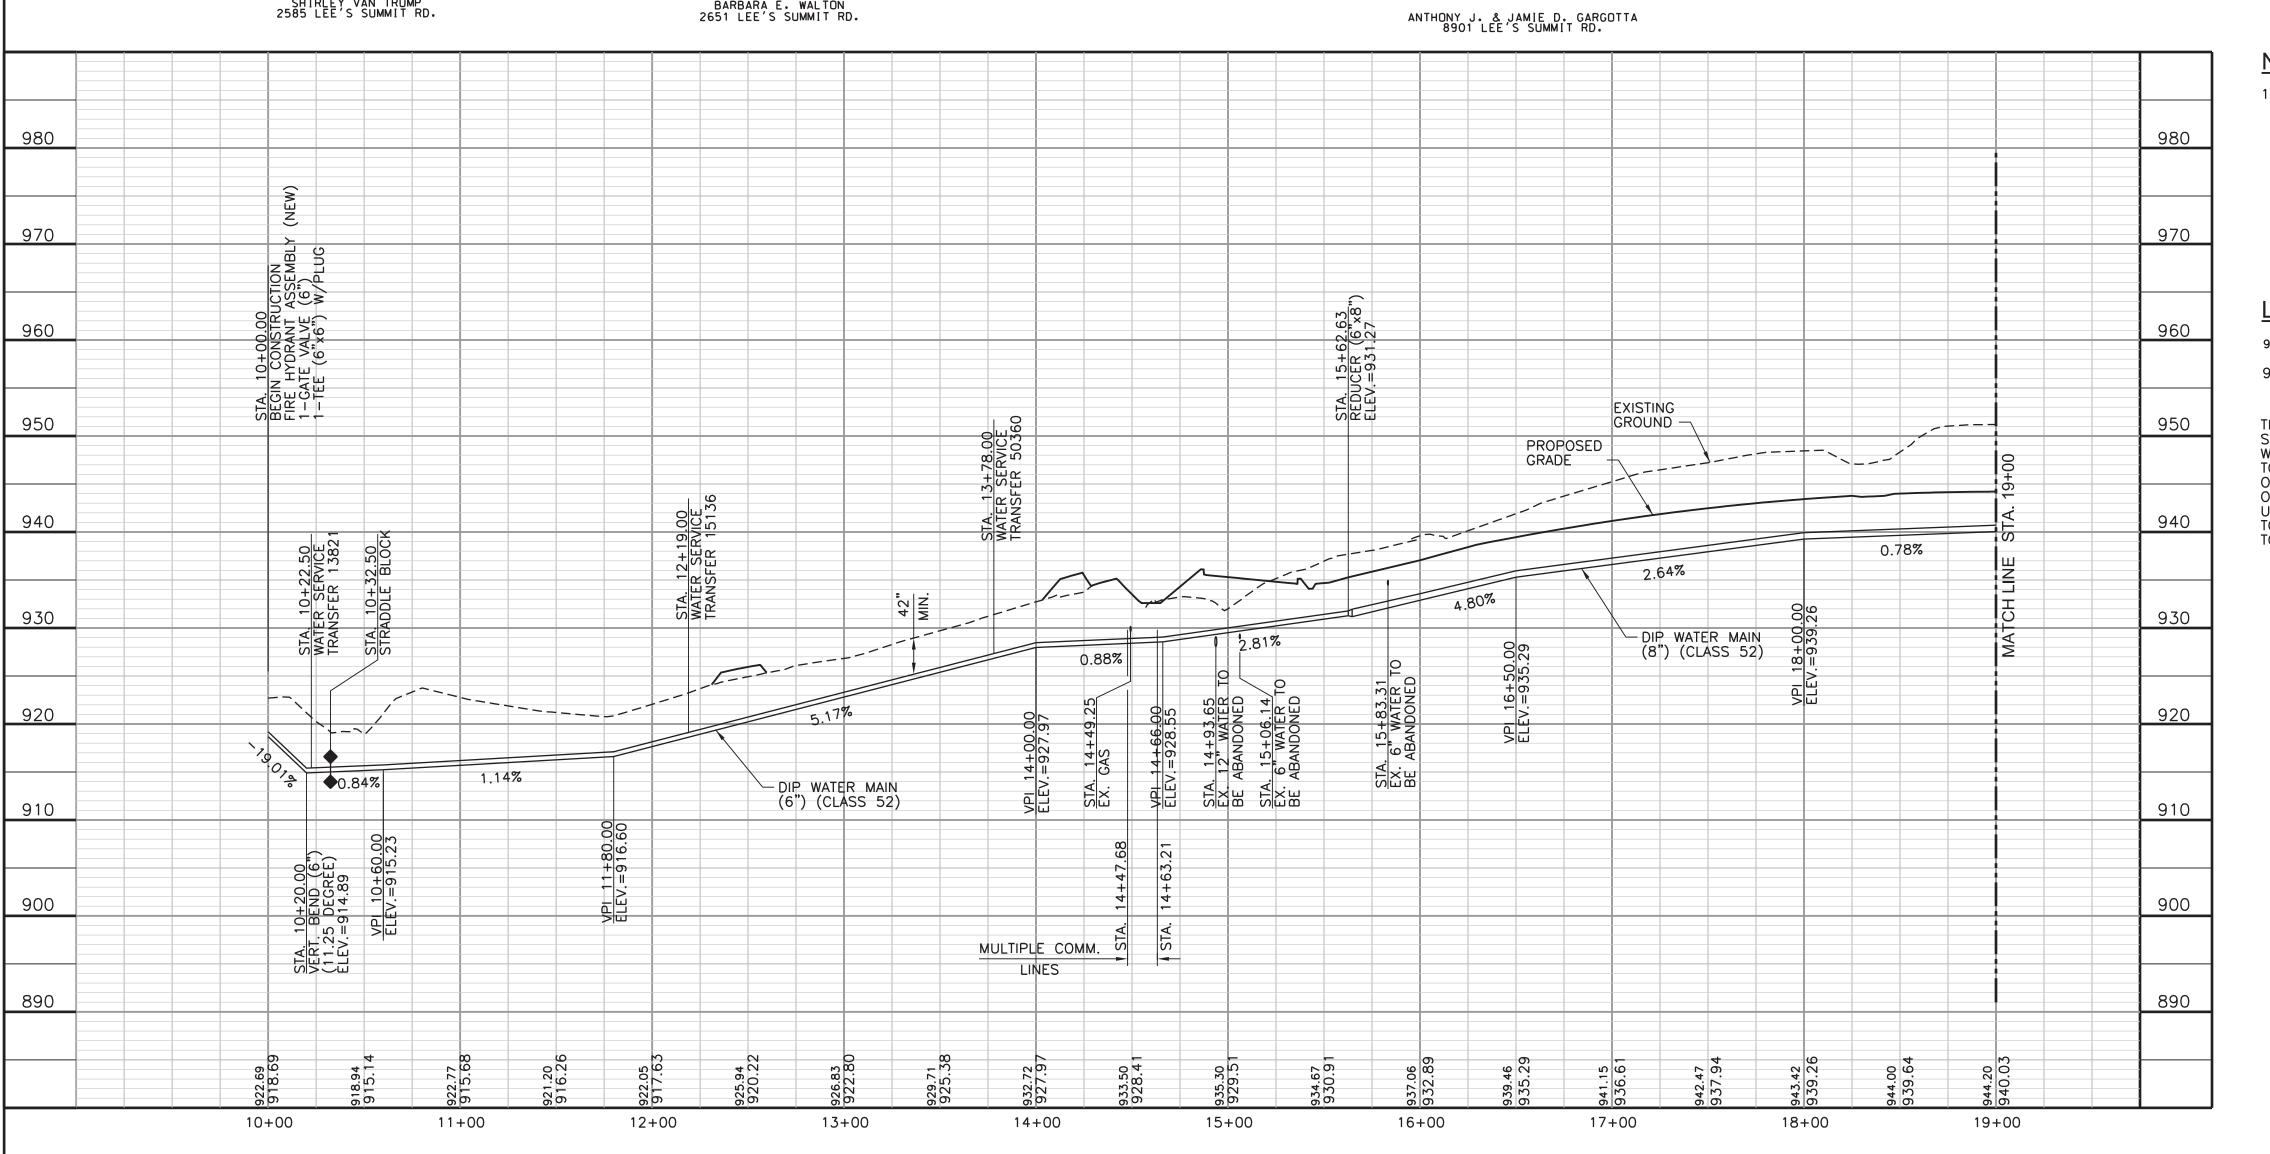

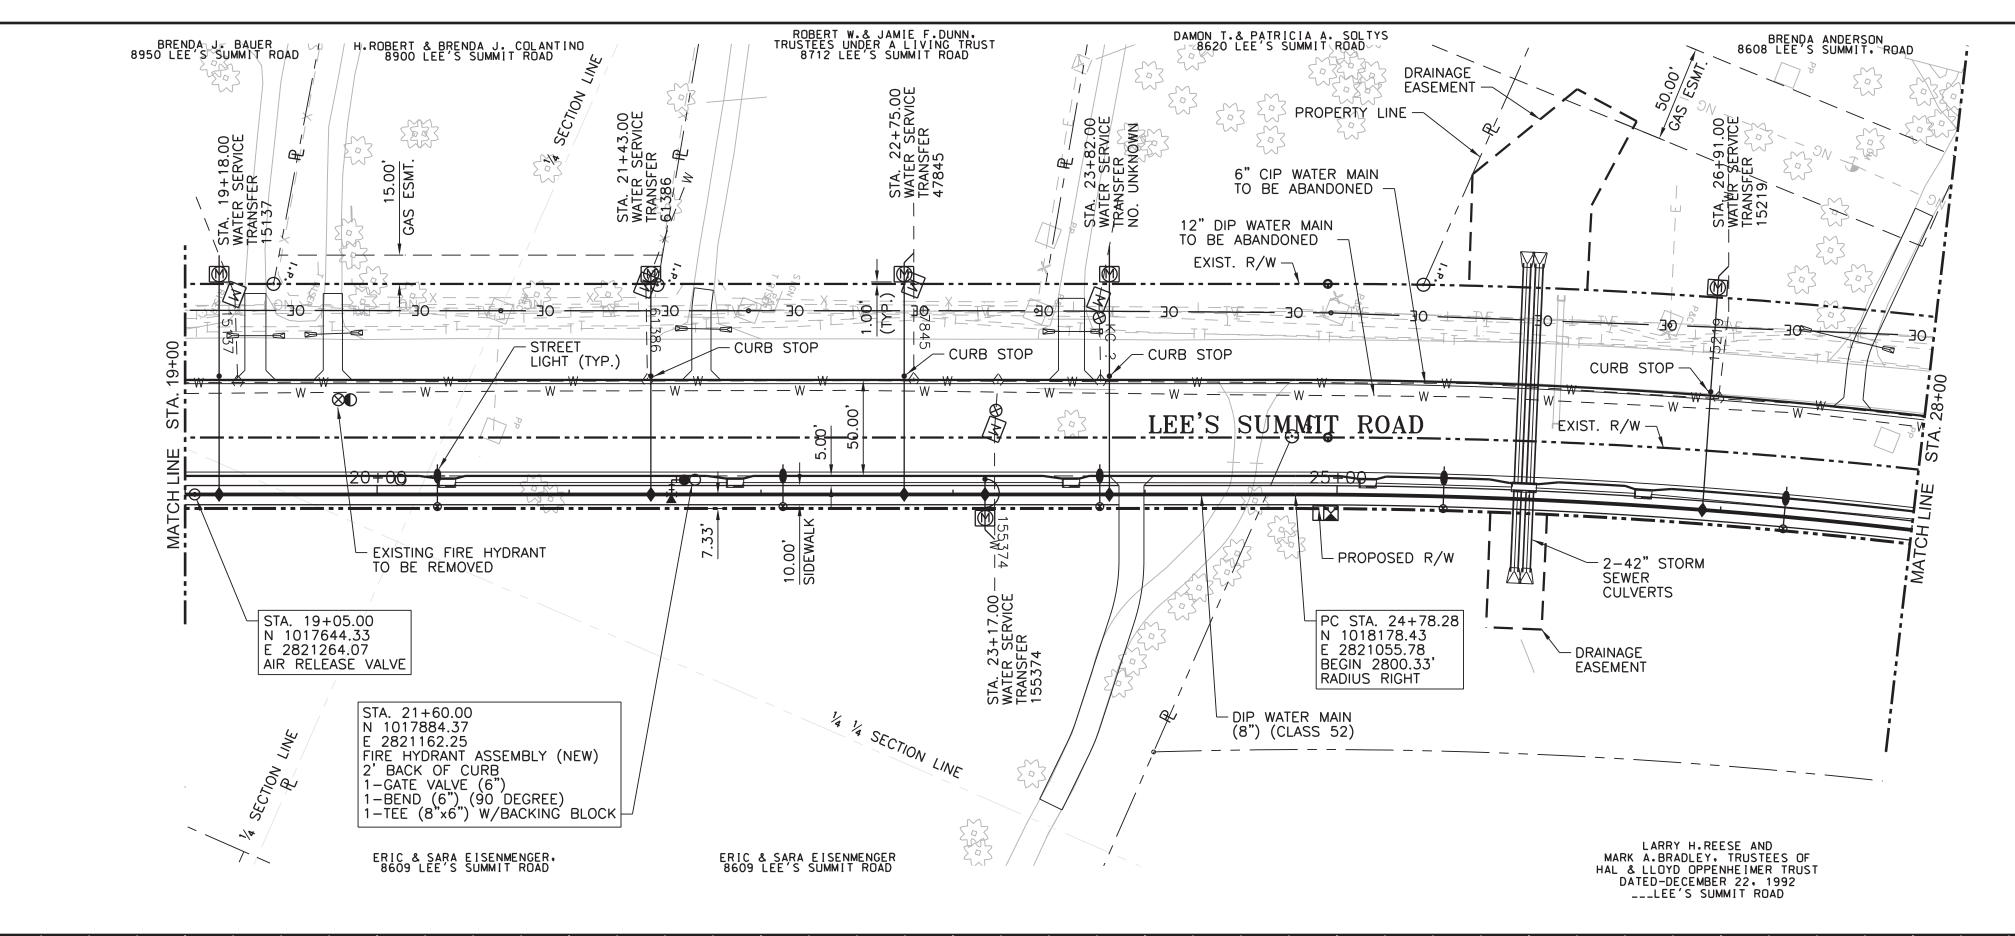

ADDRESS	REGISTER	MAINT	O CURB	CUF	RB IN	INSTALL	INSTALL / RELOCATE METER	
	NUMBER	SIZE	TYPE	SIZE	TYPE	CURB BOX		
8608 Lees Summit Road	15219	3/4 "	K	3/4 "	К	YES	YES	
8609 Lees Summit Road	155374	3/4 "	K	3/4 "	К	YES	YES	
8620 Lees summit Road	XXXXX	3/4"	K	3/4"	К	YES	YES	
8712 Lees Summit Road	47845	3/4"	K	3/4"	К	YES	YES	
8900 Lees Summit Road	61386	3/4"	K	3/4"	К	YES	YES	
8950 Lees Summit Road	15137	3/4"	K	3/4"	К	YES	YES	


 CONTRACTOR TO FIELD VERIFY HORIZONTAL AND VERTICAL LOCATION OF ALL EXISTING UTILITIES AND FIELD ADJUST NEW WATER MAIN AS NECESSARY TO COORDINATE ALL ALIGNMENT MODIFICATIONS WITH THE KANSAS CITY, MO. WATER SERVICES DEPARTMENT.


### <u>LEGEND</u>

933.57 = PROPOSED GRADE ELEV. ABOVE WATER MAIN

933.57 = FLOWLINE ELEV. OF WATER MAIN

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WATER MAIN RELOCATION

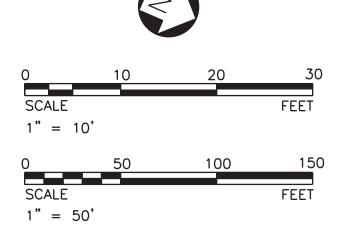LEE'S SUMMIT ROAD

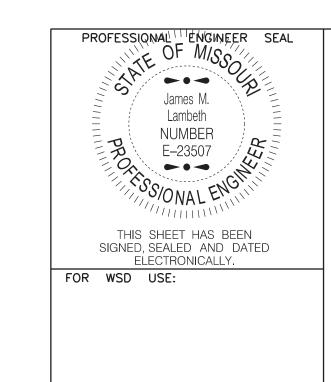
FOR

LEE'S SUMMIT ROAD FROM KCMO CITY LIMITS TO GREGORY BLVD., JACKSON COUNTY, MISSOURI

> 8" MAIN IN LEE'S SUMMIT ROAD PLAN AND PROFILE

DRAWN BY:	CHECKED BY:	DATE S	SUBMITTE	D:	RANGE	TOW	TOWNSHIP		TION
CAS	DRW	01-0	04-2013	,	31W	4	8N	18 8	<b>៤</b> 19
	CONTRACTOR				DA	TE C	OMPLE	ETED	
CONTRACT NO.	CONTRACT DATE		NO.	wo	RK ORDE	R NO.	DRA	WING	NO.
		J-4749 J-5149							-
PROJECT NO.									
					SHEET 5	OF	12		

60		19+61	ח	944.03		00+00 943.48 939.31	942.56 938.21	21+		939.78	00+52 938.29 934.12	•	932.60	23+ 25 25 25 25 25			00+4 00+4 00+4 00+4 00+4	931.39	25+00 930.64 926.47	930.20		930.08 6+0 00+0	930.29	27+00 926.64 18.05.81	931.65	28.282 928.65 928.65	
70	90																										890
970 988 8655 989 8655 980 8655 980 8655 980 980 980 980 980 980 980 980 980 980	00																					SEV.					900
0	0																VPI		VPI ZE			12" STORM		VPI 2.			910
0	0	<u> </u>				VPI		VPI 21	 		VPI 22+00 ELEV.=934			— DIP (	VATER MAIN (CLASS 52)		24+00.00 = 928.03		926.47	-0.5	+00.00			7+00.00			920
970    10	30		$\rightarrow$			20+00.00 7.=939.31				-2.98%	.00			-3.0	4%			-1.56%					0 7707		2.01%	HOLL	930
960  970  970  970  970  970  970  970	.0	00+61		-0.72	%		-2.22%			PROP	OSED															STA. 284	940
90	60									EXI GR(	STING DUND	1	A N	WATER	STA. 23- WATER S TRANSFE	STA. 23+8′. WATER SER	TRANSFER NO. CNKNC							STA, 26+91.0 WATER SERVIC TRANSFER 15.		00	950
70   0   0   0   0   0   0   0   0   0	50		STA, 19+	STA. 19+	A A A A A A A A A A A A A A A A A A A					TA. 21+43.00 ATER SERVICE RANSFER 613.			2+75.00	SERVICE ER 47845	+17.00 ERVICE R 155374	VICE VICE VICE	Z							0 W Z			960
980	0		05.00 4SE VALVE	18.00   RV   CE	200					98																	970
	0																										980

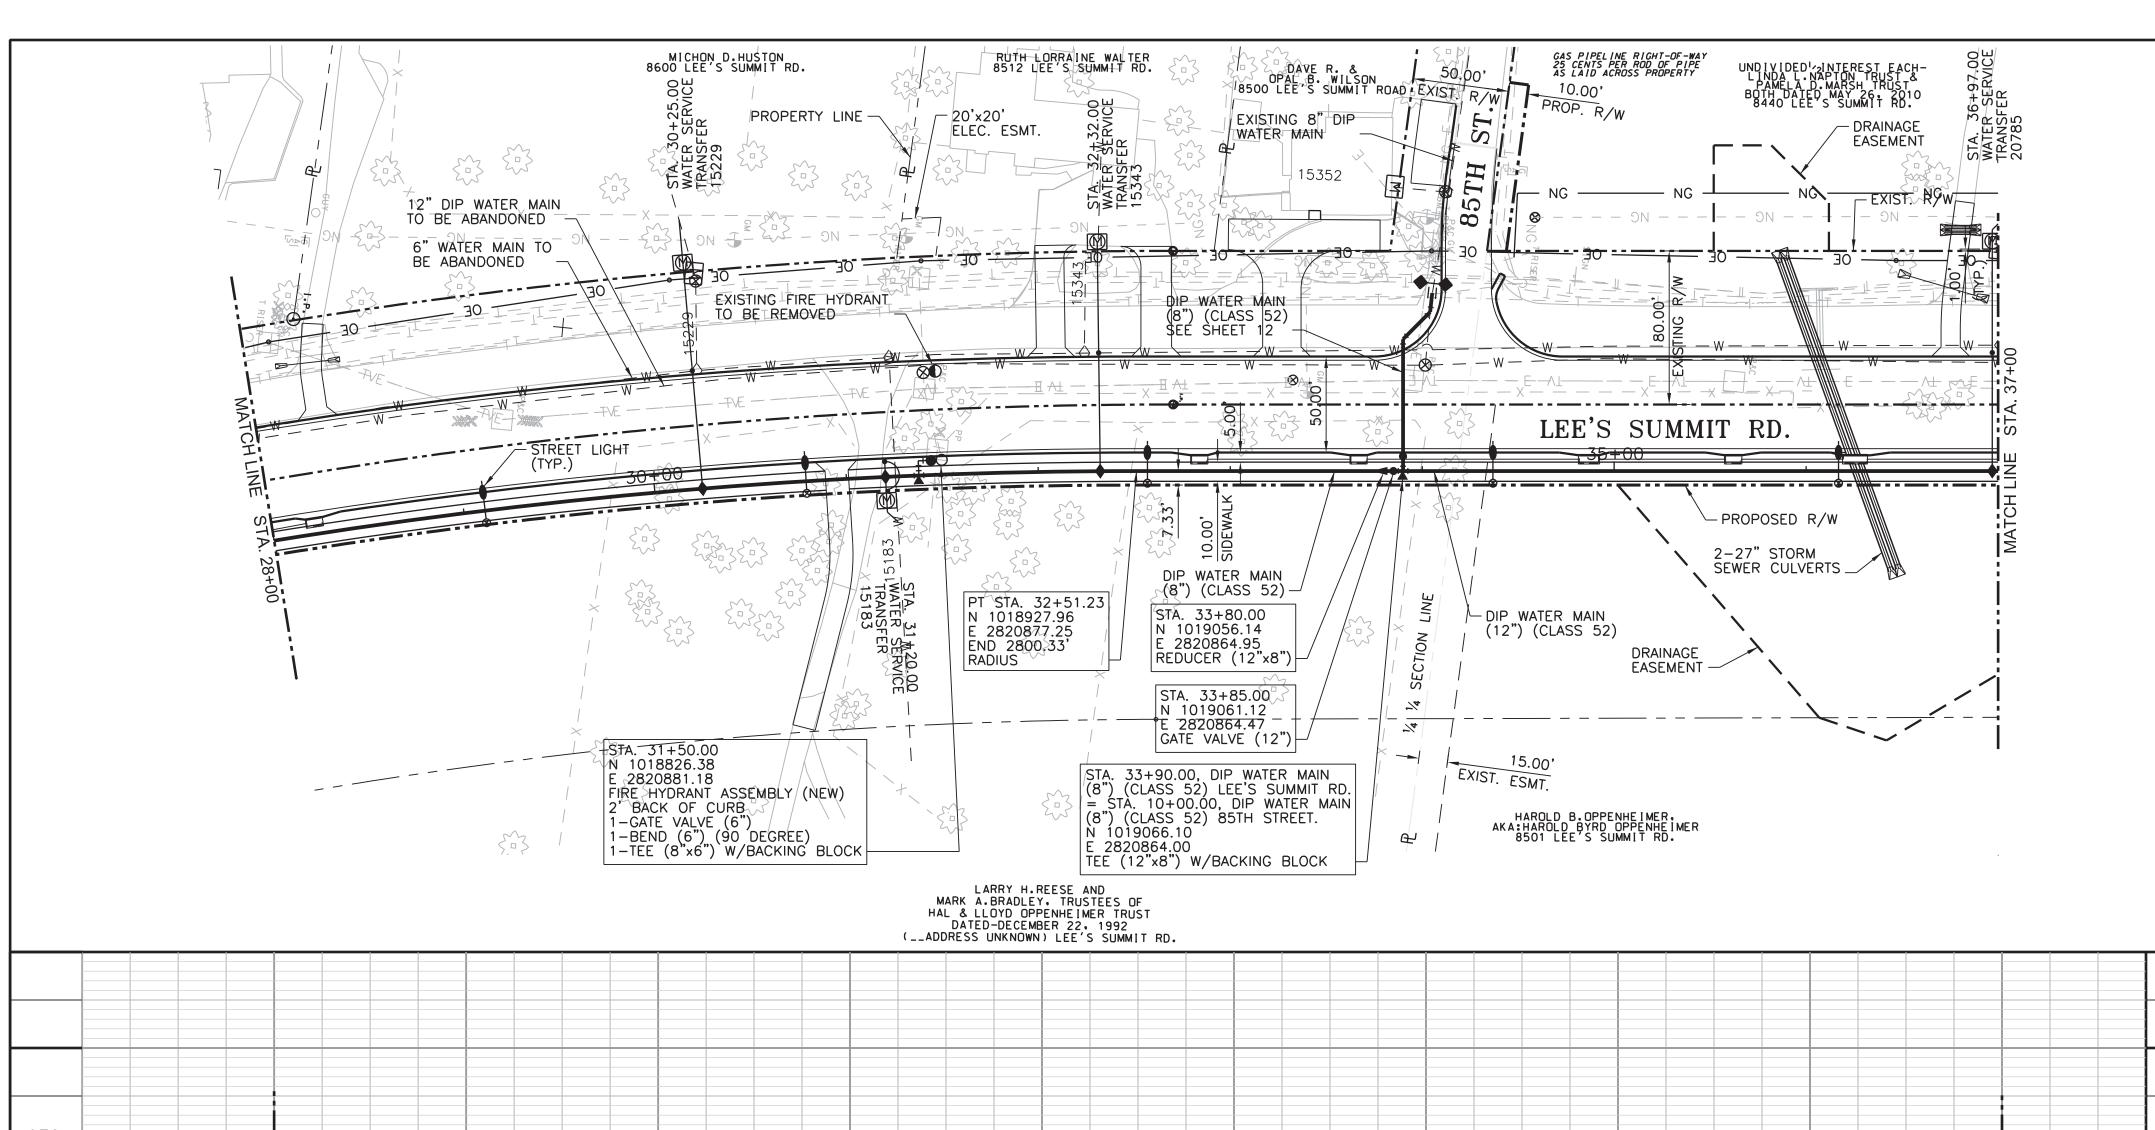

	EXISTING W	ATER SER	VICES TO I	BE TRANSI	FERRED			
ADDRESS	REGISTER NUMBER	MAINT	O CURB	CUF	RBIN	INSTALL CURB BOX	INSTALL / RELOCATE	
	NOWBER	SIZE	TYPE	SIZE	TYPE	COKBBOX	METER	
8440 Lees Summit Road	20785	3/4 "	К	3/4 "	К	YES	YES	
8512 Lees Summit Road	15343	3/4 "	K	3/4 "	К	YES	YES	
xxxxx Lees Summit Road	15183	3/4"	K	3/4"	К	YES	YES	
8600 Lees Summit Road	15229	3/4 "	K	3/4 "	К	YES	YES	


 CONTRACTOR TO FIELD VERIFY HORIZONTAL AND VERTICAL LOCATION OF ALL EXISTING UTILITIES AND FIELD ADJUST NEW WATER MAIN AS NECESSARY TO COORDINATE ALL ALIGNMENT MODIFICATIONS WITH THE KANSAS CITY, MO. WATER SERVICES DEPARTMENT.


### **LEGEND**

935.56 = PROPOSED GRADE ELEV. ABOVE WATER MAIN

931.06 = FLOWLINE ELEV. OF WATER MAIN

THE PROFESSIONAL WHOSE SIGNATURE AND PERSONAL SEAL APPEAR HEREON ASSUMES RESPONSIBILITY ONLY FOR WHAT APPEARS ON THIS PAGE AND DISCLAIMS (PURSUANT TO SECTION 327.411 RSMO) ANY RESPONSIBILITY FOR ALL OTHER PLANS, SPECIFICATIONS, ESTIMATES, REPORTS OR OTHER DOCUMENTS OR INSTRUMENTS NOT SEALED BY THE UNDERSIGNED PROFESSIONAL RELATING TO OR INTENDED TO BE USED FOR ANY PART OR PARTS OF THE PROJECT TO WHICH THIS PAGE REFERS.

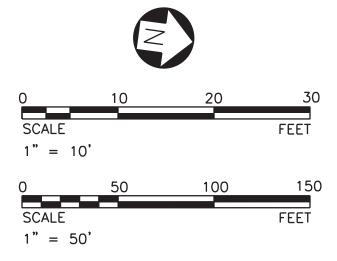

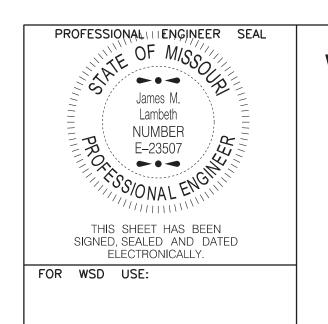

WATER MAIN RELOCATION

FOR LEE'S SUMMIT ROAD


LEE'S SUMMIT ROAD FROM KCMO CITY LIMITS TO GREGORY BLVD.,

JACKSON COUNTY, MISSOURI

8" AND 12" MAIN IN LEE'S SUMMIT ROAD PLAN AND PROFILE

DRAWN BY:	CHECKED BY:	DATE S	SUBMITTE	D:	RANGE	TOW	NSHIP	SEC	TION
CAS	DRW	01-0	04-2013	5	31W	4	18N	18 8	k 19
	CONTRACTOR				DA	ATE (	COMPL	TED	
CONTRACT NO.	CONTRACT DATE	J-4749	NO. J-4949 J-5151	wo	RK ORDE	R NO	DRA	WING	NO.
PROJECT NO.									
					SHEET	6 OF	12		

50   10   10   10   10   10   10   10																								
50	70								0)		8													970
0 0 0 0 0 0 0 0 0 0 0 0 0 0 0 0 0 0 0	50								FA. 30+25.00 ATER SERVICE RANSFER 1522	A. 31+20.00	ATER SERVICE SANSFER 1518			32+32.00 ER SERVICE USFER 15343									WICE 20785	960
10	50										X I			STA. WATE				/- E	XISTING ROUND				WATER SER	950
10	FO	TA. 28									/	` ` ` ` `								– PROPOSED			A. 37+	940
100   100	.0	Ш		3.0	7%		1.96%	0	0.15%	200	-1.	21%			-2.66%									930
STA STORE COLUMN STATE COLUMN S	0	Σ	+00.00 928.65			1 29+00.00		VPI 30+00.0 ELEV.=933.6		VPI 31+00.0 ELEV.=933.8			PI 32+00.00 LEV.=932.61		DIP WATER (8") (CLASS	MAIN (5 52) (1 2 1	ET. MAIN		000		.36	1.09	NA NA	920
	0		VPI 28 ELEV:			<u>Q</u>							> ш			STA 33+8 REDUCER DIP WATER	OG, DIP WATE / BACKING BL VPI 34+	E	VPI 35+00	L C C C C C C C C C C C C C C C C C C C	VPI 36+00 ELEV.=925	I Iř		910
	00															STA. 33+90.00, (8") (CLASS 52	= STA. 10+00. (8") (CLASS 52 IEE (12"x8") W							900
		88	8.65	.30	<u>x</u>	935.88	937.07	937.84	938.20 933.75	937.99	.67	3.22	936.78 932.61	935.49	934.11	932.73	921.53	930.40	367	925.52 929.81 925.44	929.39 925.36	930.48 925.91	931.28	

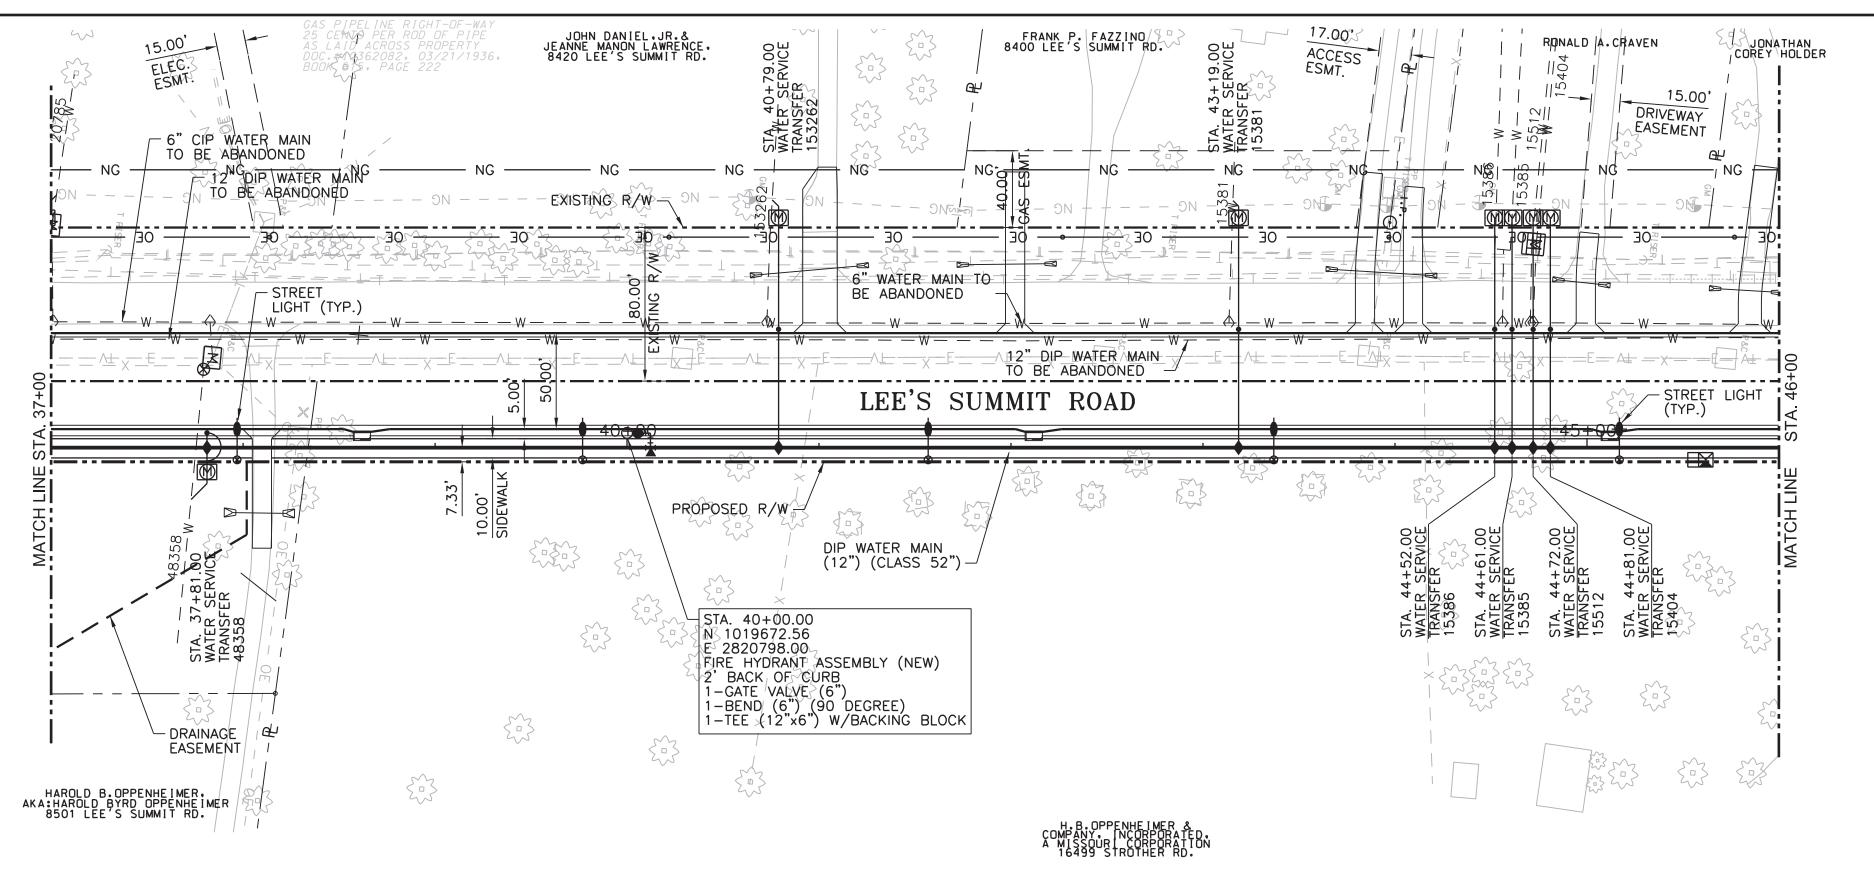

	REGISTER	MAINT	O CURB	CUF	RBIN	INSTALL	INSTALL /
ADDRESS	NUMBER	SIZE	TYPE	SIZE	TYPE	CURB BOX	RELOCATE METER
XXXX Lees Summit Road	15404	3/4 "	K	3/4 "	K	YES	YES
XXXX Lees Summit Road	15512	3/4 "	K	3/4 "	K	YES	YES
XXXX Lees Summit Road	15385	3/4 "	K	3/4 "	K	YES	YES
XXXX Lees Summit Road	15386	3/4 "	K	3/4 "	K	YES	YES
8400 Lees Summit Road	15381	3/4 "	K	3/4 "	К	YES	YES
8420 Lees Summit Road	153262	3/4 "	K	3/4 "	K	YES	YES
8501 Lees Summit Road	48358	3/4 "	К	3/4 "	K	YES	YES


1. CONTRACTOR TO FIELD VERIFY HORIZONTAL AND VERTICAL LOCATION OF ALL EXISTING UTILITIES AND FIELD ADJUST NEW WATER MAIN AS NECESSARY TO COORDINATE ALL ALIGNMENT MODIFICATIONS WITH THE KANSAS CITY, MO. WATER SERVICES DEPARTMENT.


### **LEGEND**

976.83 = PROPOSED GRADE ELEV. ABOVE WATER MAIN

976.83 = FLOWLINE ELEV. OF WATER MAIN

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KANSAS CITY, MISSOURI, WATER SERVICES DEPARTMENT
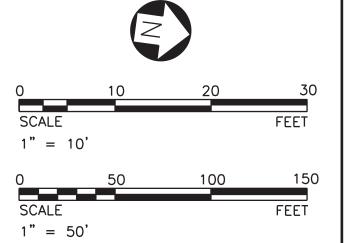
## WATER MAIN RELOCATION FOR

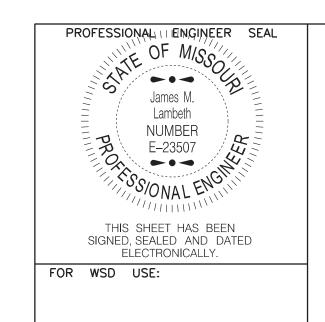
LEE'S SUMMIT ROAD

LEE'S SUMMIT ROAD FROM KCMO CITY LIMITS TO GREGORY BLVD., JACKSON COUNTY, MISSOURI

> 12" MAIN IN LEE'S SUMMIT ROAD PLAN AND PROFILE

DRAWN BY:	CHECKED BY:	DATE S	SUBMITTE	D:	RANGE	TOWN	NSHIP	SEC	TION
CAS	DRW	01-0	04-2013	,	31W	48	BN	18 8	k 19
	CONTRACTOR				DAT	E C	OMPLE	TED	
CONTRACT NO.	CONTRACT DATE	J-4749	NO. J-4949 J-5151	WO	RK ORDER	NO.	DRAI	WING	NO.
PROJECT NO.									
					SHEET 7	OF	12		

										(	WATER SERVICE TRANSFER 15386	WATER SERVICE TRANSFER 15385	STA, 44+72.00 WATER SERVICE TRANSFER 15512	STA, 44+81.00 WATER SERVICE TRANSFER 15404		99
									-19.00 ERVICE 3 15381		WATER TRANSFE	WATER STE	STA. 44. WATER S	STA. 44. WATER S TRANSFE		98
				562			EXISTING GROUNE	G	STA. 43+19.00 WATER SERVICE TRANSFER 15381							9
				STA, 40+79.00 WATER SERVICE TRANSFER 153262	Z Z	PROPOSE GRADE	GROUNL				,^					9
37+00 STA. 37+81.00 WATER SERVICE TRANSFER 48358				ST					5.88							9
							DIP WAT (12") ((	TER MAIN CLASS 52")							CO	9
CH LINE STA		5.16														9
2.03	97	39+50.00 V.=934.67	VPI 40+00.00 ELEV.=937.25													9
VPI 37+00.00 ELEV.=926.46 VPI 37+50.00 ELEV.=927.48	VPI 38+50.00 ELEV.=930.45	E E E														9
	928.96 935.56 930.45	937.61 932.56 939.98 934.67	942.66	948.61	951.61	954.61	957.61 951.96	960.61	963.61	966.61		969.61 963.73	972.61	975.61	978.61 972.56	

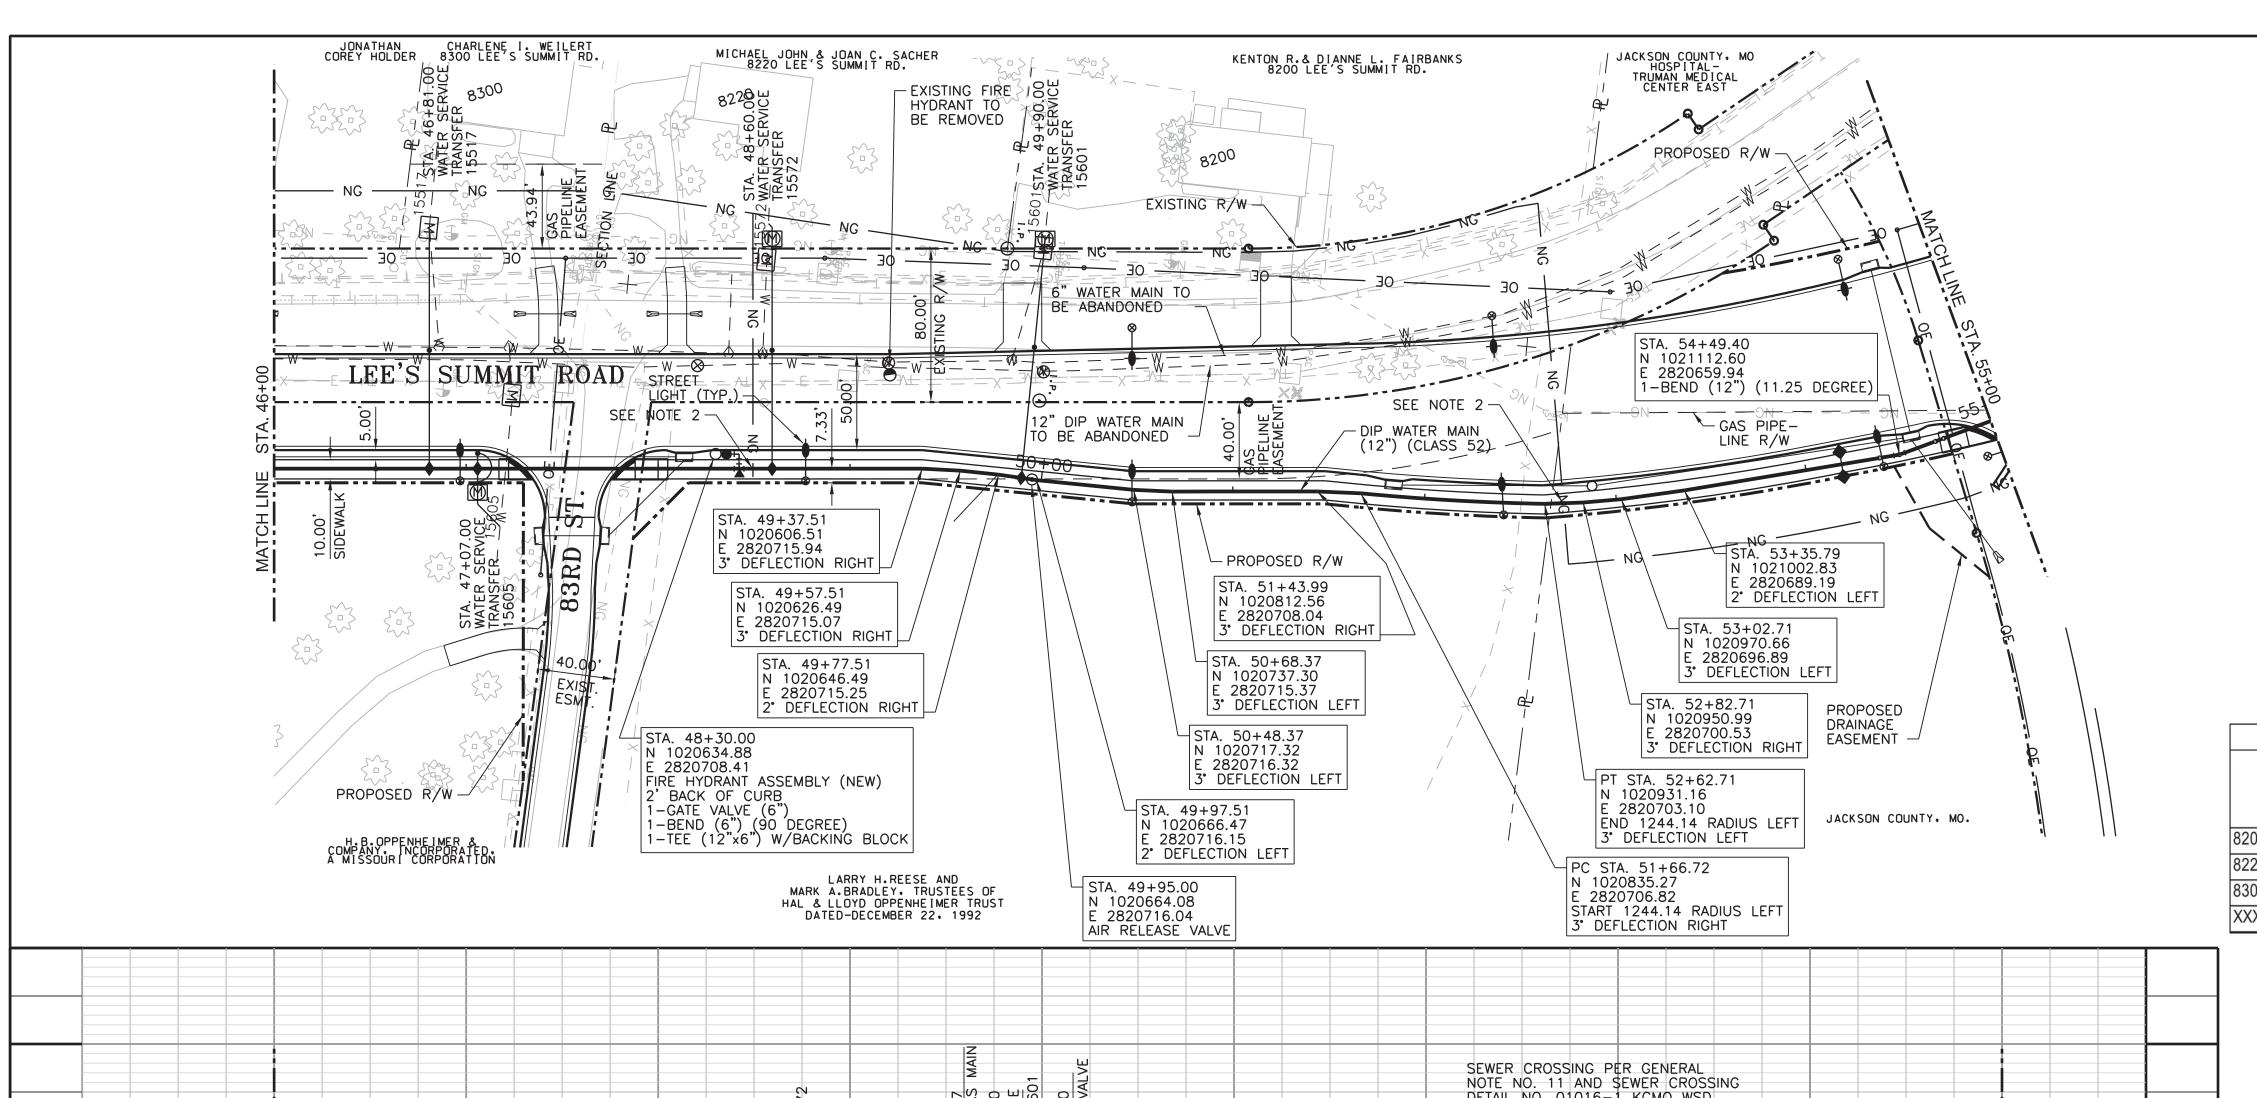

	EXISTING W	ATER SER	VICES TO E	BE TRANSF	ERRED		
ADDRESS	REGISTER NUMBER	MAINT	O CURB	CUR	BIN	INSTALL CURB BOX	INSTALL / RELOCATE
	NOMBLK	SIZE	TYPE	SIZE	TYPE	CONDIDOX	METER
8200 Lees Summit Road	15601	3/4"	K	3/4"	K	YES	YES
8220 Lees Summit Road	15572	3/4"	K	3/4"	K	YES	YES
8300 Lees Summit Road	15517	3/4"	K	3/4"	K	YES	NO
XXXX Lees Summit Road	15605	3/4"	K	3/4"	K	YES	YES


- 1. CONTRACTOR TO FIELD VERIFY HORIZONTAL AND VERTICAL LOCATION OF ALL EXISTING UTILITIES AND FIELD ADJUST NEW WATER MAIN AS NECESSARY TO COORDINATE ALL ALIGNMENT MODIFICATIONS WITH THE KANSAS CITY, MO. WATER SERVICES DEPARTMENT.
- 2. DOUBLE POLYWRAP WATER MAIN 10' EACH SIDE WHERE CROSSING GAS MAIN. DOUBLE POLY—WRAP TO BE CONSIDERED SUBSIDARY TO QUANTITIES.


### LEGEND

974.65 = PROPOSED GRADE ELEV. ABOVE WATER MAIN

974.65 = FLOWLINE ELEV. OF WATER MAIN

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WATER MAIN RELOCATION

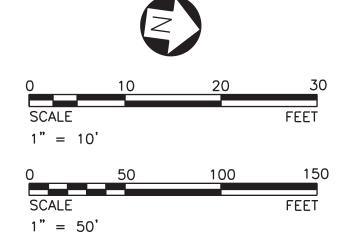
LEE'S SUMMIT ROAD

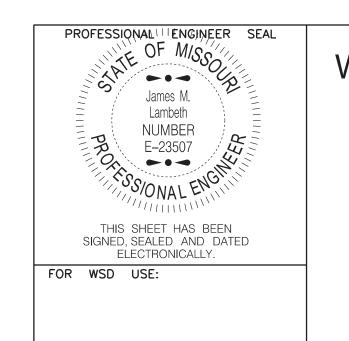
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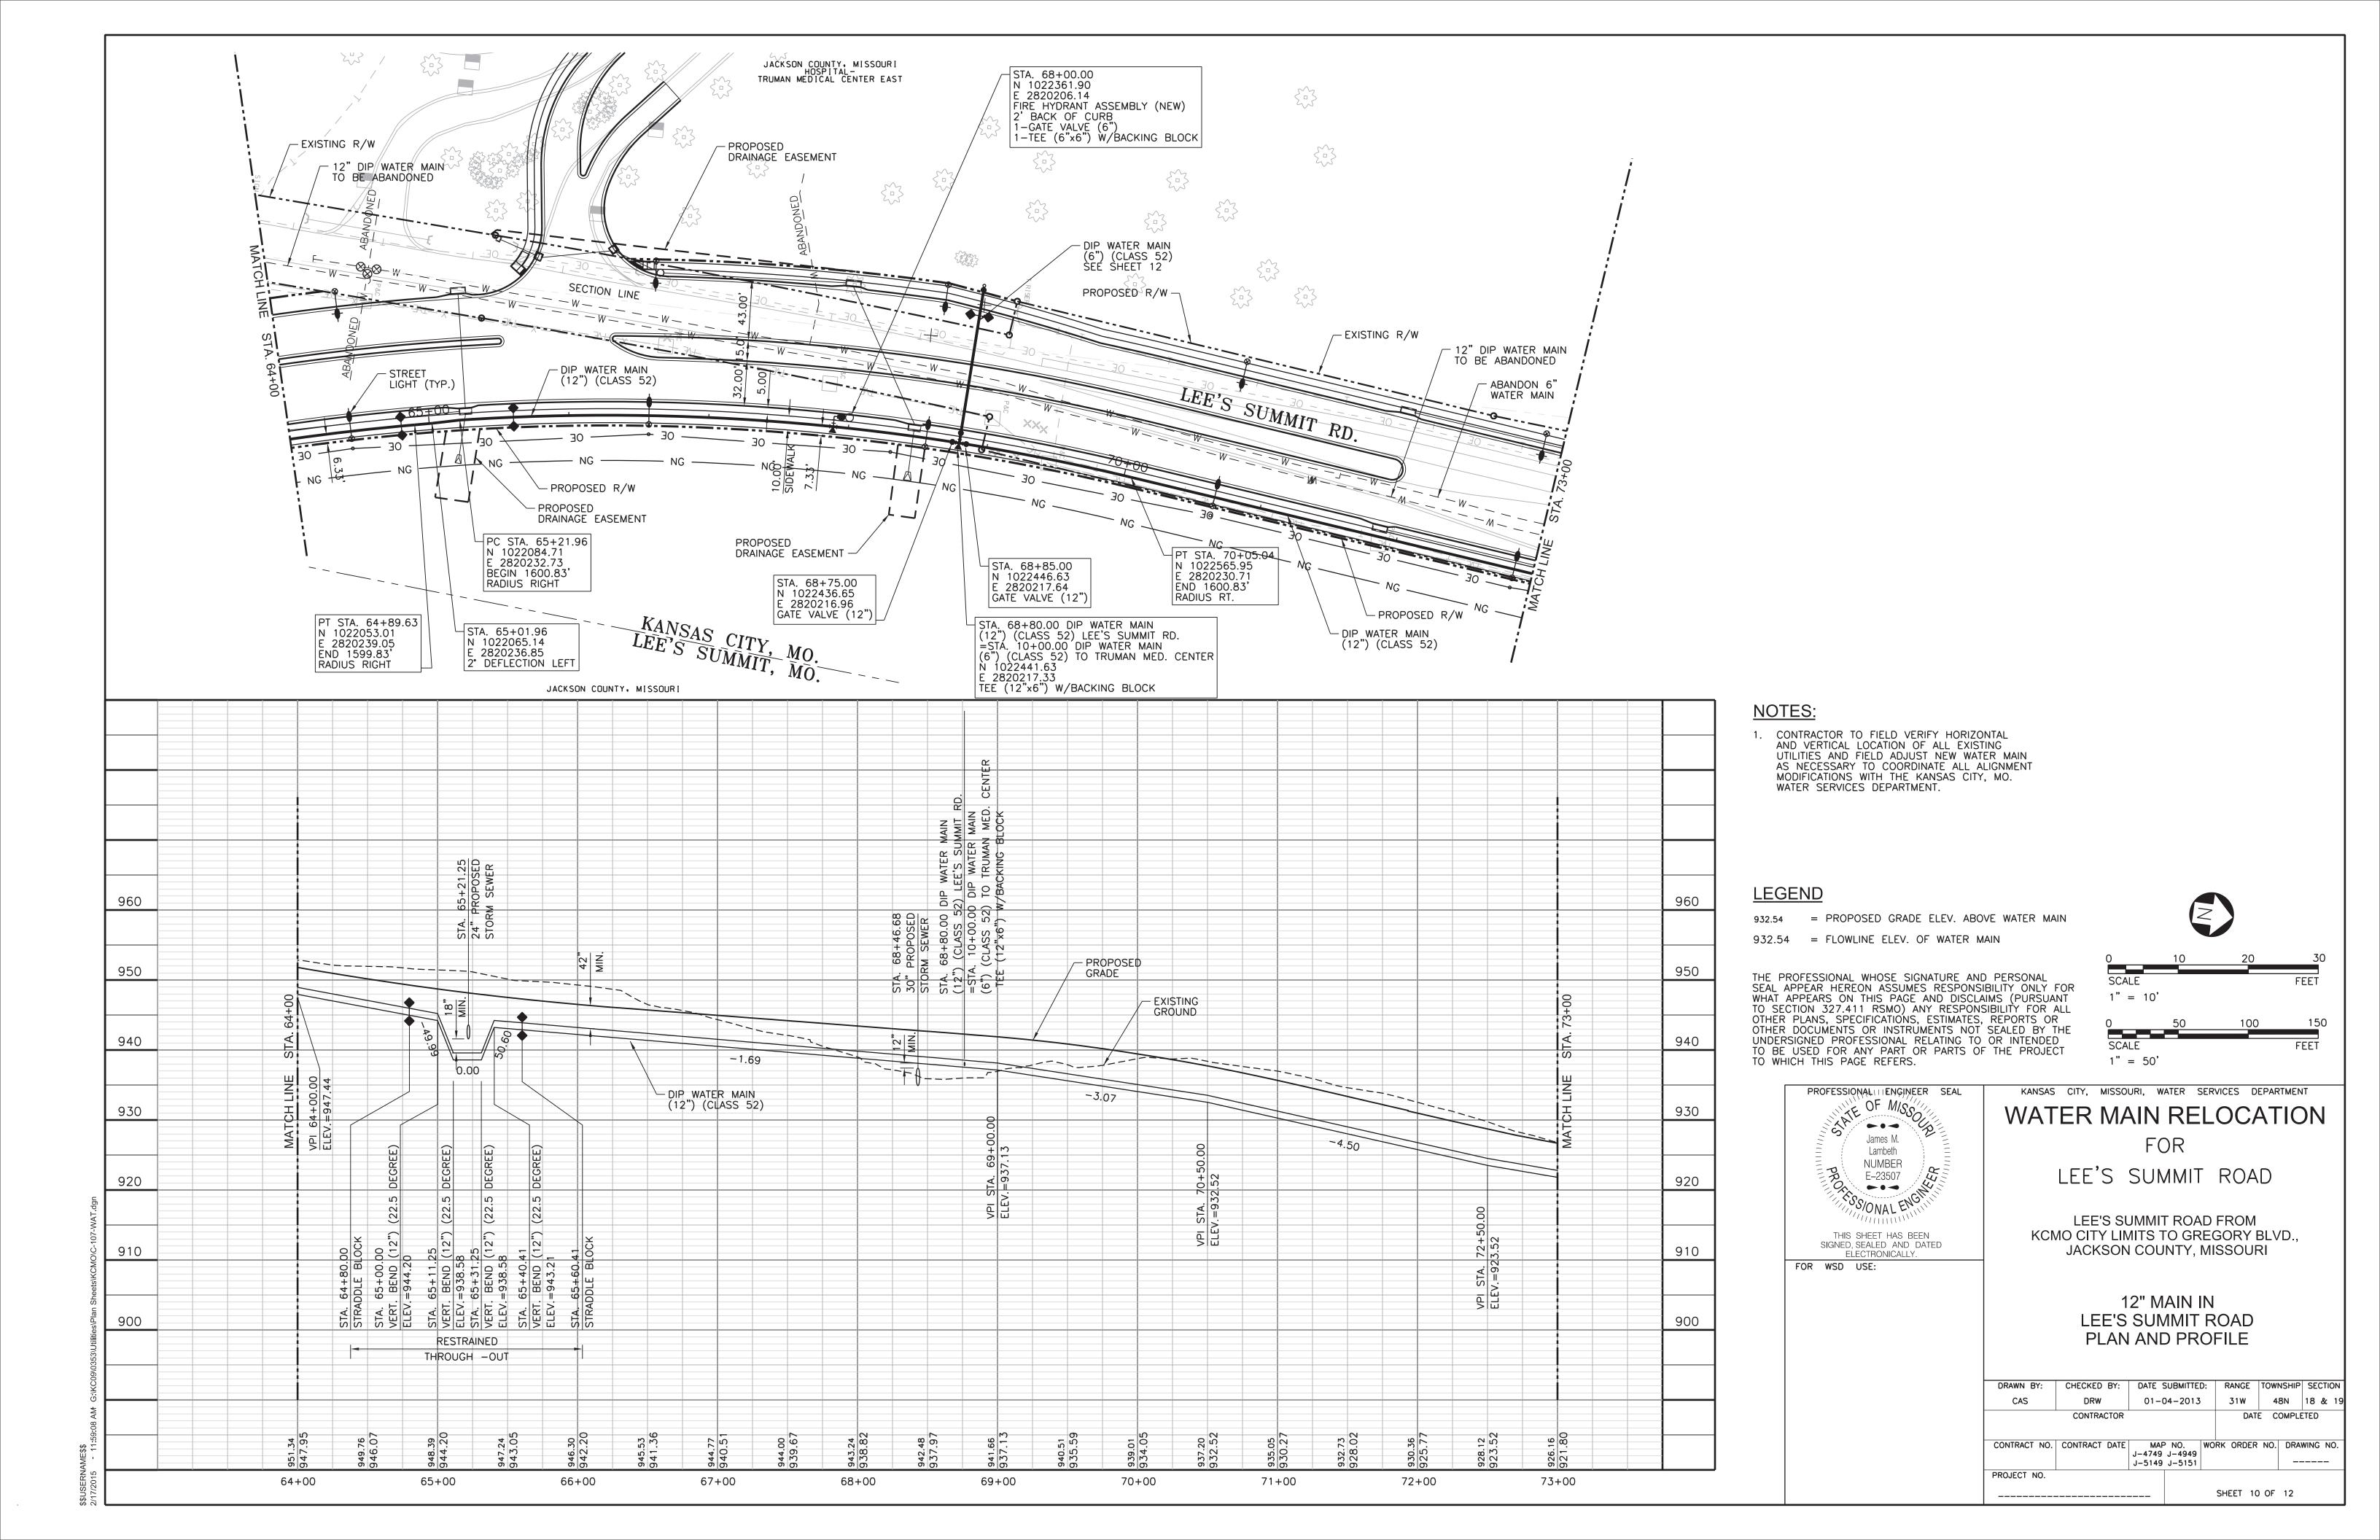
LEE'S SUMMIT ROAD FROM KCMO CITY LIMITS TO GREGORY BLVD., JACKSON COUNTY, MISSOURI


> 12" MAIN IN LEE'S SUMMIT ROAD PLAN AND PROFILE


DRAWN BY:	CHECKED BY:	DATE S	SUBMITTE	D:	RANGE	TOW	NSHIP	SE	CTI	NC
CAS	DRW	01-0	04-2013	,	31W	4	8N	18	&	19
	CONTRACTOR				DATI	E C	OMPLE	TED		
CONTRACT NO.	CONTRACT DATE	MAF J-4749	NO.	wo	RK ORDER	NO.	DRA	WINC	N	0.
		J-5149								
PROJECT NO.										
					SHEET 8	OF	12			
			!							



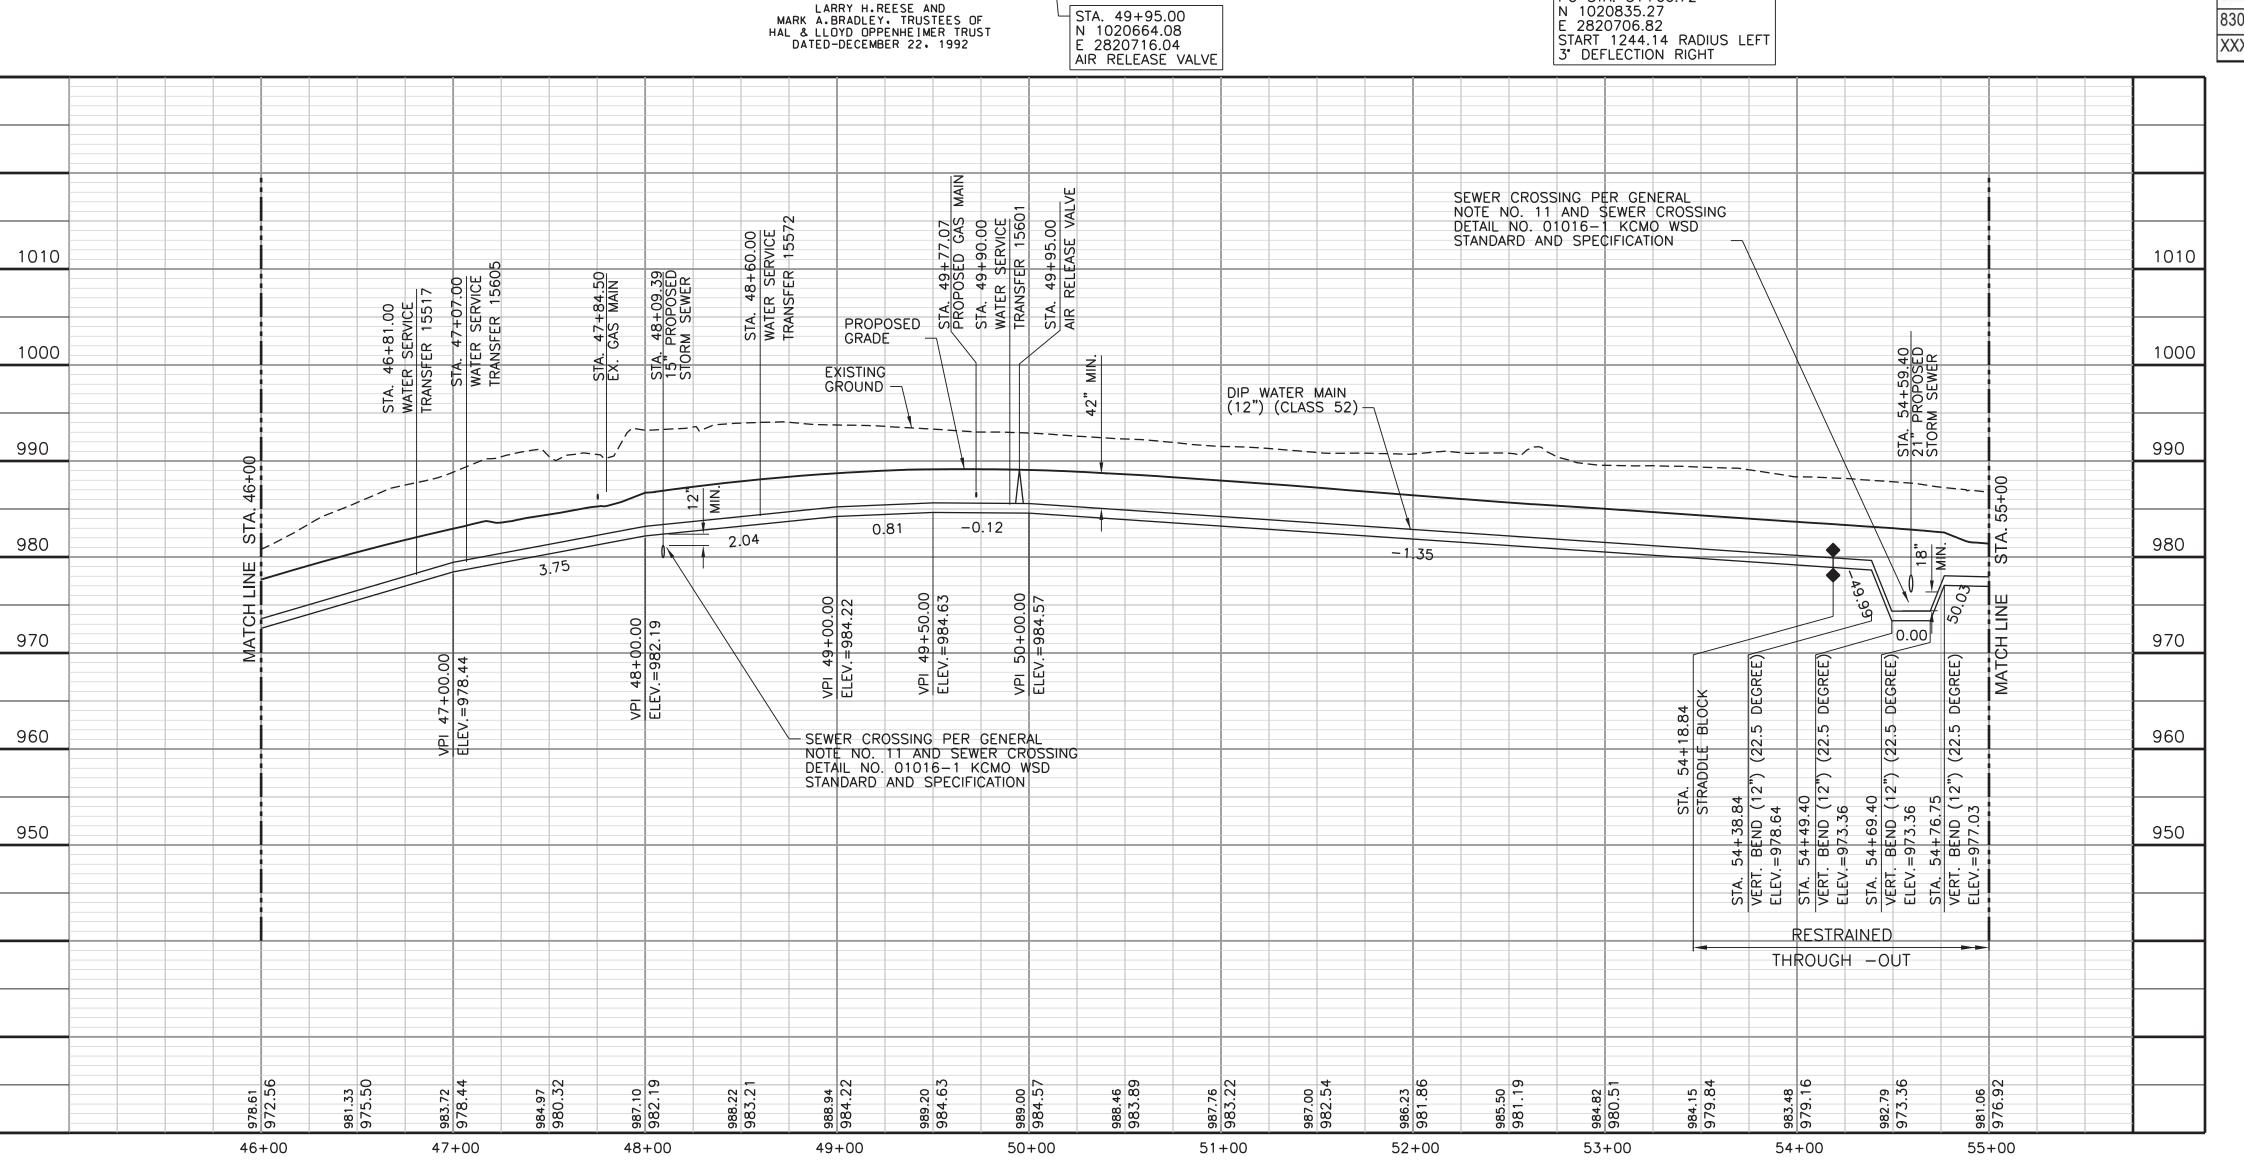

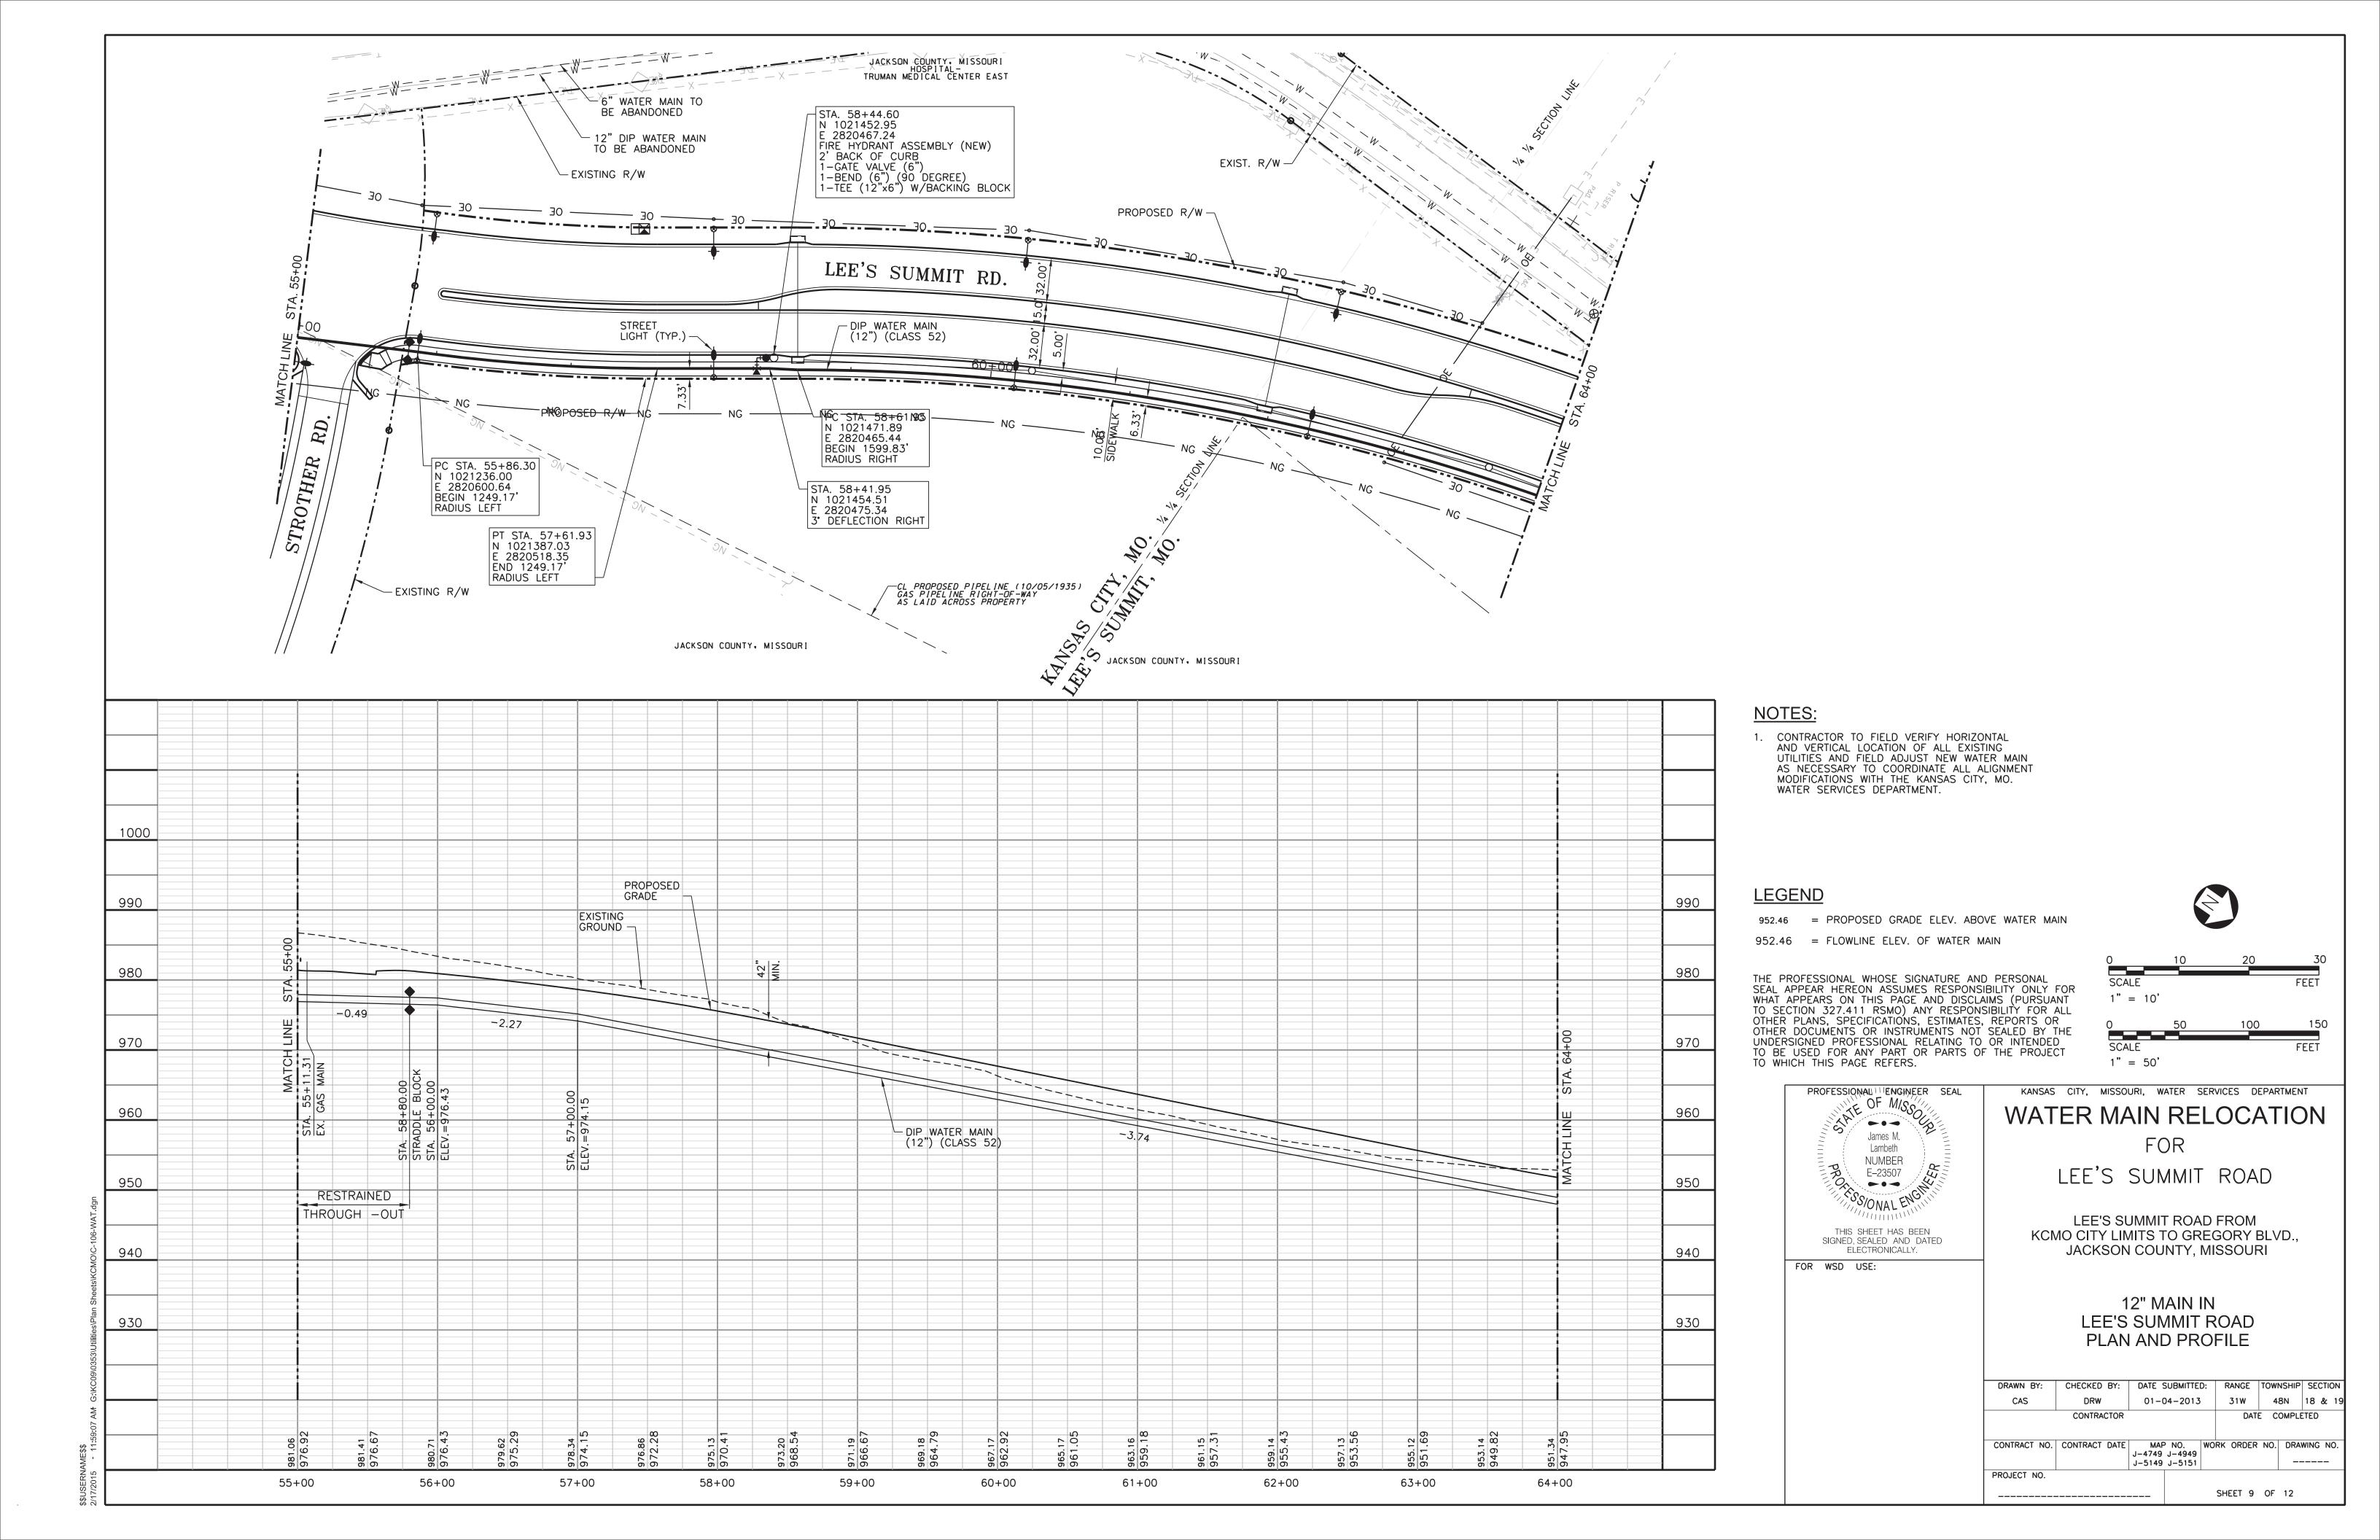

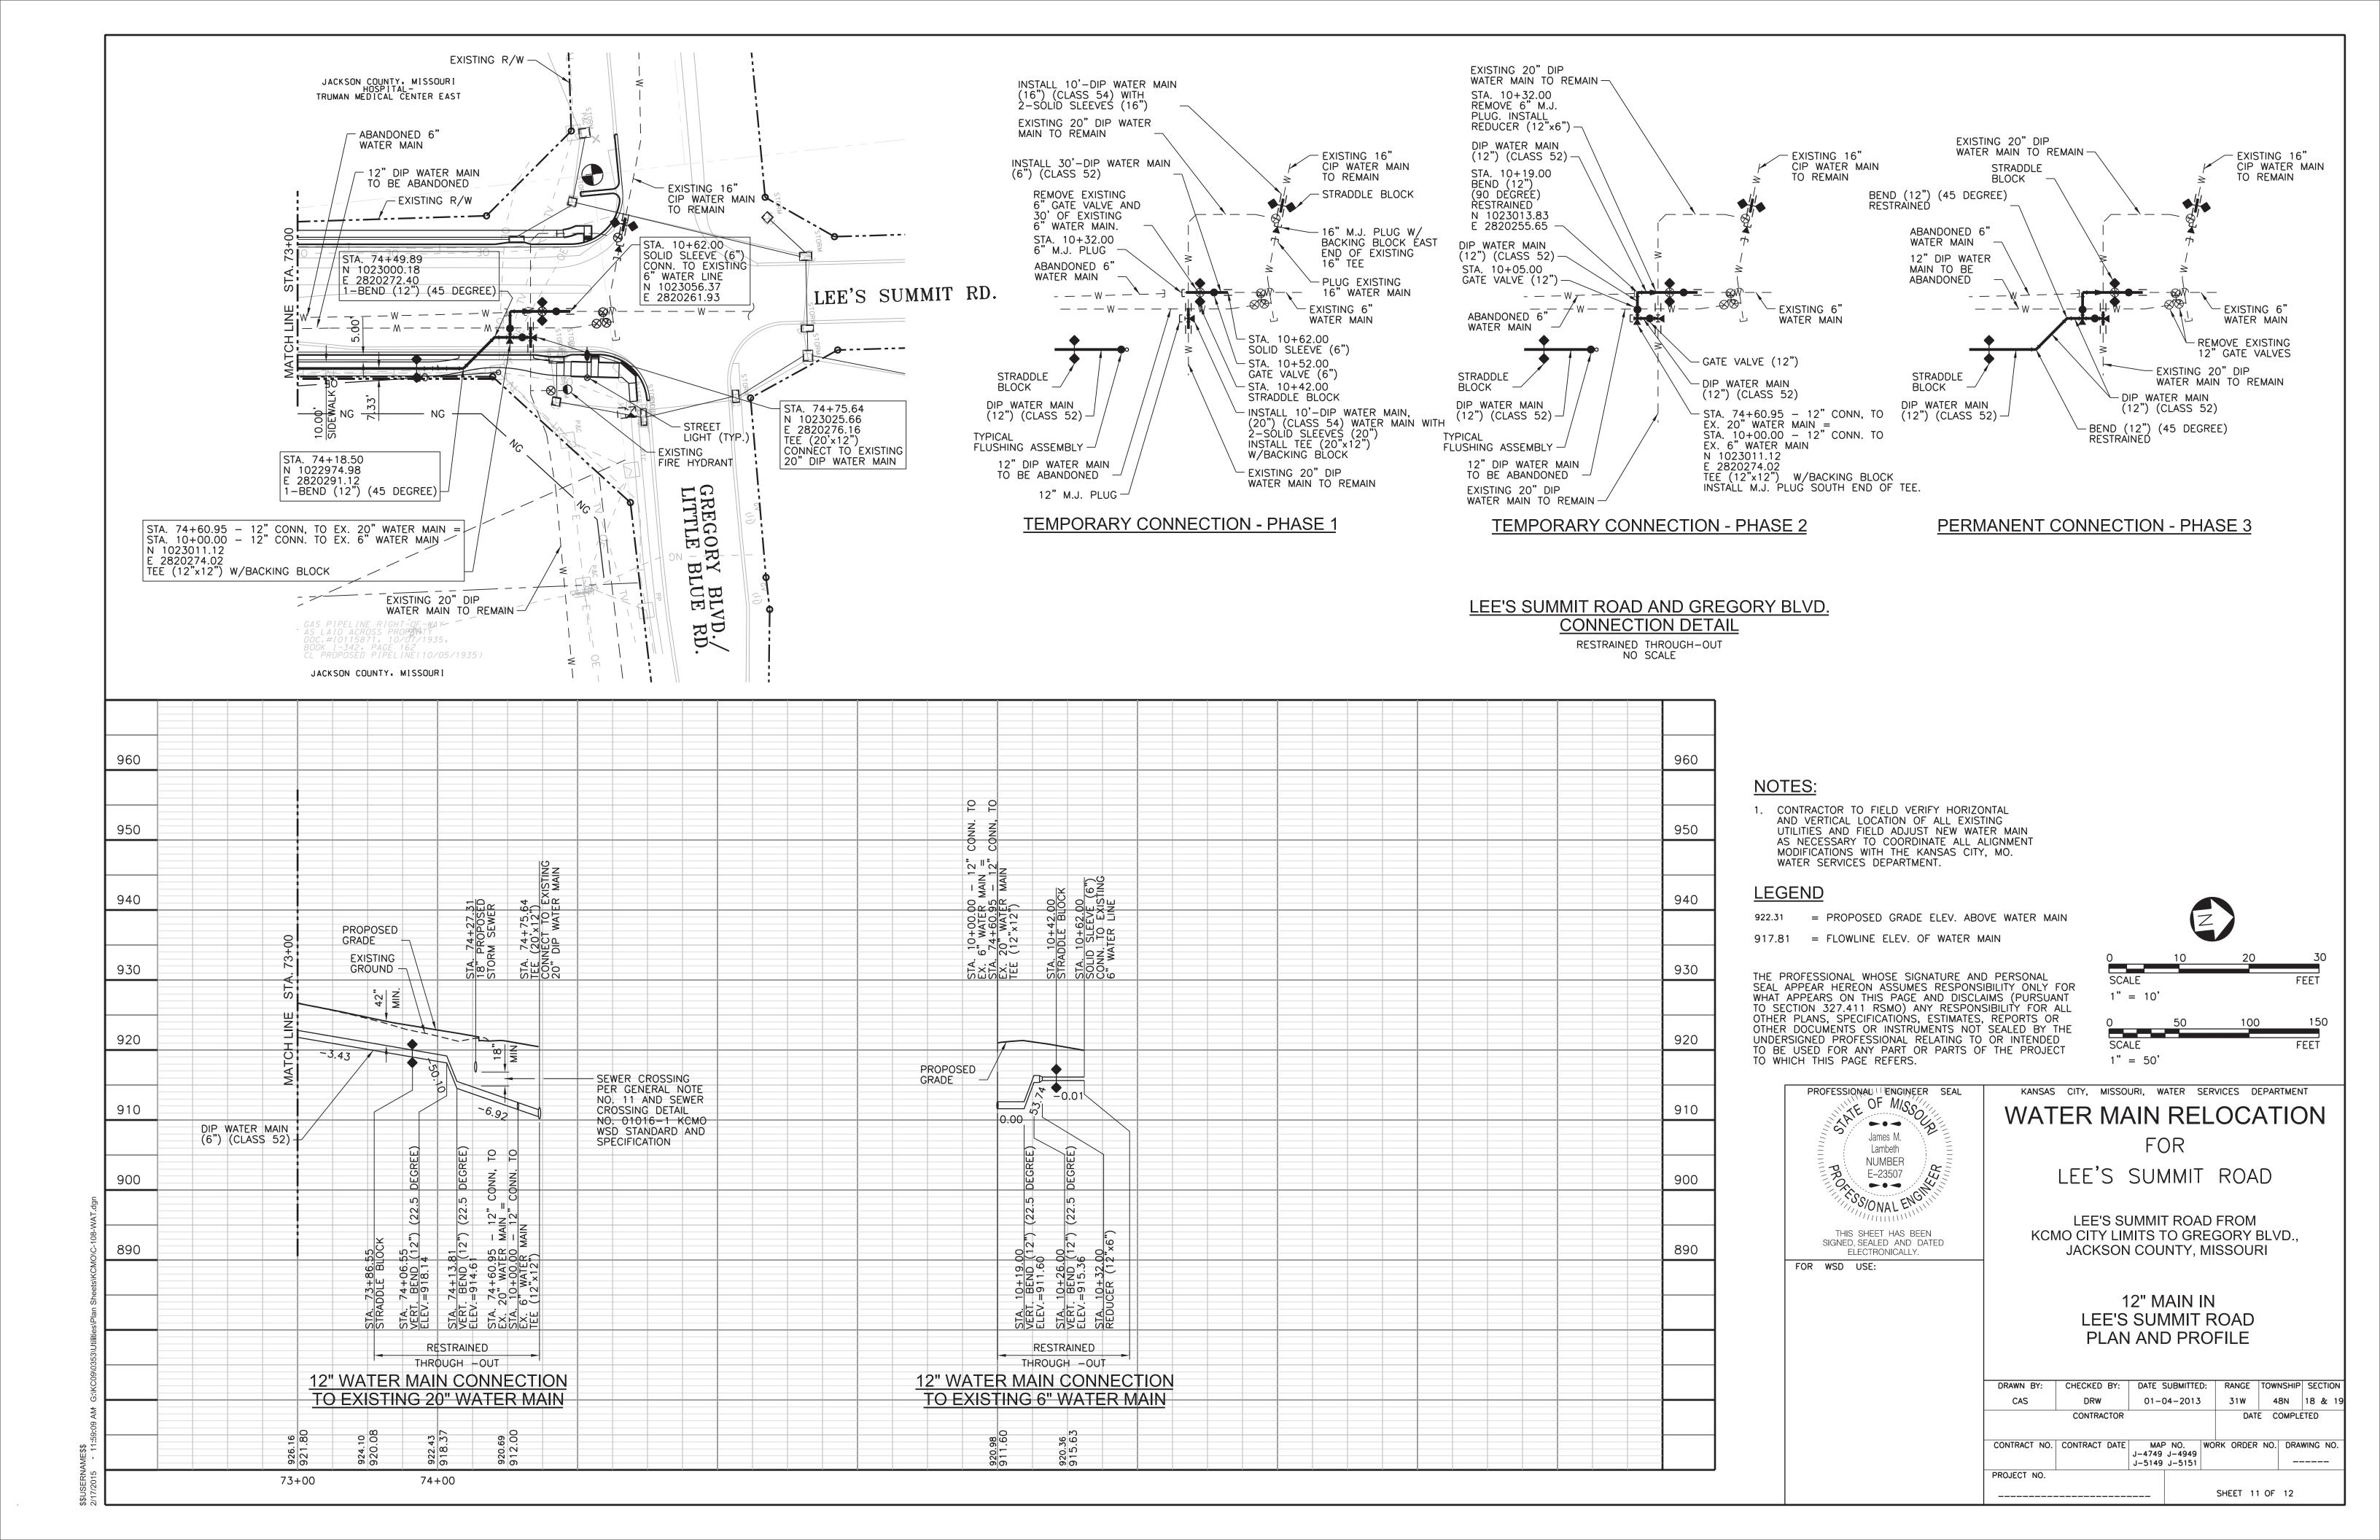

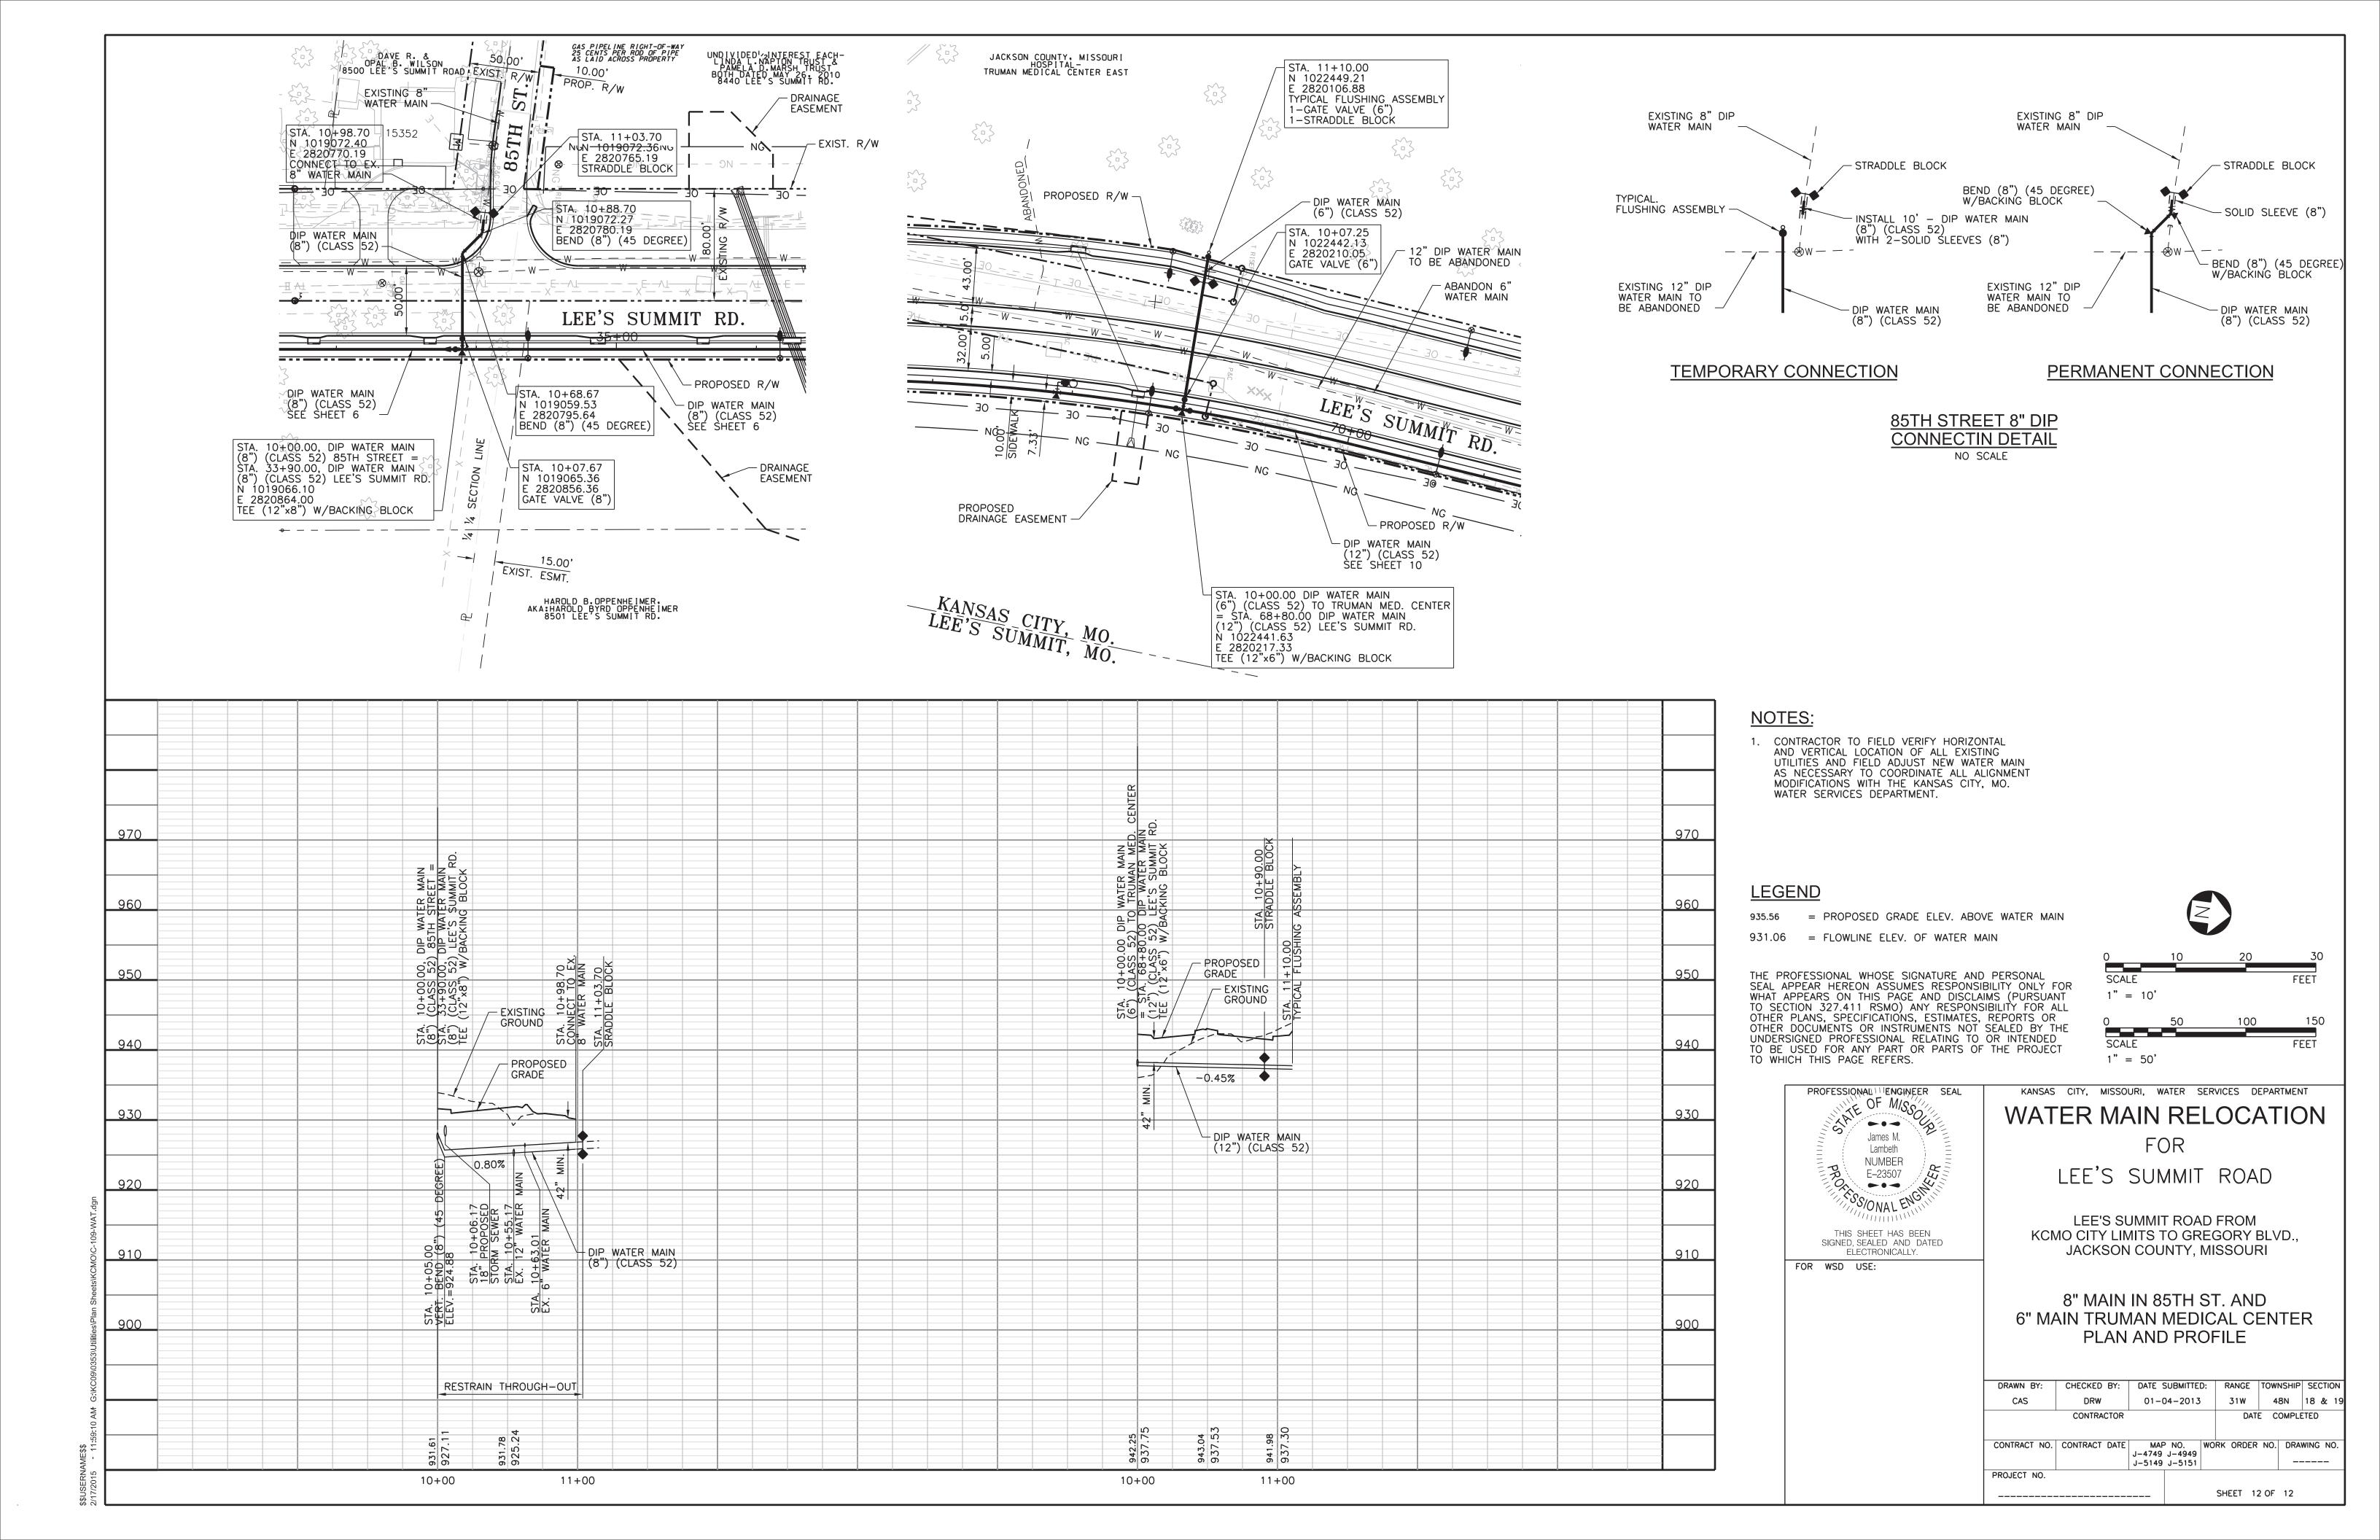



PUBLIC WORKS ENGINEERING DIVISION | 220 SE GREEN STREET | LEE'S SUMMIT, MO 64063

# DOUGLAS ST. & LEE'S SUMMIT ROAD FROM COLBERN ROAD TO KCMO CITY LIMITS

## WATER MAIN RELOCATION

LEE'S SUMMIT, JACKSON COUNTY, MISSOURI PROJECT NO. 363161-C



### **UTILITY NOTES:**

VISUAL INDICATIONS OF UTILITIES ARE AS SHOWN.
UNDERGROUND LOCATION SHOWN, AS FURNISHED BY
THEIR LESSORS, ARE APPROXIMATE AND SHOULD BE
VERIFIED IN THE FIELD AT THE TIME OF CONSTRUCTION.
FOR ACTUAL FIELD LOCATIONS OF UNDERGROUND UTILITES,
CALL 1-800-344-7483, MISSOURI. LAW REQUIRES YOU TO
CALL 48 HOURS BEFORE YOU DIG.


### **EMERGENCY UTILITY NUMBERS**

KCP&L - DWIGHT HICKS 816 - 347 - 4309
COMCAST COMMUNICATIONS - STEVE CROMWELL 816 - 795 - 2257
MISSOURI GAS ENERGY - BECCA ORR 816 - 969 - 2230
AT&T - MARK MANION 816 - 325 - 6516
LEE'S SUMMIT WATER UTILITIES 816 - 969 - 1940
MODOT SIGNALS - MARK DURHAM 816 - 356 - 4748

### PLANS PREPARED BY:




2400 PERSHING ROAD SUITE 400 KANSAS CITY, MISSOURI 64108 PHONE: 816-329-8600 FAX: 816-329-8601 CONTACT: MITCH LAMBETH

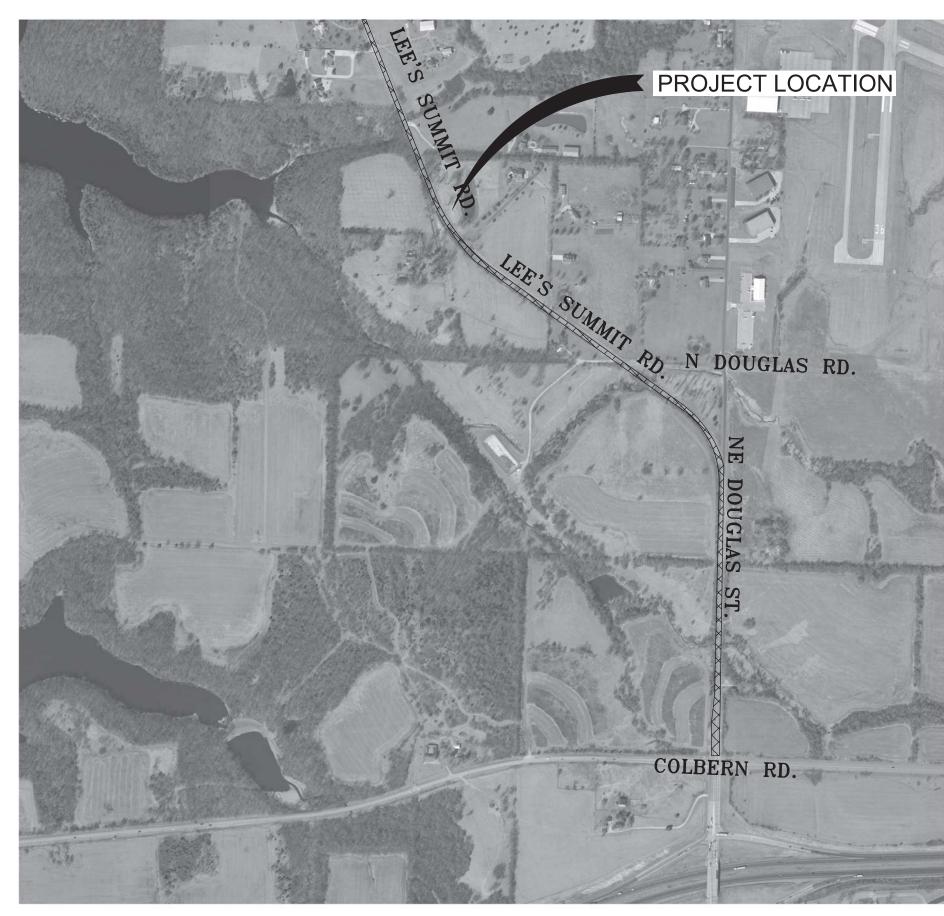

## NO SCALE

### INDEX OF SHEETS

SHEET NO. TITLE  G-001 COVER SHEET  G-002 GENERAL NOTES, LAYOUT AND SUMMARY OF QUANTITIES  G-003 CONTROL DATA SHEET  LS-101 16" WATER MAIN PLAN AND PROFILE STA. 10+00 - 20+00  LS-102 16" WATER MAIN PLAN AND PROFILE STA. 20+00 - 31+00  LS-103 20" WATER MAIN PLAN AND PROFILE STA. 10+00 - 21+00  LS-104 20" WATER MAIN PLAN AND PROFILE STA. 21+00 - 30+00  LS-105 12" WATER MAIN PLAN AND PROFILE STA. 21+00 - 20+00  LS-106 8" AND 12" WATER MAIN PLAN AND PROFILE STA. 20+00 - 30+00  LS-107 8" WATER MAIN PLAN AND PROFILE STA. 30+00 - 40+00  LS-108 8" WATER MAIN PLAN AND PROFILE STA. 40+00 - 47+71.77  LS-109 SANITARY SEWER LINE A, PLAN AND PROFILE  LS-501 16" WATER MAIN CONNECTION DETAILS  LS-502 20" WATER MAIN CONNECTION DETAILS  LS-503 STANDARD WATER LINE DETAILS	CHEET NO	TITLE
G-002 GENERAL NOTES, LAYOUT AND SUMMARY OF QUANTITIES G-003 CONTROL DATA SHEET LS-101 16" WATER MAIN PLAN AND PROFILE STA. 10+00 - 20+00 LS-102 16" WATER MAIN PLAN AND PROFILE STA. 20+00 - 31+00 LS-103 20" WATER MAIN PLAN AND PROFILE STA. 10+00 - 21+00 LS-104 20" WATER MAIN PLAN AND PROFILE STA. 21+00 - 30+00 LS-105 12" WATER MAIN PLAN AND PROFILE STA. 10+00 - 20+00 LS-106 8" AND 12" WATER MAIN PLAN AND PROFILE STA. 20+00 - 30+00 LS-107 8" WATER MAIN PLAN AND PROFILE STA. 30+00 - 40+00 LS-108 8" WATER MAIN PLAN AND PROFILE STA. 40+00 - 47+71.77 LS-109 SANITARY SEWER LINE A, PLAN AND PROFILE LS-501 16" WATER MAIN CONNECTION DETAILS LS-502 20" WATER MAIN CONNECTION DETAILS LS-503 STANDARD WATER LINE DETAILS	SHEET NO.	IIILE
G-003  CONTROL DATA SHEET  LS-101  16" WATER MAIN PLAN AND PROFILE STA. 10+00 - 20+00  LS-102  16" WATER MAIN PLAN AND PROFILE STA. 20+00 - 31+00  LS-103  20" WATER MAIN PLAN AND PROFILE STA. 10+00 - 21+00  LS-104  20" WATER MAIN PLAN AND PROFILE STA. 21+00 - 30+00  LS-105  12" WATER MAIN PLAN AND PROFILE STA. 10+00 - 20+00  LS-106  8" AND 12" WATER MAIN PLAN AND PROFILE STA. 20+00 - 30+00  LS-107  8" WATER MAIN PLAN AND PROFILE STA. 30+00 - 40+00  LS-108  8" WATER MAIN PLAN AND PROFILE STA. 40+00 - 47+71.77  LS-109  SANITARY SEWER LINE A, PLAN AND PROFILE  LS-501  16" WATER MAIN CONNECTION DETAILS  LS-502  STANDARD WATER LINE DETAILS	G-001	COVER SHEET
LS-101 16" WATER MAIN PLAN AND PROFILE STA. 10+00 - 20+00 LS-102 16" WATER MAIN PLAN AND PROFILE STA. 20+00 - 31+00 LS-103 20" WATER MAIN PLAN AND PROFILE STA. 10+00 - 21+00 LS-104 20" WATER MAIN PLAN AND PROFILE STA. 21+00 - 30+00 LS-105 12" WATER MAIN PLAN AND PROFILE STA. 10+00 - 20+00 LS-106 8" AND 12" WATER MAIN PLAN AND PROFILE STA. 20+00 - 30+00 LS-107 8" WATER MAIN PLAN AND PROFILE STA. 30+00 - 40+00 LS-108 8" WATER MAIN PLAN AND PROFILE STA. 40+00 - 47+71.77 LS-109 SANITARY SEWER LINE A, PLAN AND PROFILE LS-501 16" WATER MAIN CONNECTION DETAILS LS-502 20" WATER MAIN CONNECTION DETAILS LS-503 STANDARD WATER LINE DETAILS	G-002	GENERAL NOTES, LAYOUT AND SUMMARY OF QUANTITIES
LS-102 16" WATER MAIN PLAN AND PROFILE STA. 20+00 - 31+00 LS-103 20" WATER MAIN PLAN AND PROFILE STA. 10+00 - 21+00 LS-104 20" WATER MAIN PLAN AND PROFILE STA. 21+00 - 30+00 LS-105 12" WATER MAIN PLAN AND PROFILE STA. 10+00 - 20+00 LS-106 8" AND 12" WATER MAIN PLAN AND PROFILE STA. 20+00 - 30+00 LS-107 8" WATER MAIN PLAN AND PROFILE STA. 30+00 - 40+00 LS-108 8" WATER MAIN PLAN AND PROFILE STA. 40+00 - 47+71.77 LS-109 SANITARY SEWER LINE A, PLAN AND PROFILE LS-110 SANITARY SEWER LINE B, PLAN AND PROFILE LS-501 16" WATER MAIN CONNECTION DETAILS LS-502 20" WATER MAIN CONNECTION DETAILS LS-503 STANDARD WATER LINE DETAILS	G-003	CONTROL DATA SHEET
LS-103 20" WATER MAIN PLAN AND PROFILE STA. 10+00 - 21+00 LS-104 20" WATER MAIN PLAN AND PROFILE STA. 21+00 - 30+00 LS-105 12" WATER MAIN PLAN AND PROFILE STA. 10+00 - 20+00 LS-106 8" AND 12" WATER MAIN PLAN AND PROFILE STA. 20+00 - 30+00 LS-107 8" WATER MAIN PLAN AND PROFILE STA. 30+00 - 40+00 LS-108 8" WATER MAIN PLAN AND PROFILE STA. 40+00 - 47+71.77 LS-109 SANITARY SEWER LINE A, PLAN AND PROFILE LS-110 SANITARY SEWER LINE B, PLAN AND PROFILE LS-501 16" WATER MAIN CONNECTION DETAILS LS-502 20" WATER MAIN CONNECTION DETAILS LS-503 STANDARD WATER LINE DETAILS	LS-101	16" WATER MAIN PLAN AND PROFILE STA. 10+00 - 20+00
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LS-105  12" WATER MAIN PLAN AND PROFILE STA. 10+00 - 20+00  R" AND 12" WATER MAIN PLAN AND PROFILE STA. 20+00 - 30+00  R" WATER MAIN PLAN AND PROFILE STA. 30+00 - 40+00  R" WATER MAIN PLAN AND PROFILE STA. 40+00 - 47+71.77  RS-109  SANITARY SEWER LINE A, PLAN AND PROFILE  LS-110  SANITARY SEWER LINE B, PLAN AND PROFILE  LS-501  16" WATER MAIN CONNECTION DETAILS  LS-502  STANDARD WATER LINE DETAILS	LS-103	20" WATER MAIN PLAN AND PROFILE STA. 10+00 - 21+00
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LS-108 8" WATER MAIN PLAN AND PROFILE STA. 40+00 - 47+71.77 LS-109 SANITARY SEWER LINE A, PLAN AND PROFILE LS-110 SANITARY SEWER LINE B, PLAN AND PROFILE LS-501 16" WATER MAIN CONNECTION DETAILS LS-502 20" WATER MAIN CONNECTION DETAILS LS-503 STANDARD WATER LINE DETAILS	LS-106	8" AND 12" WATER MAIN PLAN AND PROFILE STA. 20+00 - 30+00
LS-109 SANITARY SEWER LINE A, PLAN AND PROFILE LS-110 SANITARY SEWER LINE B, PLAN AND PROFILE LS-501 16" WATER MAIN CONNECTION DETAILS LS-502 20" WATER MAIN CONNECTION DETAILS LS-503 STANDARD WATER LINE DETAILS	LS-107	8" WATER MAIN PLAN AND PROFILE STA. 30+00 - 40+00
LS-110 SANITARY SEWER LINE B, PLAN AND PROFILE LS-501 16" WATER MAIN CONNECTION DETAILS LS-502 20" WATER MAIN CONNECTION DETAILS LS-503 STANDARD WATER LINE DETAILS	LS-108	8" WATER MAIN PLAN AND PROFILE STA. 40+00 - 47+71.77
LS-501 16" WATER MAIN CONNECTION DETAILS LS-502 20" WATER MAIN CONNECTION DETAILS LS-503 STANDARD WATER LINE DETAILS	LS-109	SANITARY SEWER LINE A, PLAN AND PROFILE
LS-502 20" WATER MAIN CONNECTION DETAILS LS-503 STANDARD WATER LINE DETAILS	LS-110	SANITARY SEWER LINE B, PLAN AND PROFILE
LS-503 STANDARD WATER LINE DETAILS	LS-501	16" WATER MAIN CONNECTION DETAILS
	LS-502	20" WATER MAIN CONNECTION DETAILS
LS-504 STANDARD WATER LINE DETAILS	LS-503	STANDARD WATER LINE DETAILS
	LS-504	STANDARD WATER LINE DETAILS

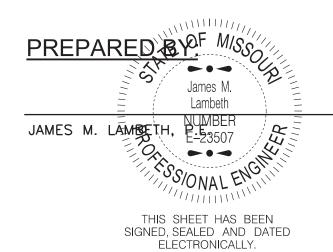

DATE

- 1. ALL WORK SHALL BE DONE IN ACCORDANCE WITH THE MOST CURRENT VERSION OF THE "CITY OF LEE'S SUMMIT STANDARD SPECIFICATIONS, SECTION 3900-WATER MAINS".
- 2. CONTRACTOR SHALL POTHOLE AND EXPOSE ALL TIE-IN AND CROSSING LOCATIONS. THE CONTRACTOR SHALL FURNISH AND INSTALL ALL FITTINGS REQUIRED TO PROVIDE PROPER HORIZONTAL AND VERTICAL ALIGNMENT FOR NEW WATER MAINS, CONNECTIONS TO EXISTING WATER MAINS AND INSTALLATION OF FIRE HYDRANTS AT THE PROPER LOCATION AND ELEVATION, WHETHER OR NOT THE PROPER FITTINGS, LOCATION OR ELEVATIONS ARE CALLED OUT ON THE DRAWINGS, INCLUDING MODIFICATION OF EXISTING INFRASTRUCTURE REQUIRED TO MAKE ALL OF THE WORK SHALL BE DONE IN ACCORDANCE WITH THE MOST CURRENT VERSION OF THE "CITY OF LEE'S SUMMIT STANDARD SPECIFICATIONS, SECTION 3900-WATER MAINS".
- 3. THE CONTRACTOR SHALL FURNISH AND INSTALL ALL TEMPORARY BLOW-OFF ASSEMBLIES, FITTINGS, THRUST BLOCKING, AND RESTRAINING DEVICES REQUIRED FOR TEMPORARY CONNECTIONS FOR FLUSHING, PRESSURE TESTING, CHLORINATION, AND DE-CHLORINATION OF THE NEW WATER MAINS. PRIOR TO PLACING NEW MAINS IN SERVICE THE CONTRACTOR SHALL REMOVE ANY CORPORATION COCKS USED FOR TESTING OR CHLORINATION AND REPLACE THEM WITH TAPERED BRASS PLUGS.
- 4. THE CONTRACTOR SHALL INSTALL POLYETHYLENE ENCASEMENT ON ALL WATER MAINS, VALVES, FITTINGS, AND OTHER APPURTENANCES FOR THE FULL LENGTH OF THE PROJECT IN ACCORDANCE WITH THE MOST CURRENT VERSION OF THE "CITY OF LEE'S SUMMIT STANDARD SPECIFICATIONS, SECTION 3900-WATER MAINS".
- 5. SCHEDULING OF WATER MAIN SHUTS AND CONNECTION TO EXISTING MAINS SHALL BE AT THE DISCRETION OF THE WATER UTILITIES
- 6. ALL FIRE HYDRANT BRANCHES SHALL BE RESTRAINED USING APPROVED RESTRAINING DEVICES. HYDRANTS SHALL BE INSTALLED SO THAT THE CENTERLINE OF THE OUTLET NOZZLE IS BETWEEN TWENTY—ONE AND THIRTY INCHES (21" 30") ABOVE FINISHED GRADE, AND SO THAT THERE IS A MINIMUM CLEAR AREA OF 5' IN EACH DIRECTION TO ALLOW OPERATION OF THE HYDRANT.
- 7. SECTIONS OF WATER MAIN REQUIRING MULTIPLE BENDS, SUCH AS CUL-DE-SACS, SHALL BE RESTRAINED WITH APPROVED JOINT RESTRAINING DEVICES AND STRADDLE BLOCKS IN LIEU OF BACKING BLOCKS.
- 8. THE LOCATIONS OF EXISTING UTILITIES, AS SHOWN, ARE APPROXIMATE. IT SHALL BE THE RESPONSIBILITY OF THE CONTRACTOR TO VERIFY THE LOCATIONS AND ELEVATIONS OF ALL EXISTING UTILITIES. CONTRACTORS SHALL POTHOLE AND EXPOSE ALL UTILITIES (INDICATED ON THE DRAWINGS, LOCATED AT GRADE BY A UTILITY LOCATING SERVICE, OR EVIDENT FROM UTILITY COMPANY INFORMATION) AT LEAST 500 FEET IN ADVANCE OF WATER MAIN CONSTRUCTION, DETERMINING THE DEPTH, SIZE, AND MATERIAL OF THE UTILITIES IN PROXIMITY TO THE PROPOSED WATER MAIN ALIGNMENT. DEFLECT PIPE TO MAINTAIN MINIMUM 5 FEET HORIZONTAL AND 18 INCH VERTICAL CLEARANCES BETWEEN PROPOSED WATER MAIN AND ALL EXISTING UTILITIES.
- 9. THE CONTRACTOR SHALL COMPLY WITH STATE LAW REQUIRING ANY PERSON OR FIRM DOING EXCAVATION ON THE PUBLIC
- RIGHT-OF-WAY DO SO ONLY AFTER GIVING NOTICE TO AND OBTAINING INFORMATION FROM UTILITY COMPANIES.

  10. STREETS AND PARKING AREAS ARE TO BE TO GRADE AND CURBS IN PLACE PRIOR TO CONSTRUCTION OF WATER MAINS. WATER MAINS SHALL BE INSTALLED WITH A MINIMUM GROUND COVER OF 42 INCHES BELOW FINISHED GRADE.
- 11. WATER MAINS SHALL BE AT LEAST 10 FEET HORIZONTALLY FROM ANY SEWER.

WHENEVER A WATER MAIN MUST CROSS ABOVE A SEWER, A VERTICAL SEPARATION OF 18 INCHES BETWEEN THE BOTTOM OF THE WATER MAIN AND THE TOP OF THE SEWER SHALL BE MAINTAINED. WHENEVER A WATER MAIN MUST CROSS UNDER A SEWER, A VERTICAL SEPARATION OF 18 INCHES BETWEEN THE BOTTOM OF THE SEWER AND THE TOP OF THE WATER MAIN SHALL BE MAINTAINED. A FULL LENGTH OF WATER MAIN PIPE SHALL BE CENTERED ON THE SEWER TO BE CROSSED SO THAT THE JOINTS WILL BE EQUALLY DISTANT FROM THE SEWER AND AS FAR AWAY AS POSSIBLE. THE 18-INCH VERTICAL SEPARATION SHALL BE MAINTAINED FOR THAT PORTION OF THE WATER MAIN LOCATED WITHIN 10 FEET, HORIZONTALLY, OF ANY SEWER IT CROSSES.

WHEN LOCAL CONDITIONS PREVENT A VERTICAL SEPARATION OF 18 INCHES, THE SEWER MUST BE ENCASED WITHIN 10 FEET OF EITHER SIDE OF THE WATER MAIN.


WHERE THESE CONDITIONS CANNOT BE MET, THE WATER UTILITIES DEPARTMENT SHALL BE CONSULTED AS TO THE PRECAUTIONS TO BE TAKEN TO PROTECT THE PUBLIC WATER SUPPLY.

- 12. A TRAFFIC CONTROL PERMIT MAY BE REQUIRED FOR THIS WORK. CONTACT THE PUBLIC WORKS ENGINEERING DIVISION LOCATED AT CITY HALL, VIA PHONE AT 816-969-1800, OR COMPLETE ON-LINE FORM AT http://cityofls.net/Public-Works/Traffic-transit/Temporary-traffic-control-Permit.aspx.
- 13. ALL WORK SHALL CONFORM TO THE LATEST REVISION OF THE LEE'S SUMMIT, MISSOURI EROSION AND SEDIMENT CONTROL SPECIFICATIONS, WHICH ARE MADE A PART HEREOF BY REFERENCE. EROSION CONTROL PLANS SHALL BE SUBMITTED TO THE CITY ENGINEER, PUBLIC WORKS DEPARTMENT FOR REVIEW AND APPROVAL PRIOR TO THE START OF THIS PROJECT.
- 14. THE END OF ALL ABANDONED WATER MAINS SHALL BE PLUGGED WITH CONCRETE.

- 15. COVERS, LIDS, AND STANDPIPES ON ALL ABANDONED VALVES SHALL BE REMOVED TO AT LEAST TWO FEET (2') BELOW GRADE AND THE AREA SHALL BE PROPERLY BACKFILLED. IN PAVED AREAS REMOVAL OF VALVE LID AND FILLING OF VALVE BOX WITH CONCRETE MAY BE ALLOWED AT WATER UTILITIES DEPARTMENT DISCRETION.
- 16. EXISTING FIRE HYDRANTS AND VALVES FROM THE VALVE VAULTS THAT ARE REMOVED SHALL BE RETURNED TO THE LEE'S SUMMIT WATER UTILITIES DEPARTMENT.
- 17. WATER SERVICE LINES CONNECTED TO MAINS BEING ABANDONED SHALL BE RECONNECTED TO NEW MAINS IN ACCORDANCE WITH THE RULES AND REGULATIONS FOR WATER SERVICES LINES OF THE WATER UTILITIES DEPARTMENT, UNLESS SHOWN OTHERWISE. EXISTING WATER SERVICE LINES BEING TRANSFERRED TO NEW MAINS WILL BE UPGRADED TO MEET CURRENT REGULATIONS.
- 18. THE CONTRACTOR SHALL VERIFY THE OUTSIDE DIAMETER (O.D.) OF THE EXISTING WATER MAIN PRIOR TO SCHEDULING CONNECTION. PROVIDE SOLID SLEEVES AS REQUIRED.
- 19. CONTRACTORS SHALL PROTECT EXISTING POWER POLES AND LIGHT POLES FROM DAMAGE AND SHALL PROVIDE BRACING, SHORING, OR OTHER WORK NECESSARY FOR SUCH PROTECTION. ANY STRUCTURES REMOVED DURING CONSTRUCTION OPERATIONS SHALL BE
- 20. PRIOR TO REMOVING EXISTING TRANSMISSION MAINS 16" AND LARGER FROM SERVICE, CONTRACTOR SHALL COORDINATE WITH LEE'S SUMMIT WATER UTILITIES DEPARTMENT REGARDING THE TIMING AND DURATION OF THE INTERRUPTION OF SERVICE.

### LEGEND:

PLUG

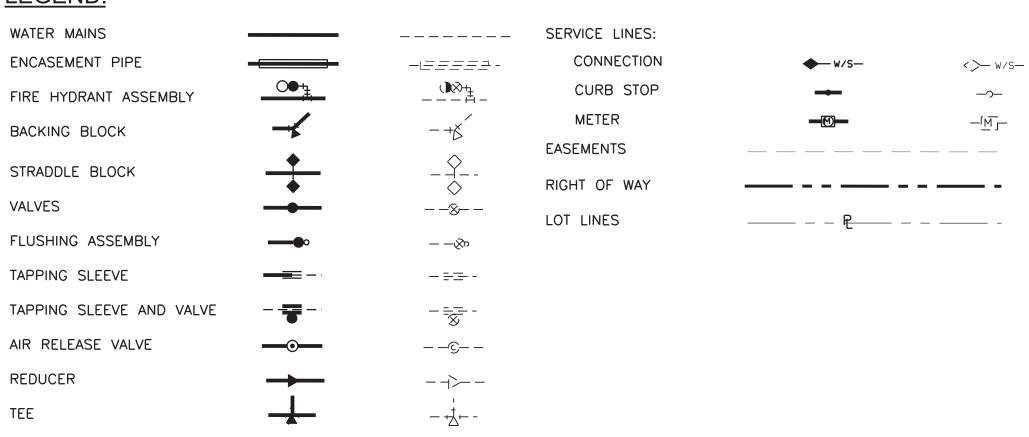

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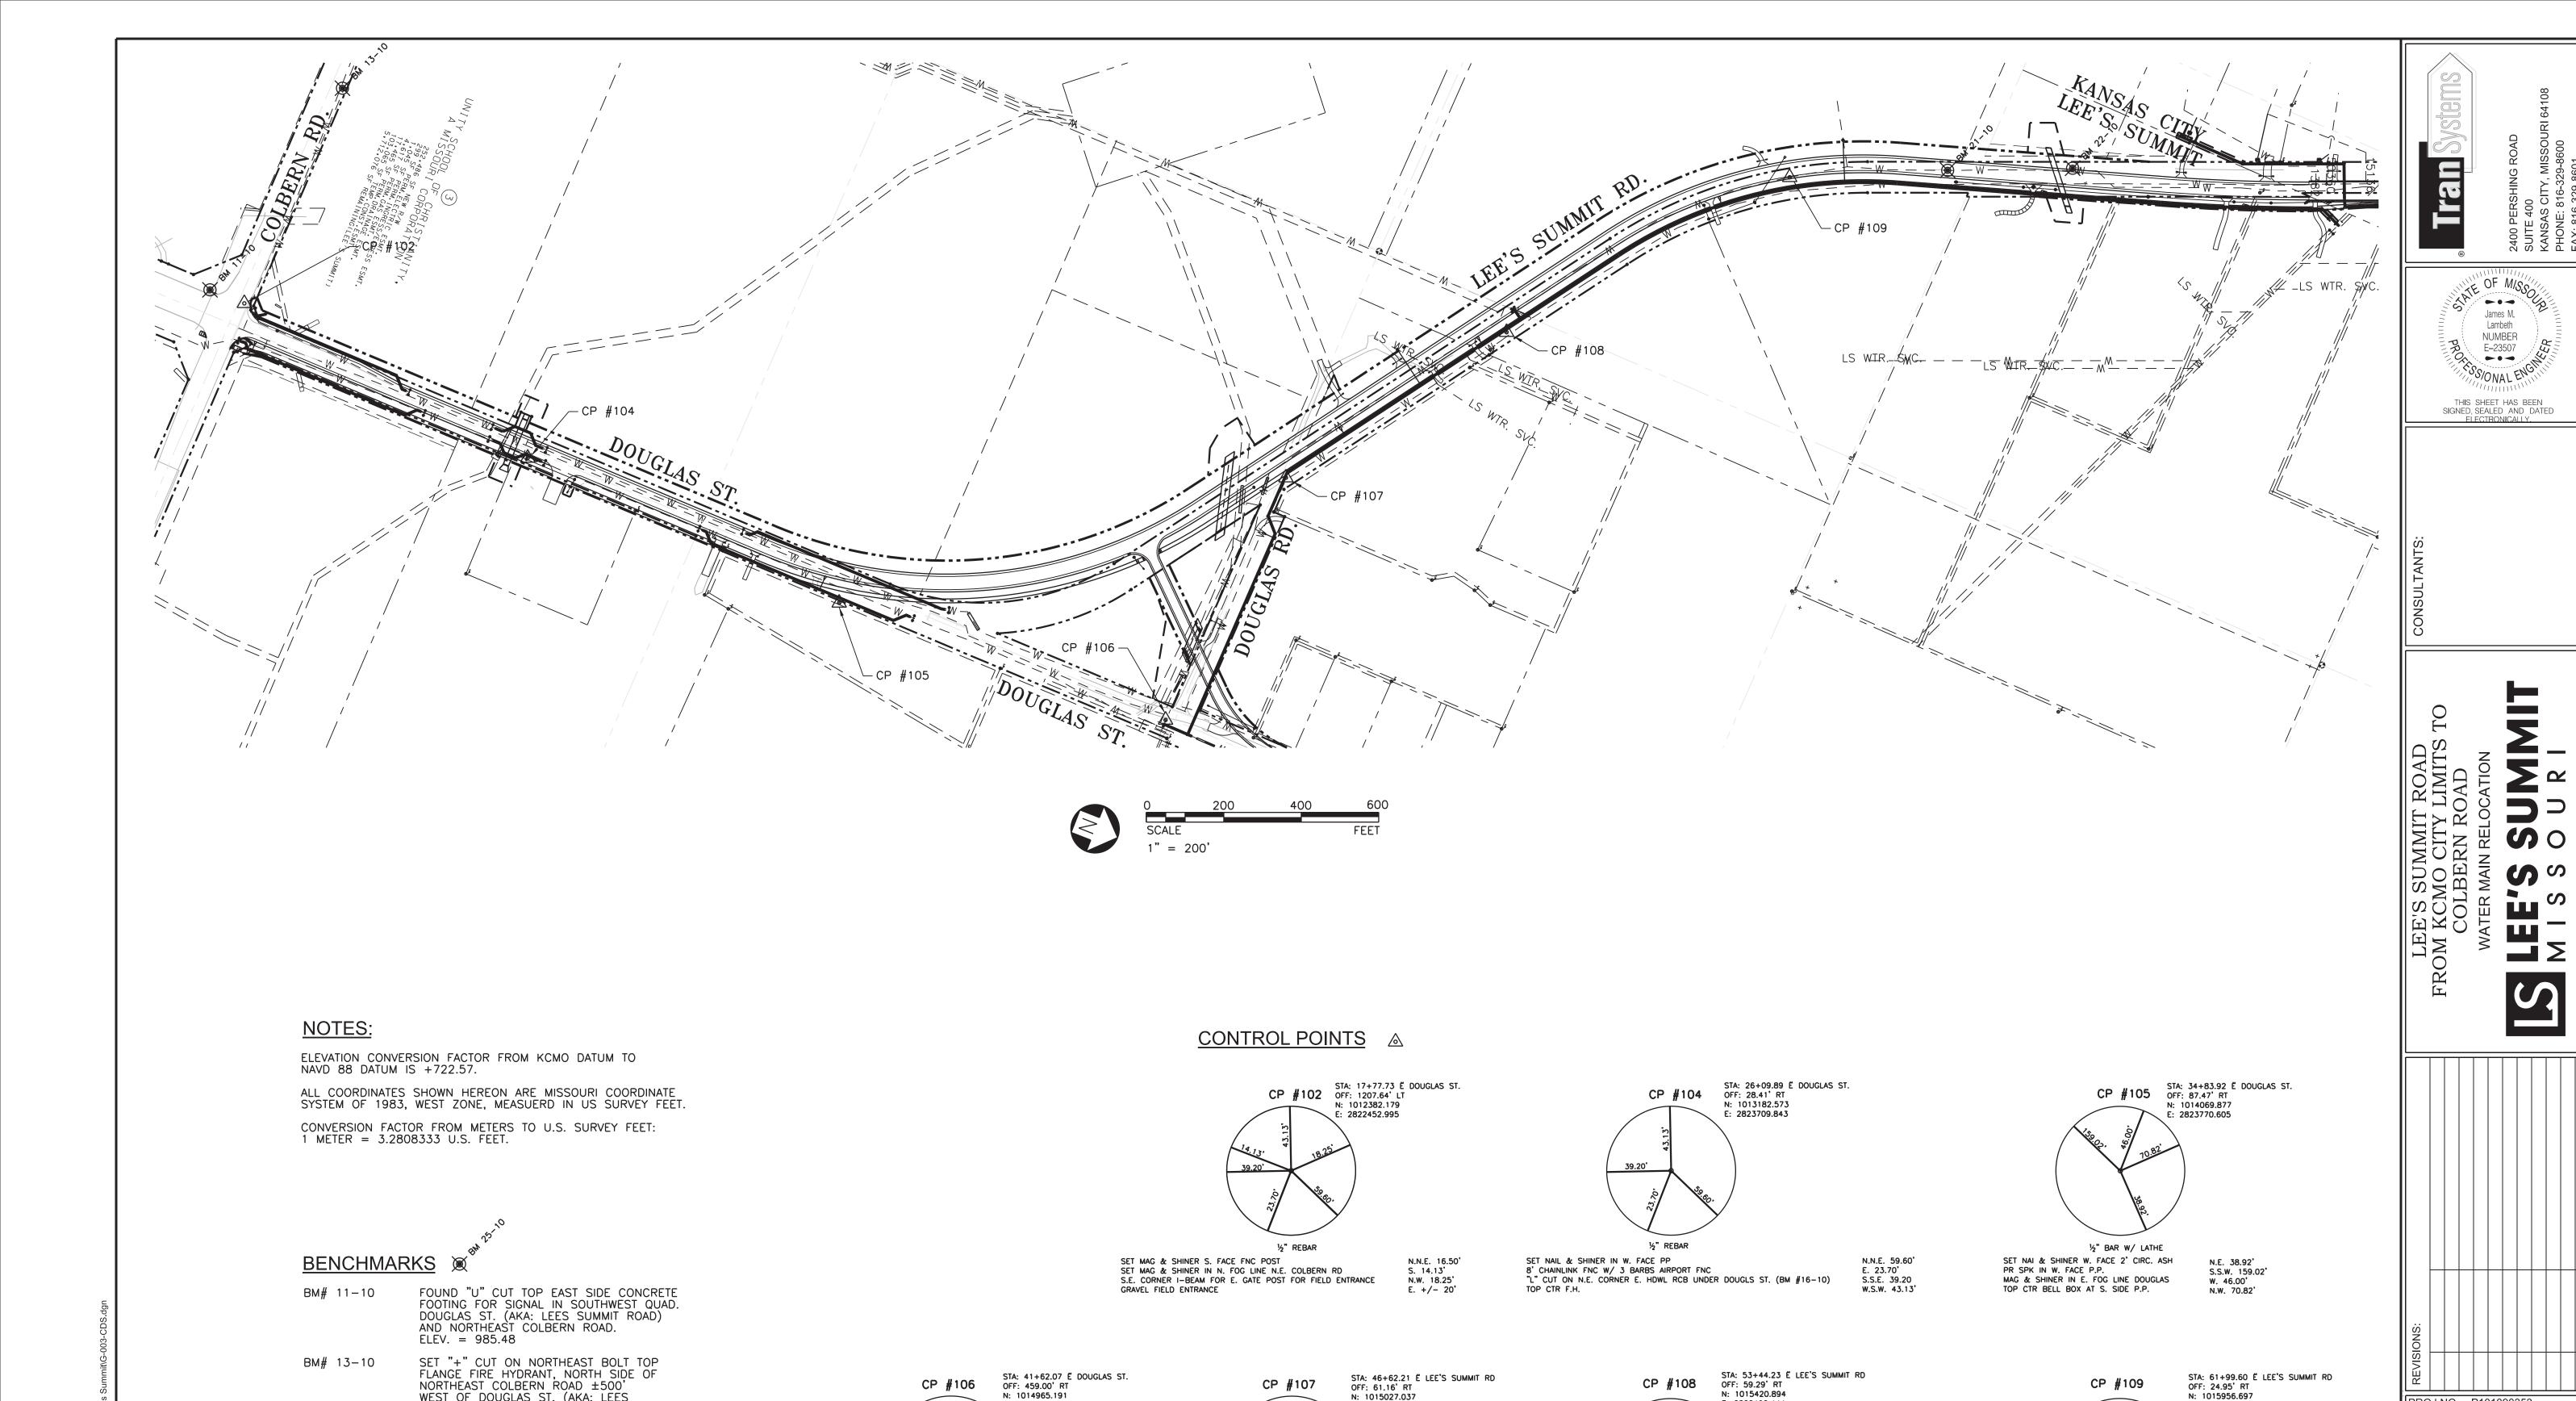
NO.	BID ITEM	UNITS	QUANTITY
	WATER LINE QUANTITIES		
1	REDUCER (8"x6")	EA.	1
2	REDUCER (12"x8")	EA.	1
3	TEE (12"x12")	EA.	3
4	SOLID SLEEVE (6")	EA.	1
5	SOLID SLEEVE (12")	EA.	1
6	SOLID SLEEVE (16")	EA.	6
7	SOLID SLEEVE (20")	EA.	6
8	BEND (8") (11.25 DEGREE)	EA.	4
9	BEND (8") (22.5 DEGREE)	EA.	4
10	BEND (8") (45 DEGREE)	EA.	1
11	BEND (8") (90 DEGREE)	EA.	1
12	BEND (12") (11.25 DEGREE)	EA.	1
13	BEND (12") (22.5 DEGREE)	EA.	2
14	BEND (12") (45 DEGREE)	EA.	2
15	BEND (16") (45 DEGREE)	EA.	12
16	BEND (20") (11.25 DEGREE)	EA.	1
17	BEND (20") (45 DEGREE)	EA.	9
18	GATE VALVE (8")	EA.	3
19	BUTTERFLY VALVE (12")	EA.	3
20	PVC WATER MAIN (8") (C-900)	EA.	2,225
21	PVC WATER MAIN (12") (C-900)	L.F.	1,594
22	DIP WATER MAIN (16") (CLASS 54)	L.F.	1,267
23	DIP WATER MAIN (20") (CLASS 54)	L.F.	1,160
24	STEEL ENCASEMENT PIPE (20")	L.F.	118
25	FIRE HYDRANT ASSEMBLY (NEW)	EA.	9
26	FIRE HYDRANT ASSEMBLY (RECONNECT)	EA.	1
27	BLOW OFF ASSEMBLY	EA.	1
	SANITARY SEWER QUANTITIES		
28	CAP AND SEAL EX. SAN. SEWER MANHOLE	EA.	1

PROJ NO: P101090353 SCALE: NO SCALE DATE: 2/17/2015 DESIGNED BY: RJ DRAWN BY: CAS CHECKED BY: DRW SHEET TITLE: **GENERAL NOTES** LAYOUT AND SUMMARY OF QUANTITIES SHEET NO. G-002 2 OF 17

Lambeth NUMBER E–23507

SIGNED, SEALED AND DATED ELECTRONICALLY.

IF THIS DRAWING IS LESS THAN 22" X 34" IT IS A REDUCED SIZE DRAWING



FND NAIL & SHINER W. FACE P.P.

POST FOR "AIRPORT - SIGN

FND NAIL & SHINER N. FACE P.P. W/ LIGHT

TOP CTR NUT OF F.H.

N: 1014965.191

E: 2823745.619

N. 41.00°

N.E. 27.82'

S.S.E. 24.40'

S.W. 16.75°

½" REBAR

FND NAIL & SHINER S. FACE P.P.

WATER VALVE IN ROAD

TOP CTR F.H.
FND NAIL & SHINER N. FACE P.P.

WEST OF DOUGLAS ST. (AKA: LEES

SET "L" CUT NORTHWEST CORNER OF

WEST HEADWALL OF RCB UNDER LEES SUMMIT ROAD ±250' SOUTH OF

FOUND "L" CUT NORTHWEST CORNER OF EAST HEADWALL OF RCB UNDER LEES

SUMMIT ROAD ±40' NORTH OF

SUMMIT ROAD).

BM# 21-10

BM# 22-10

ELEV. = 965.50

#551 DRIVE. ELEV. = 907.71

#551 DRIVE. ELEV. = 897.50

IF THIS DRAWING IS LESS THAN 22" X 34" IT IS A REDUCED SIZE DRAWING

N: 1015027.037

E: 2823049.248

N.N.W. 141.50'

S.E. 118.52'

S.W. 39.45'

E. 29.97'

N: 1015420.894

E: 2822492.444

N.W. 130.80' E. 71.00' S.W. 15.00'

SET NAIL & SHINER W. FACE P.P.

SET NAIL & SHINER N. FACE P.P.

TOP CTR BELL BOX ON N.E. SIDE OF TELE. POLE W. CASES ON E. FACE

"+" CUT ON SOUTHERLY BOLT ON TOP FLANGE OF F.H. SET NAIL & SHINER W. FACE P.P.

+/- CL OF LEE'S SUMMIT ROAD

PROJ NO: P101090353

SCALE: 1"=200'

DATE: 2/17/2015

DESIGNED BY: RJ

DRAWN BY: CAS CHECKED BY: DRW

SHEET TITLE:

SHEET NO.

CONTROL DATA

SHEET

G-003


SHEET 3 OF 17


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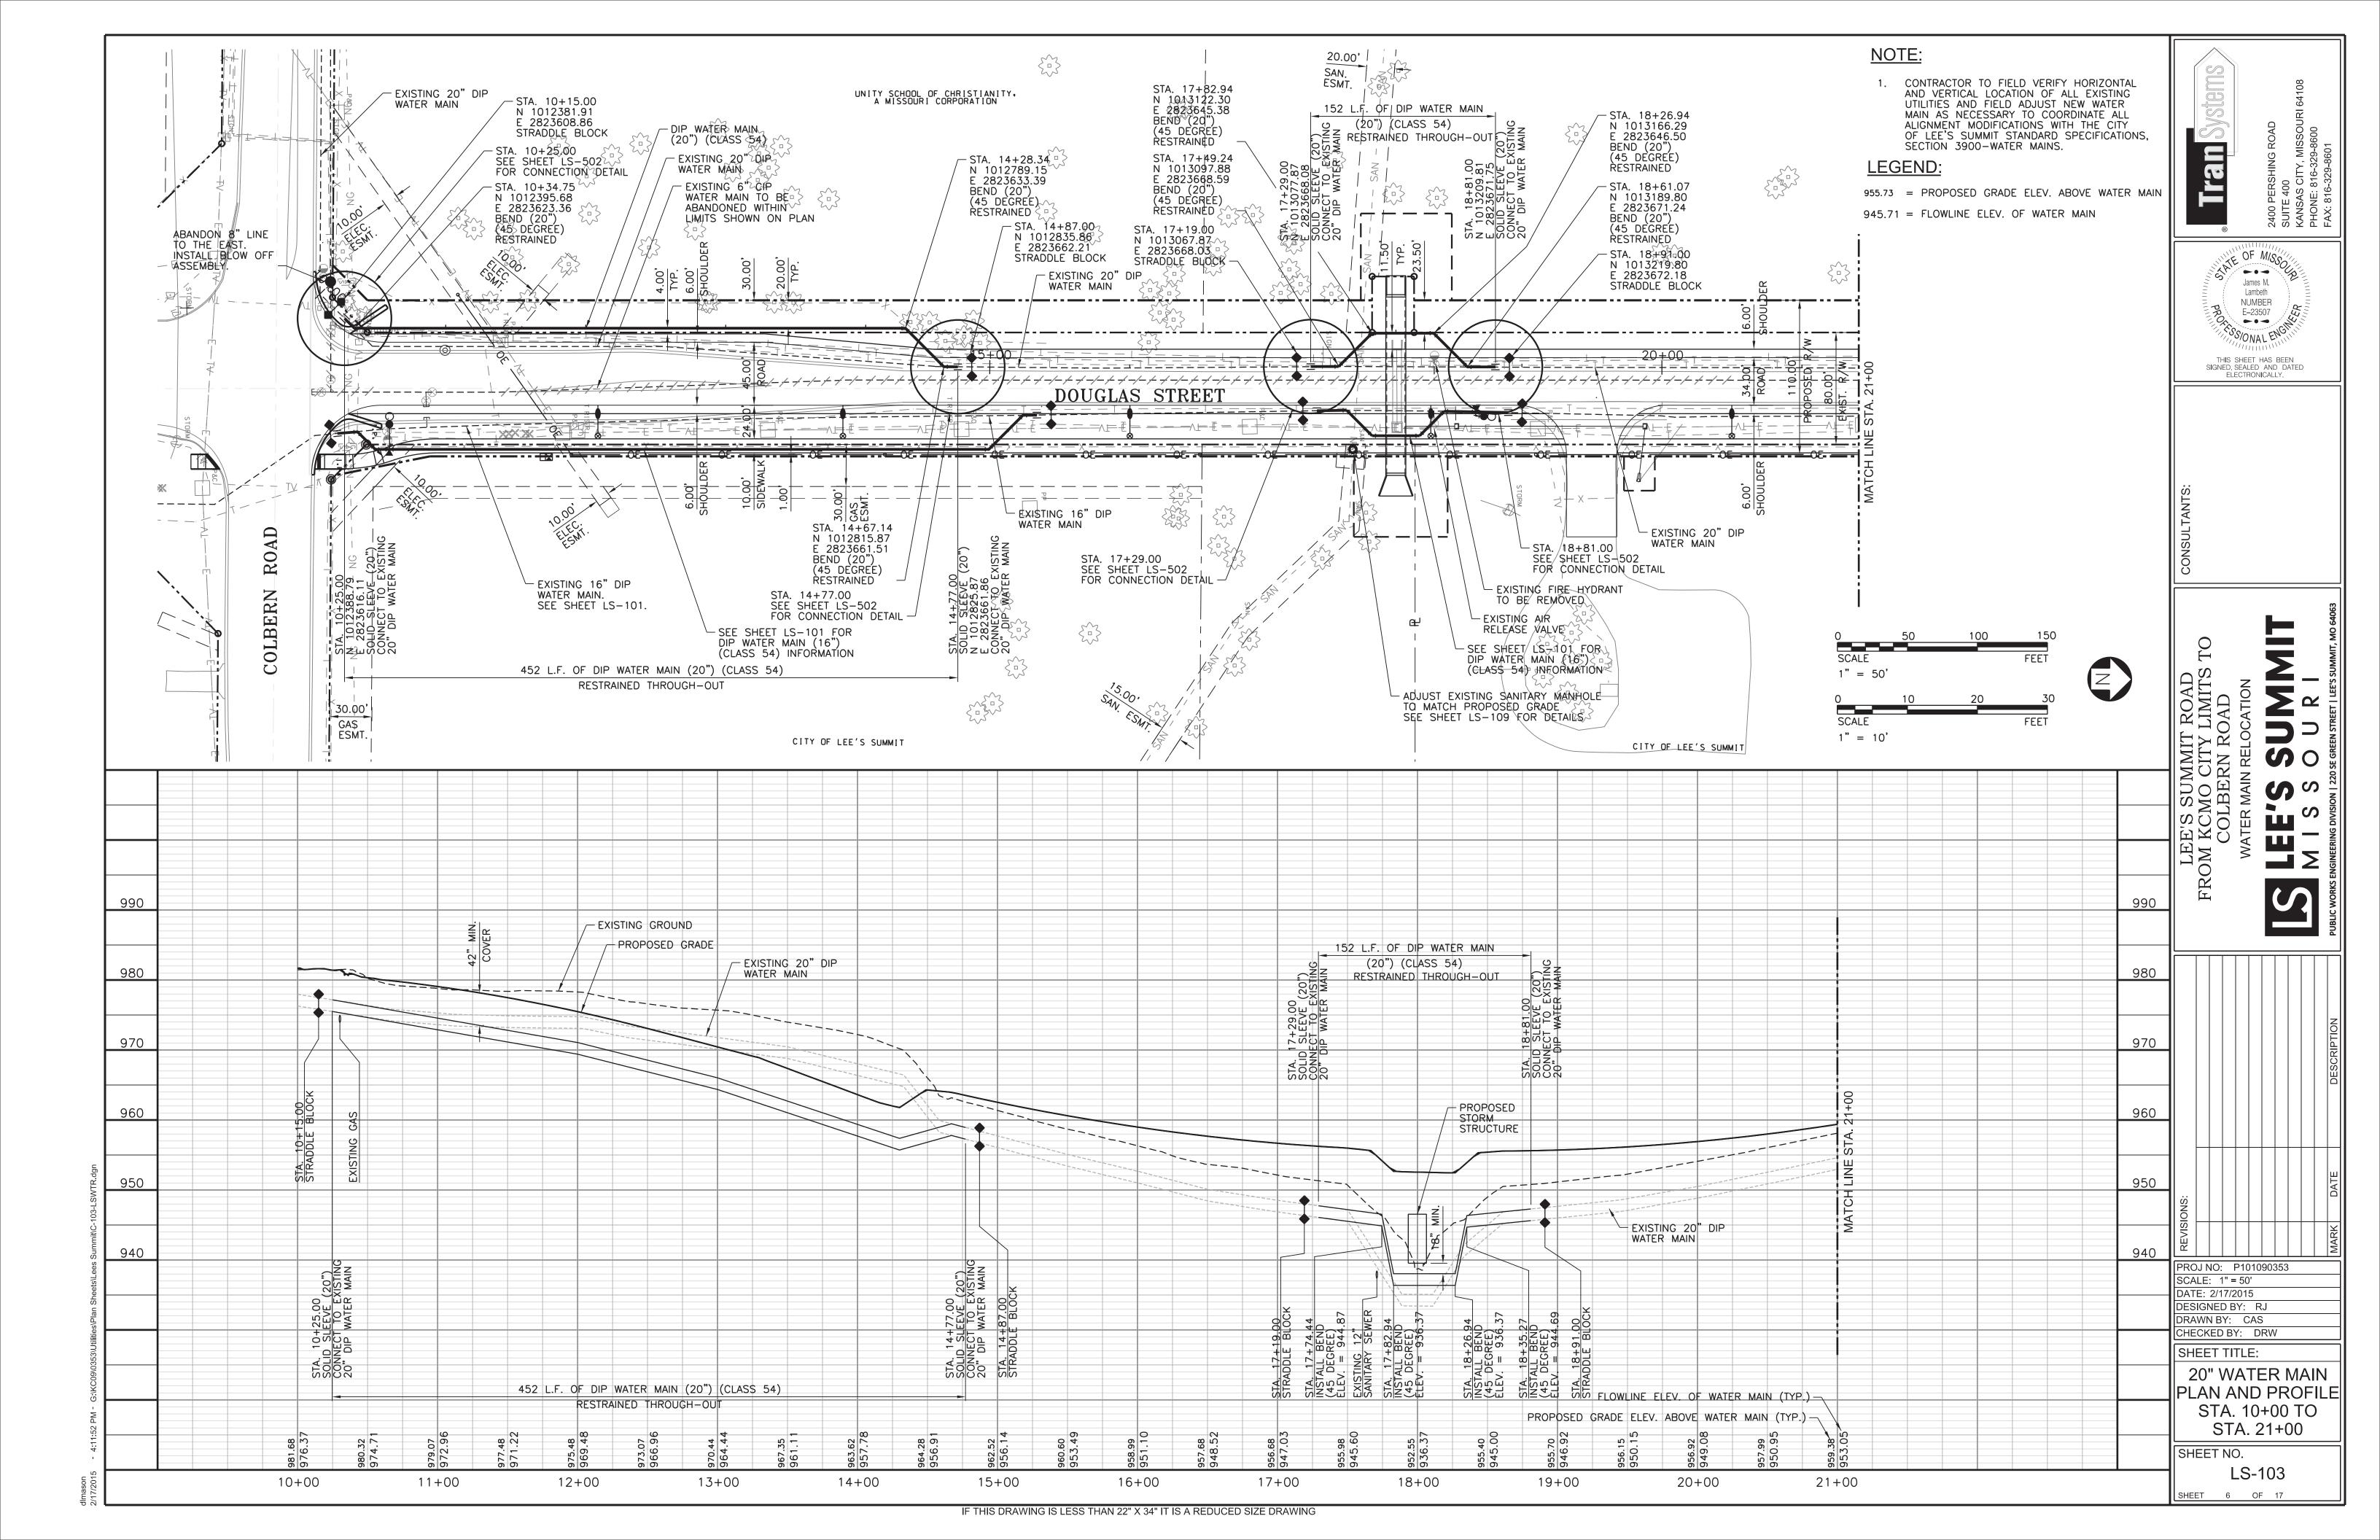
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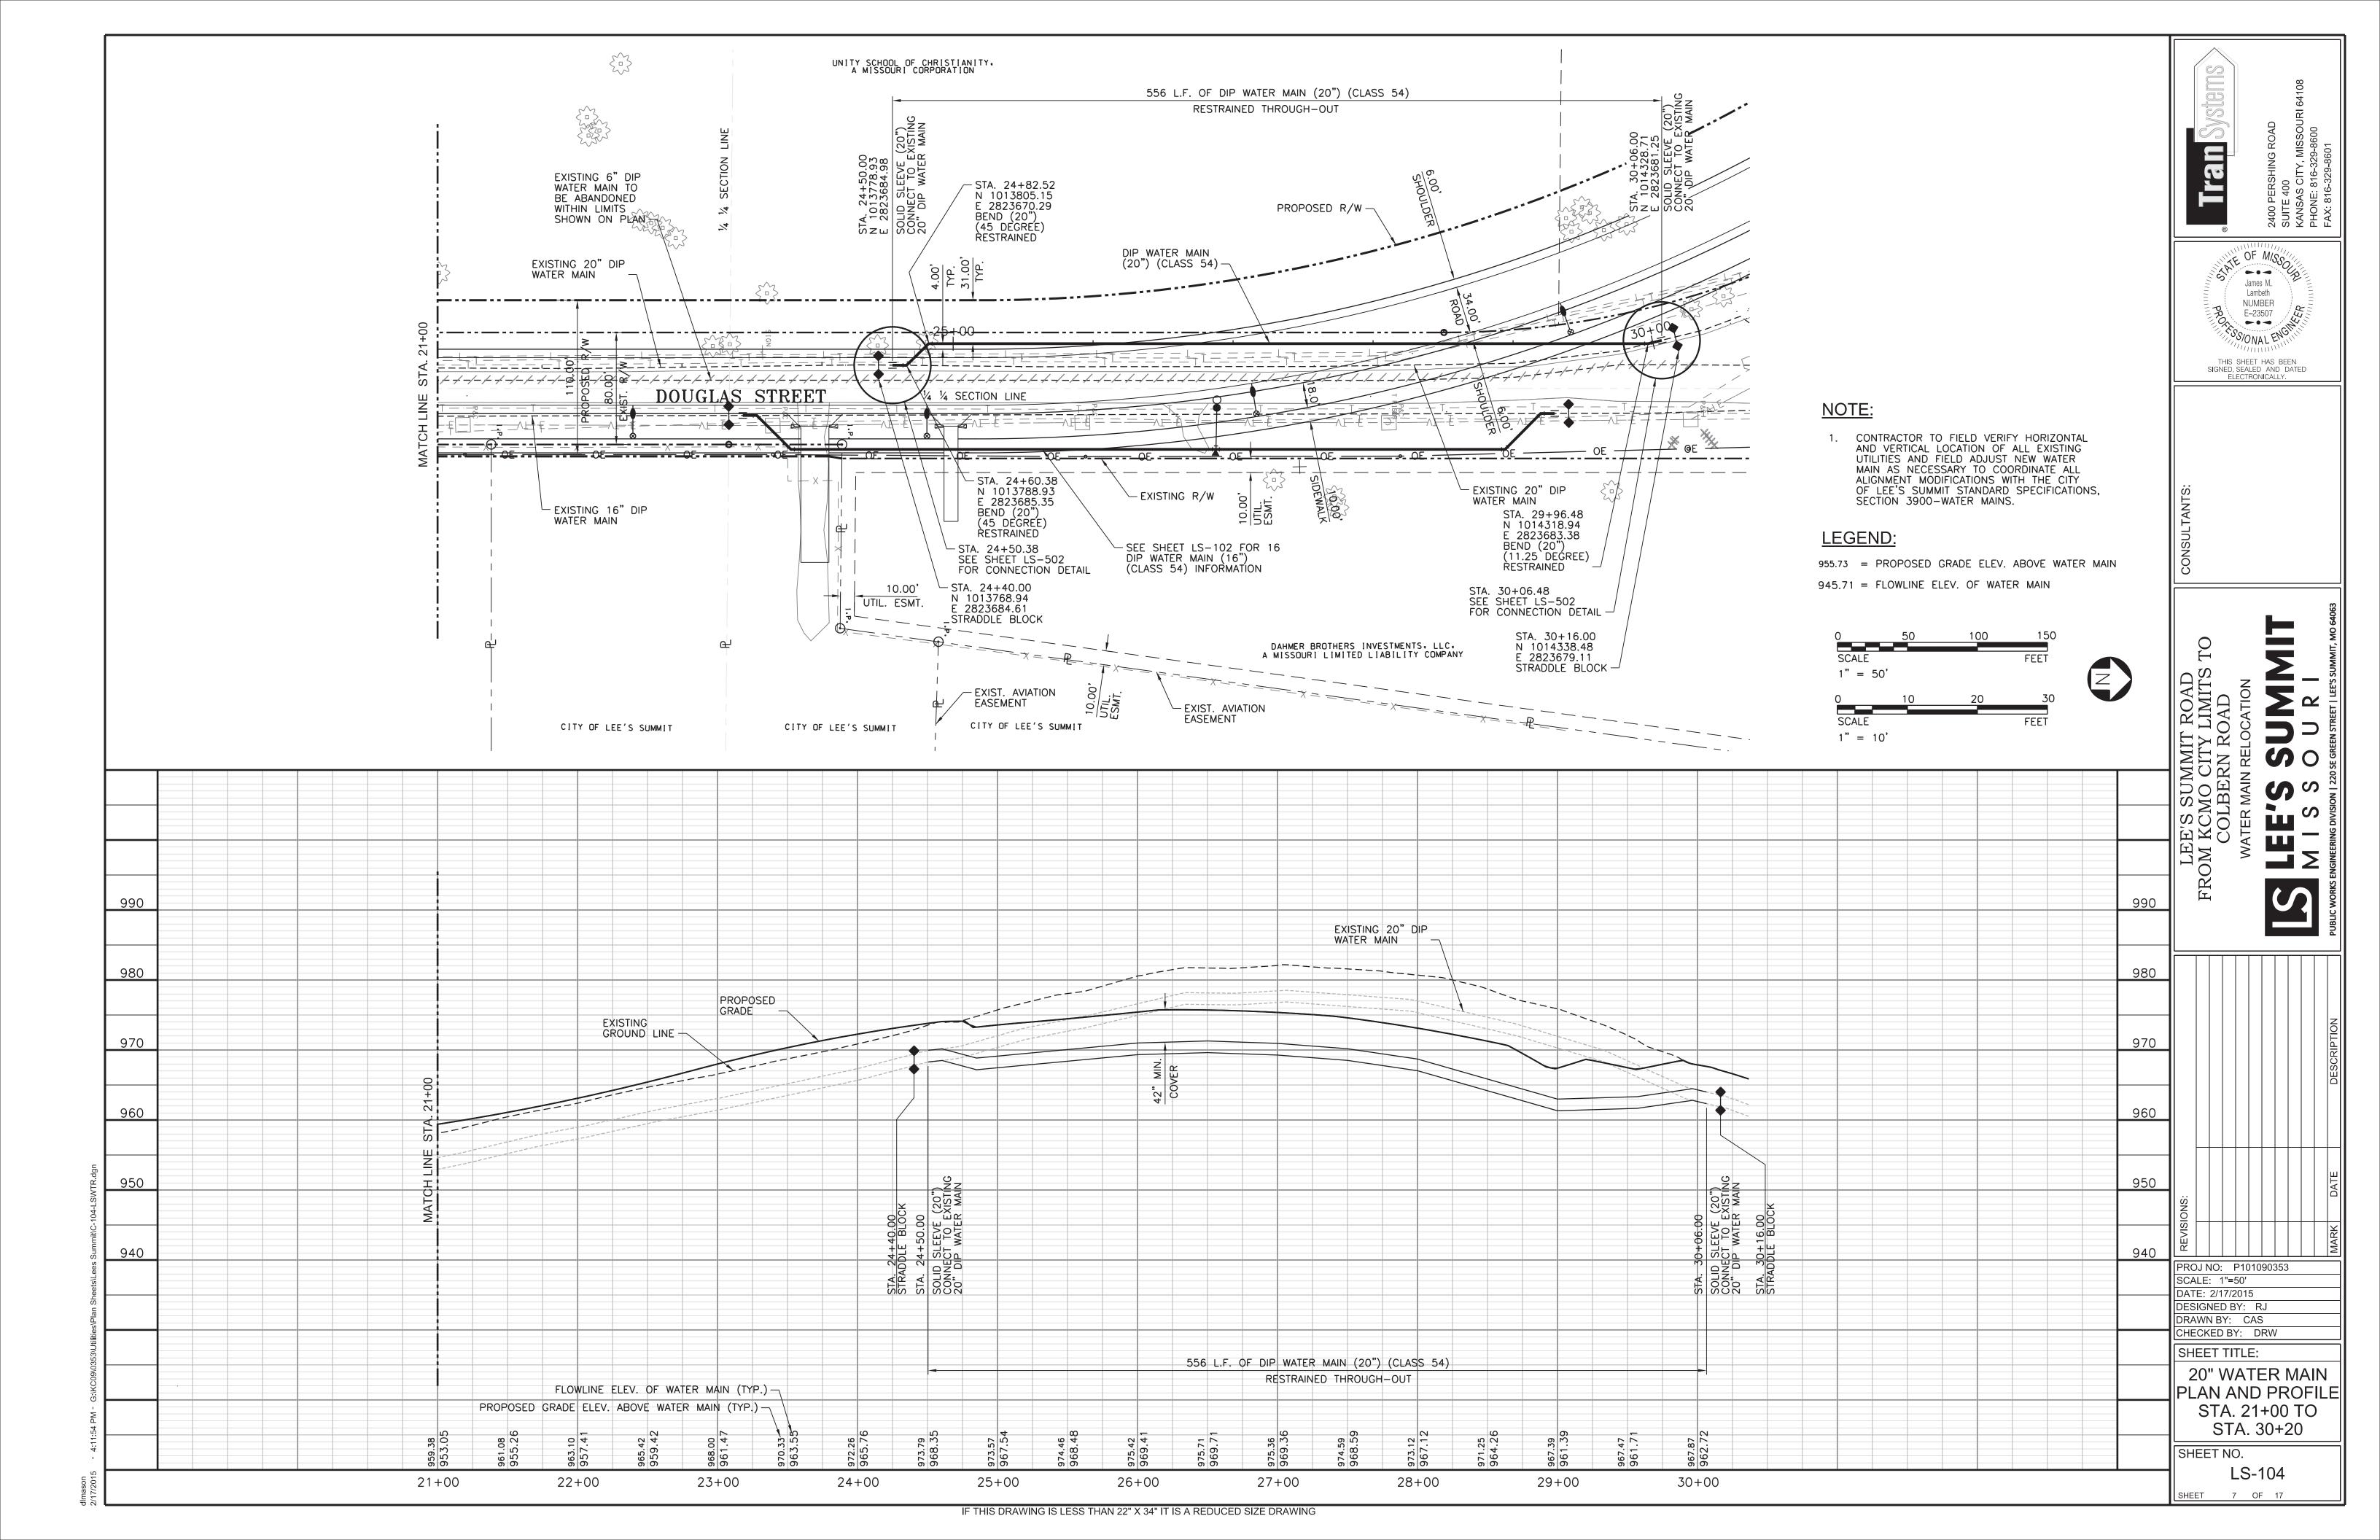
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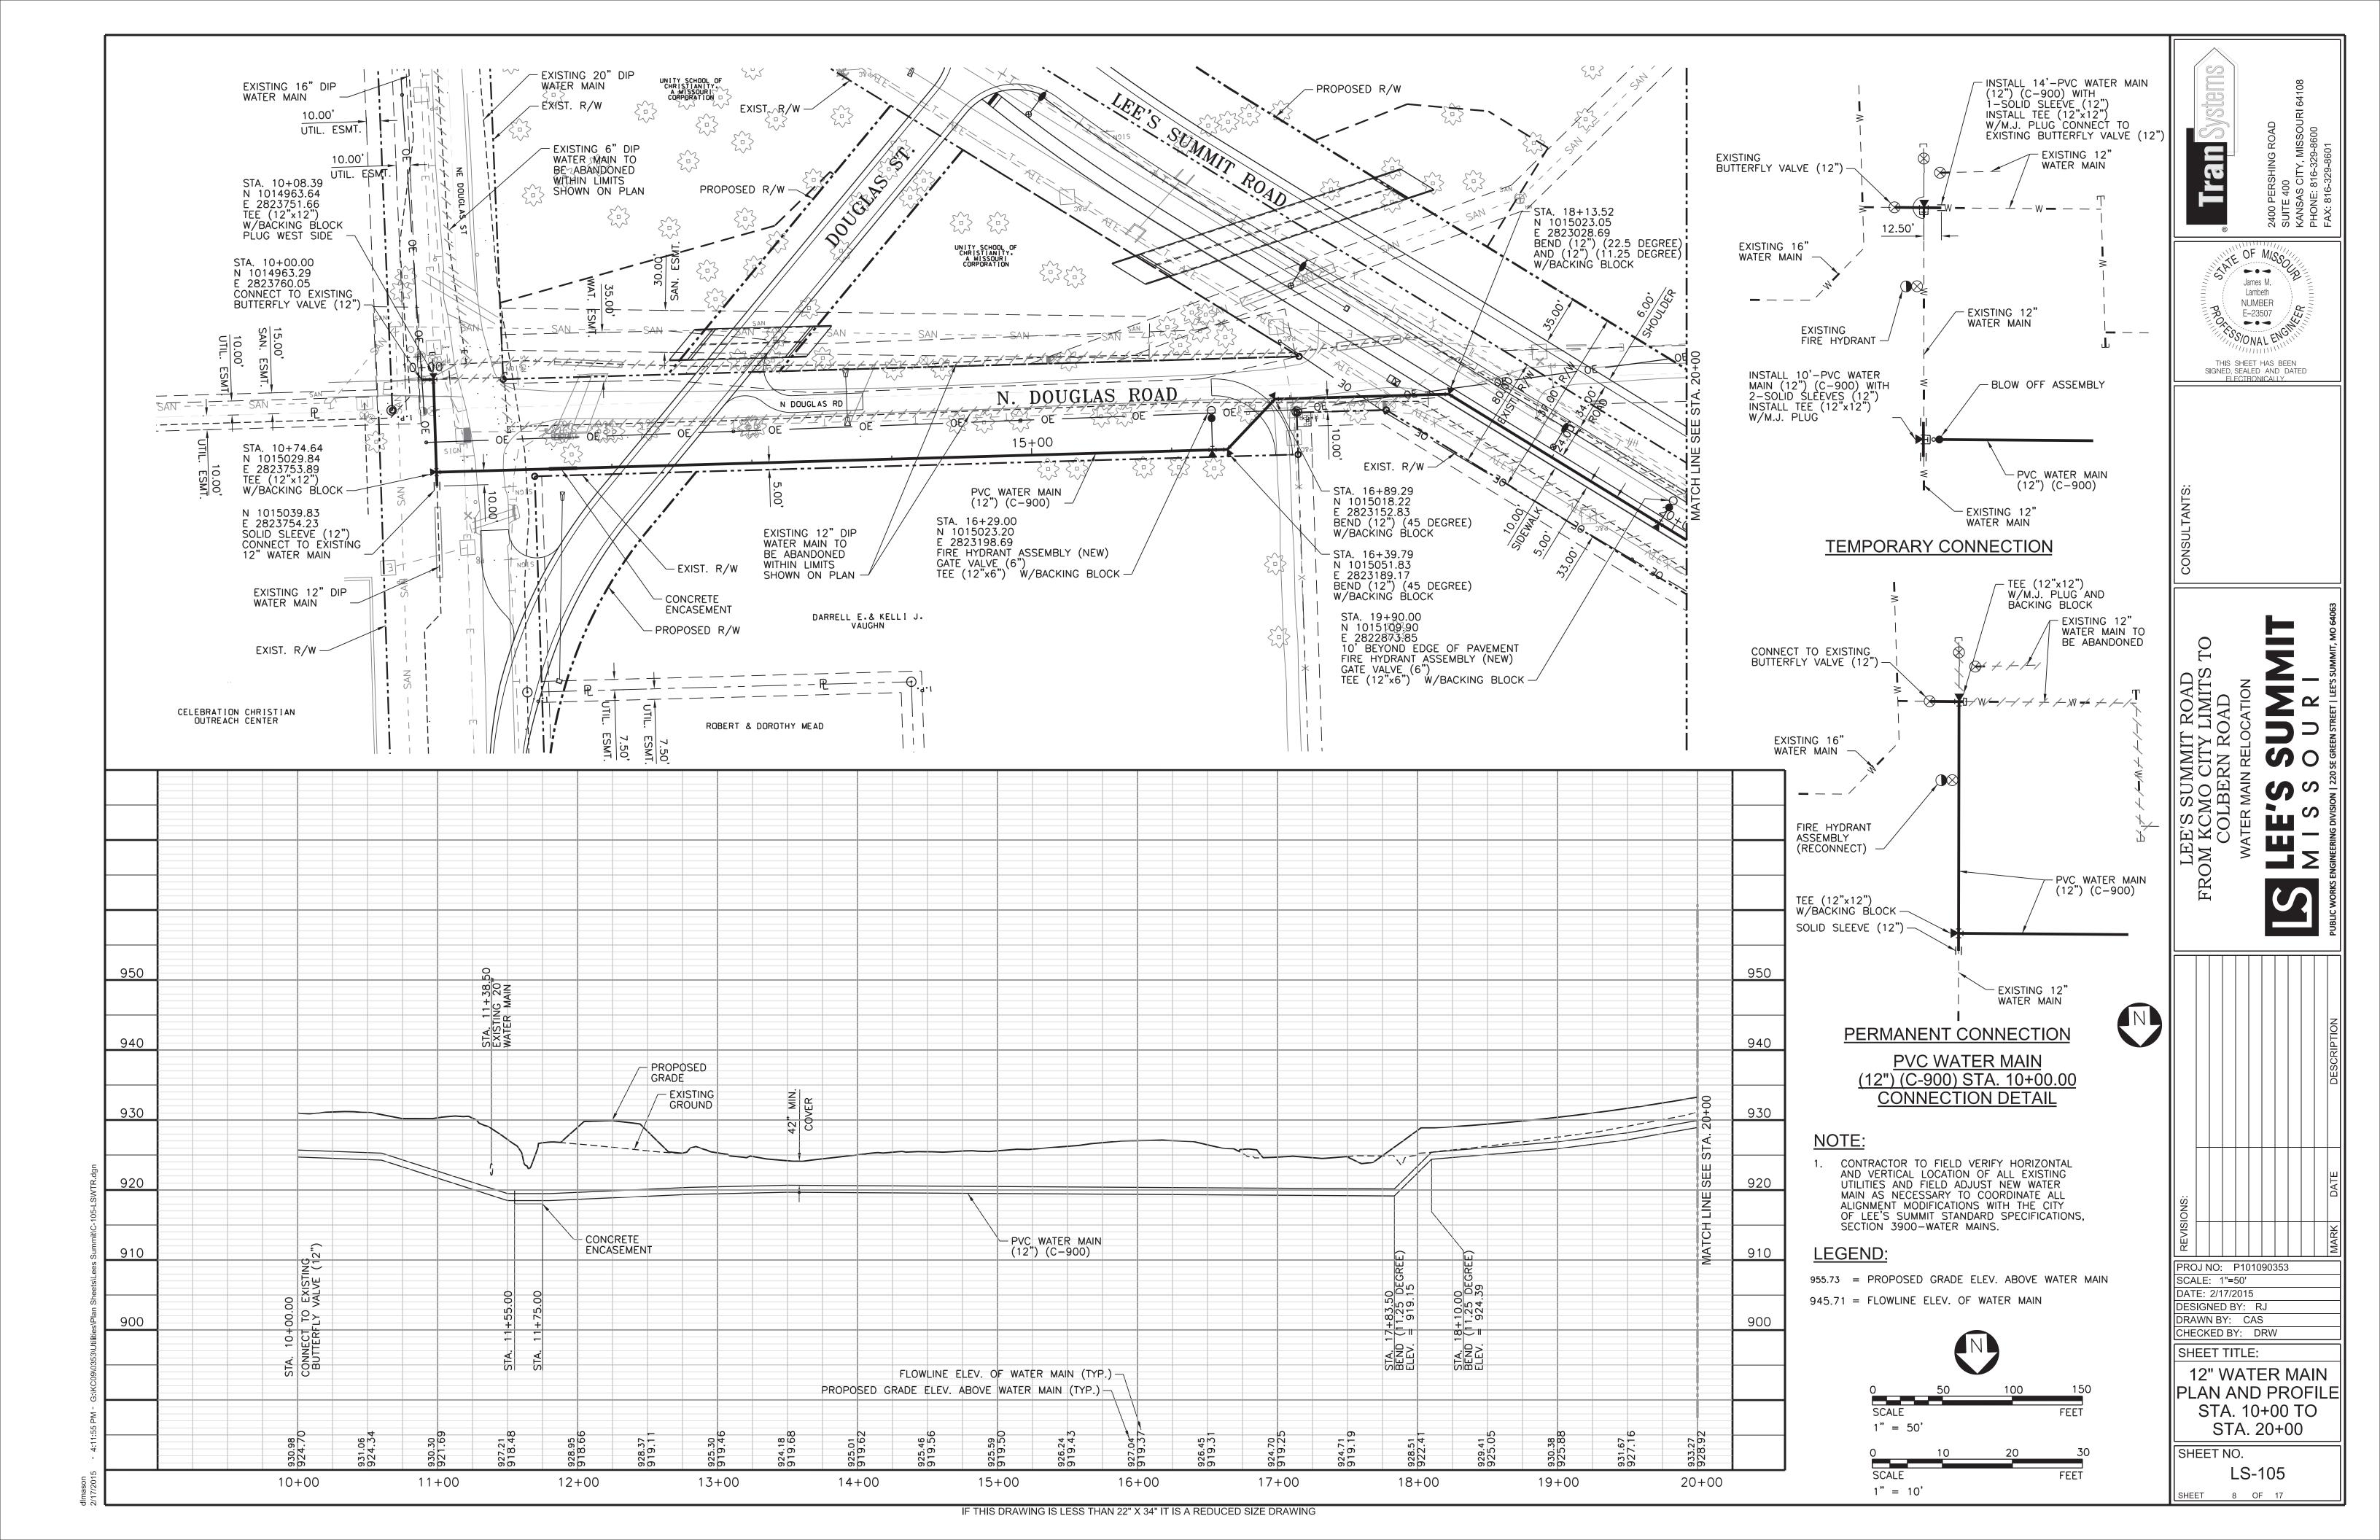
N.N.W. 40.45'










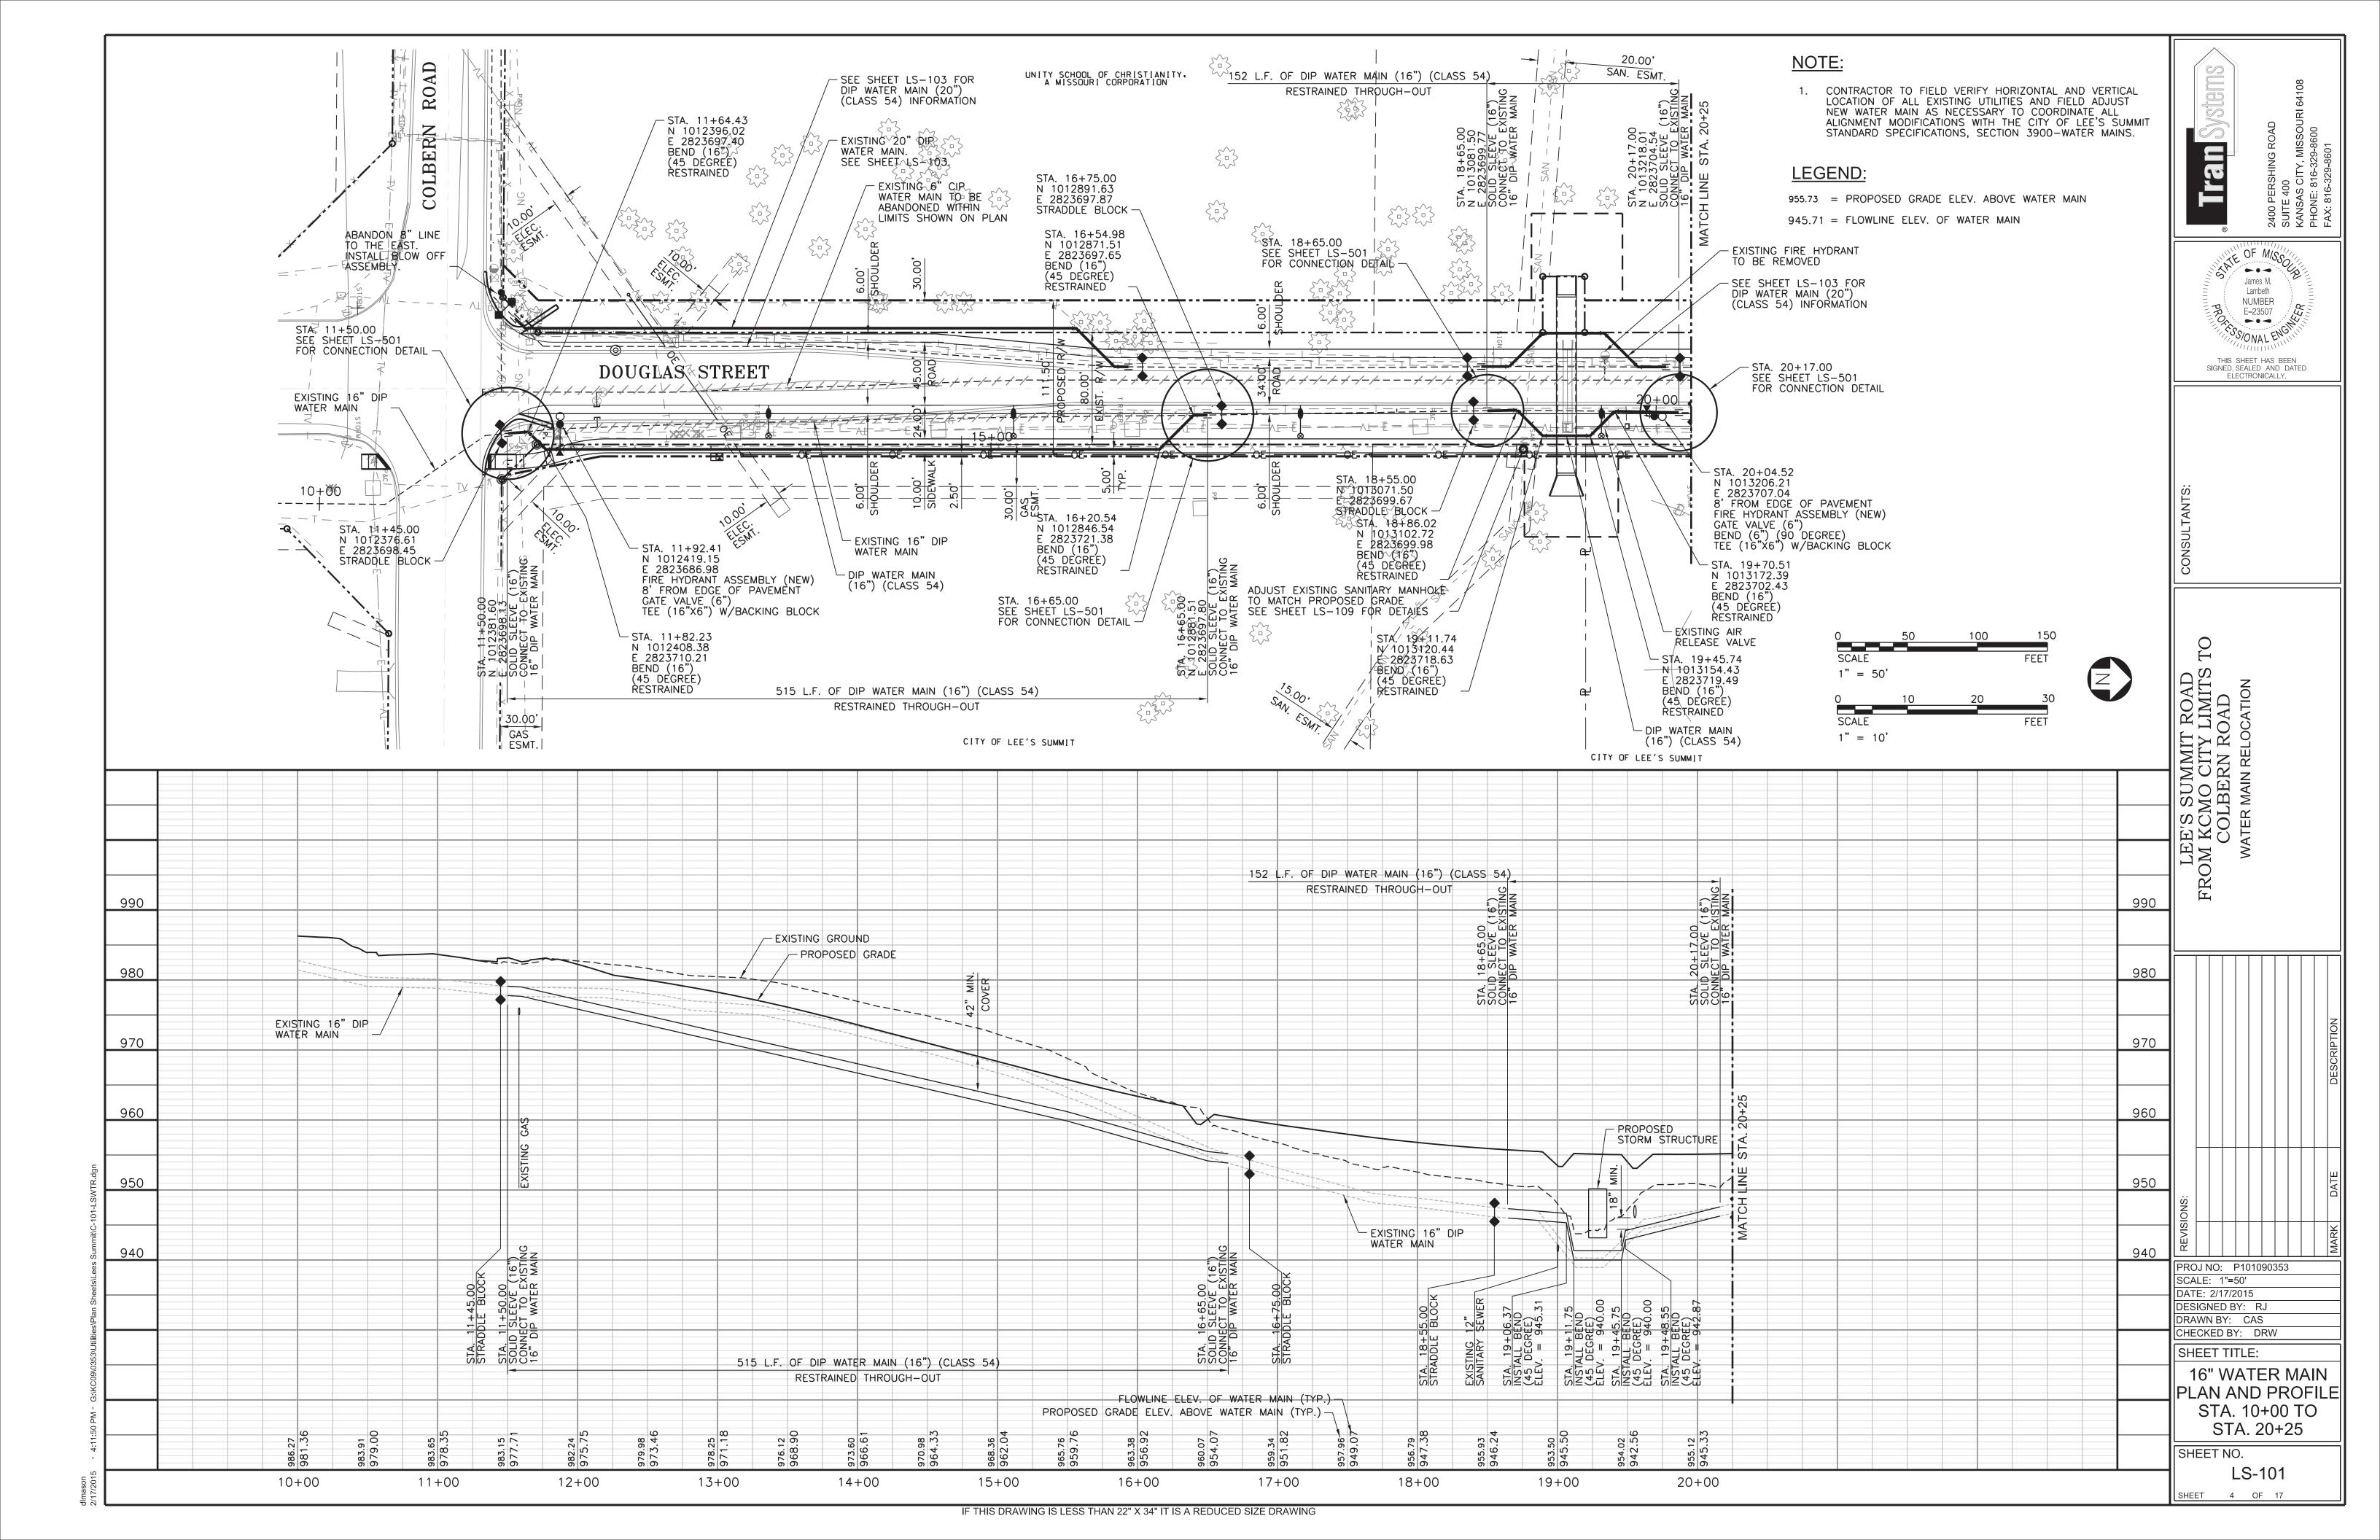


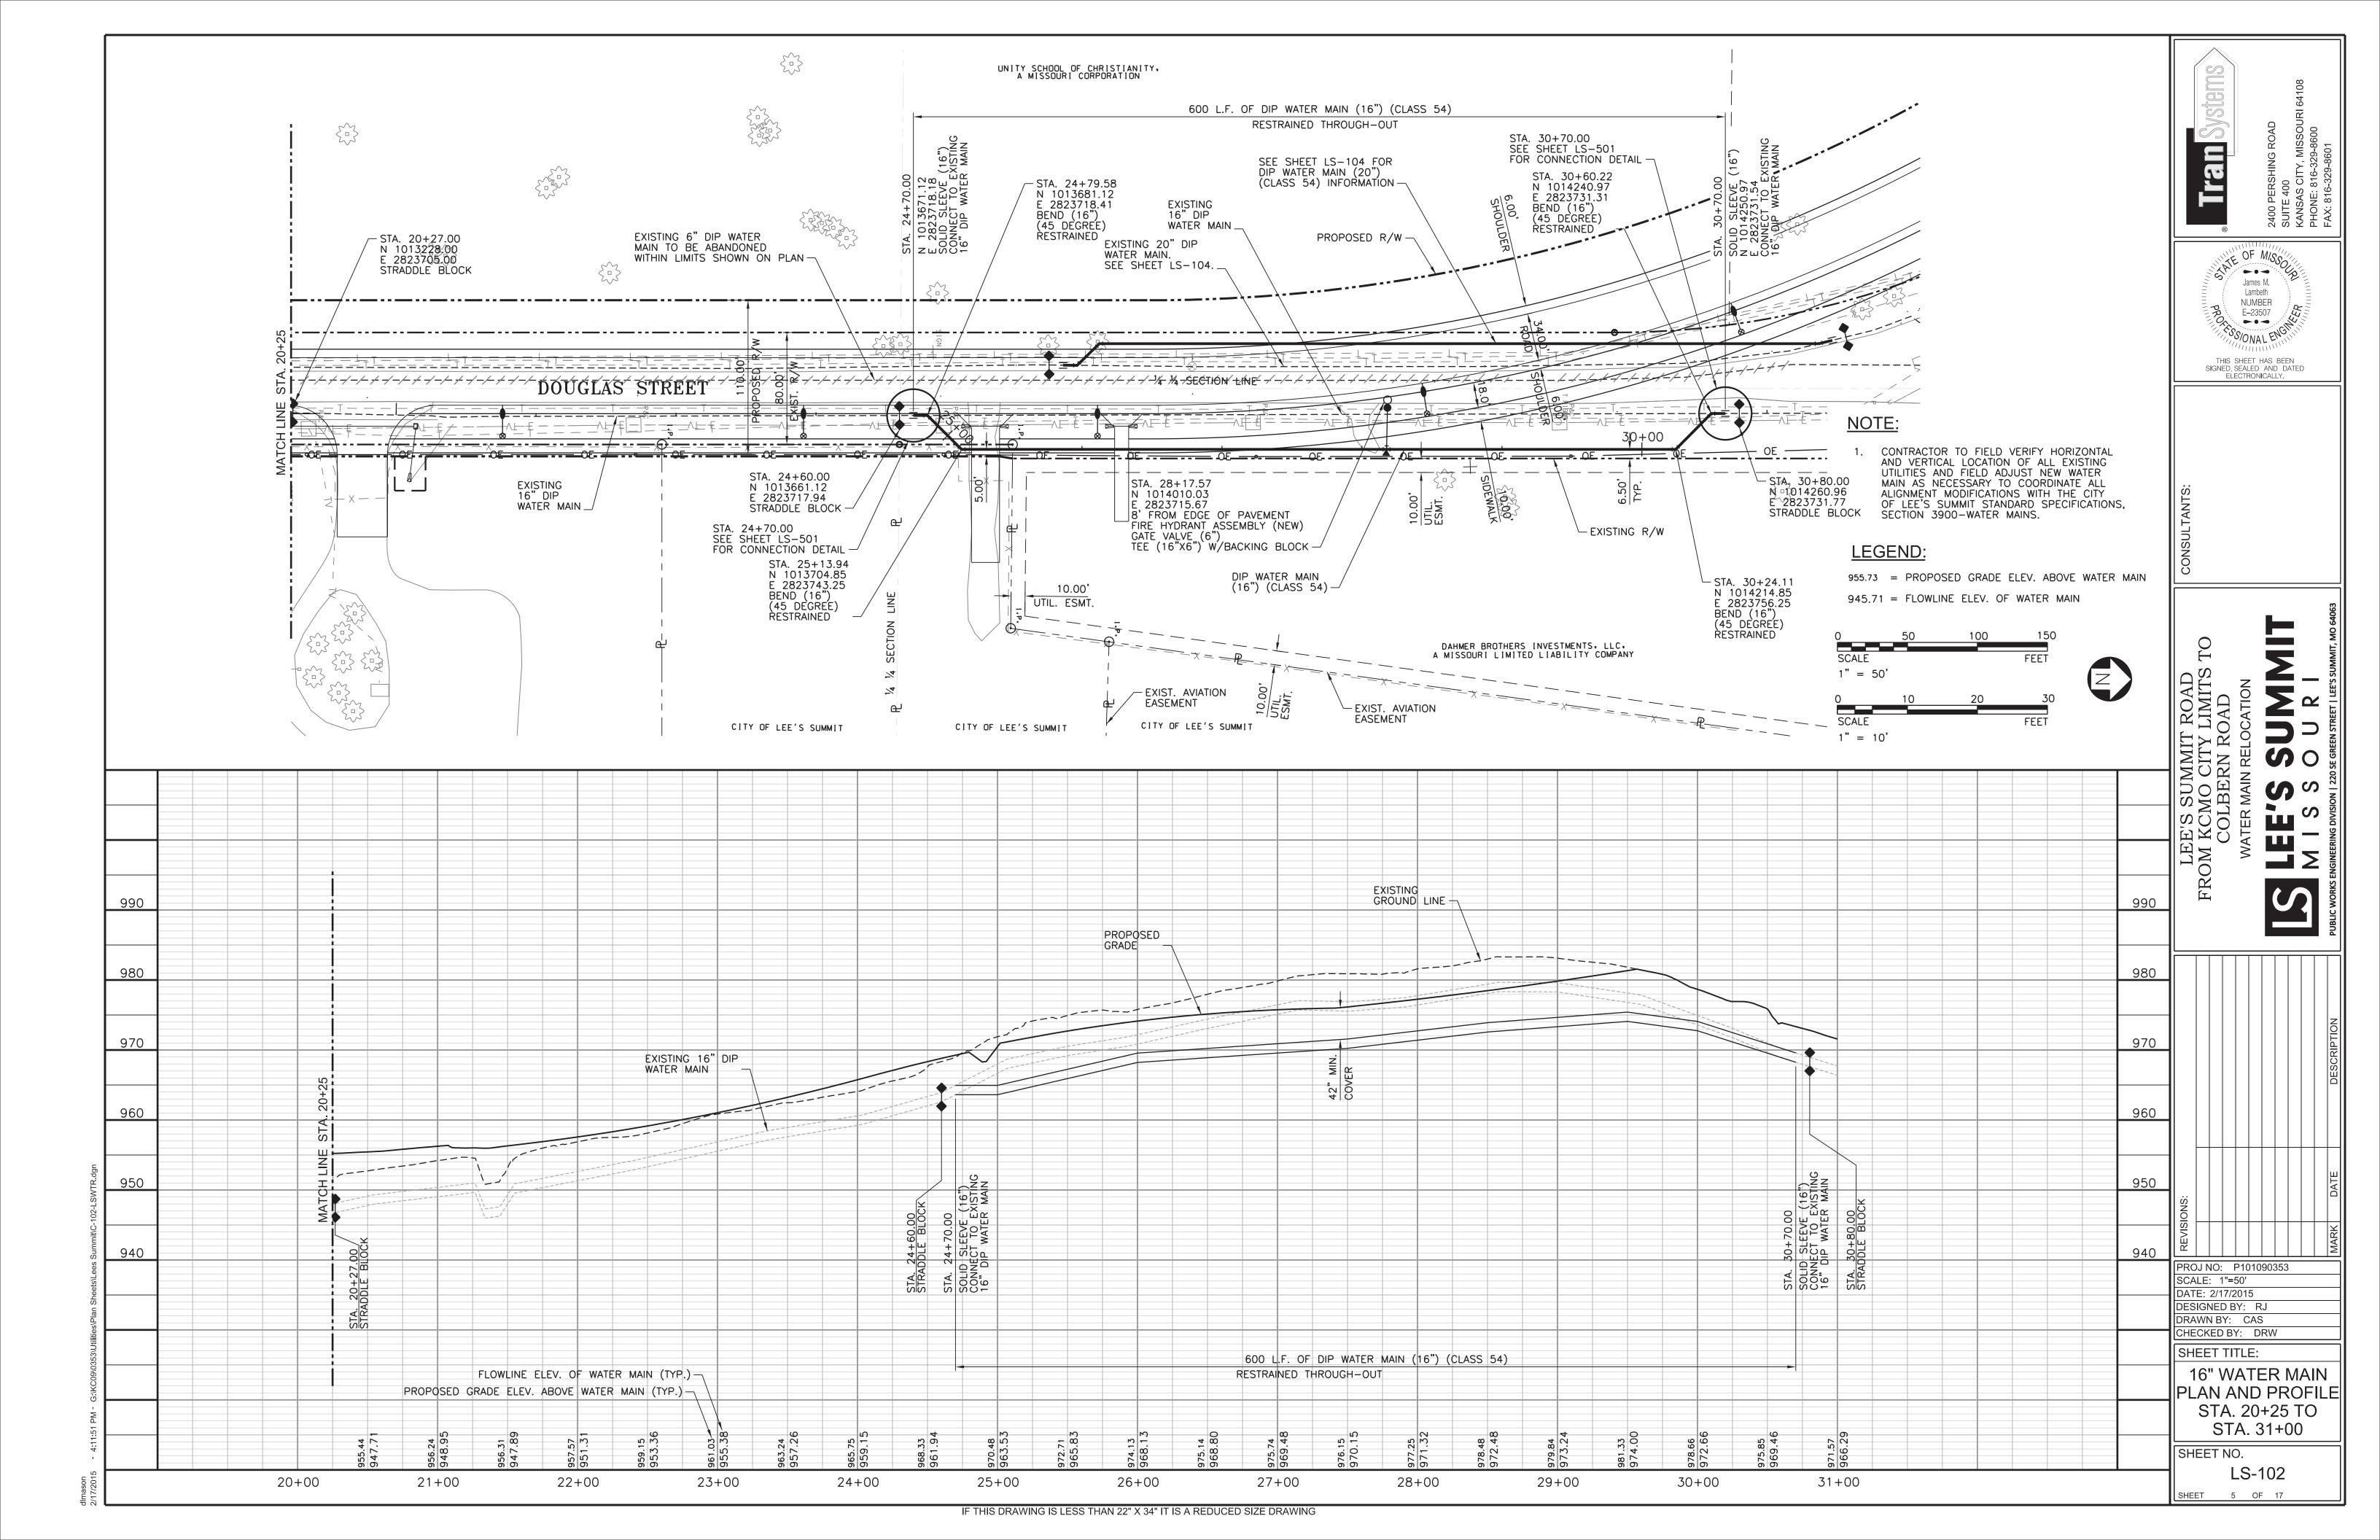


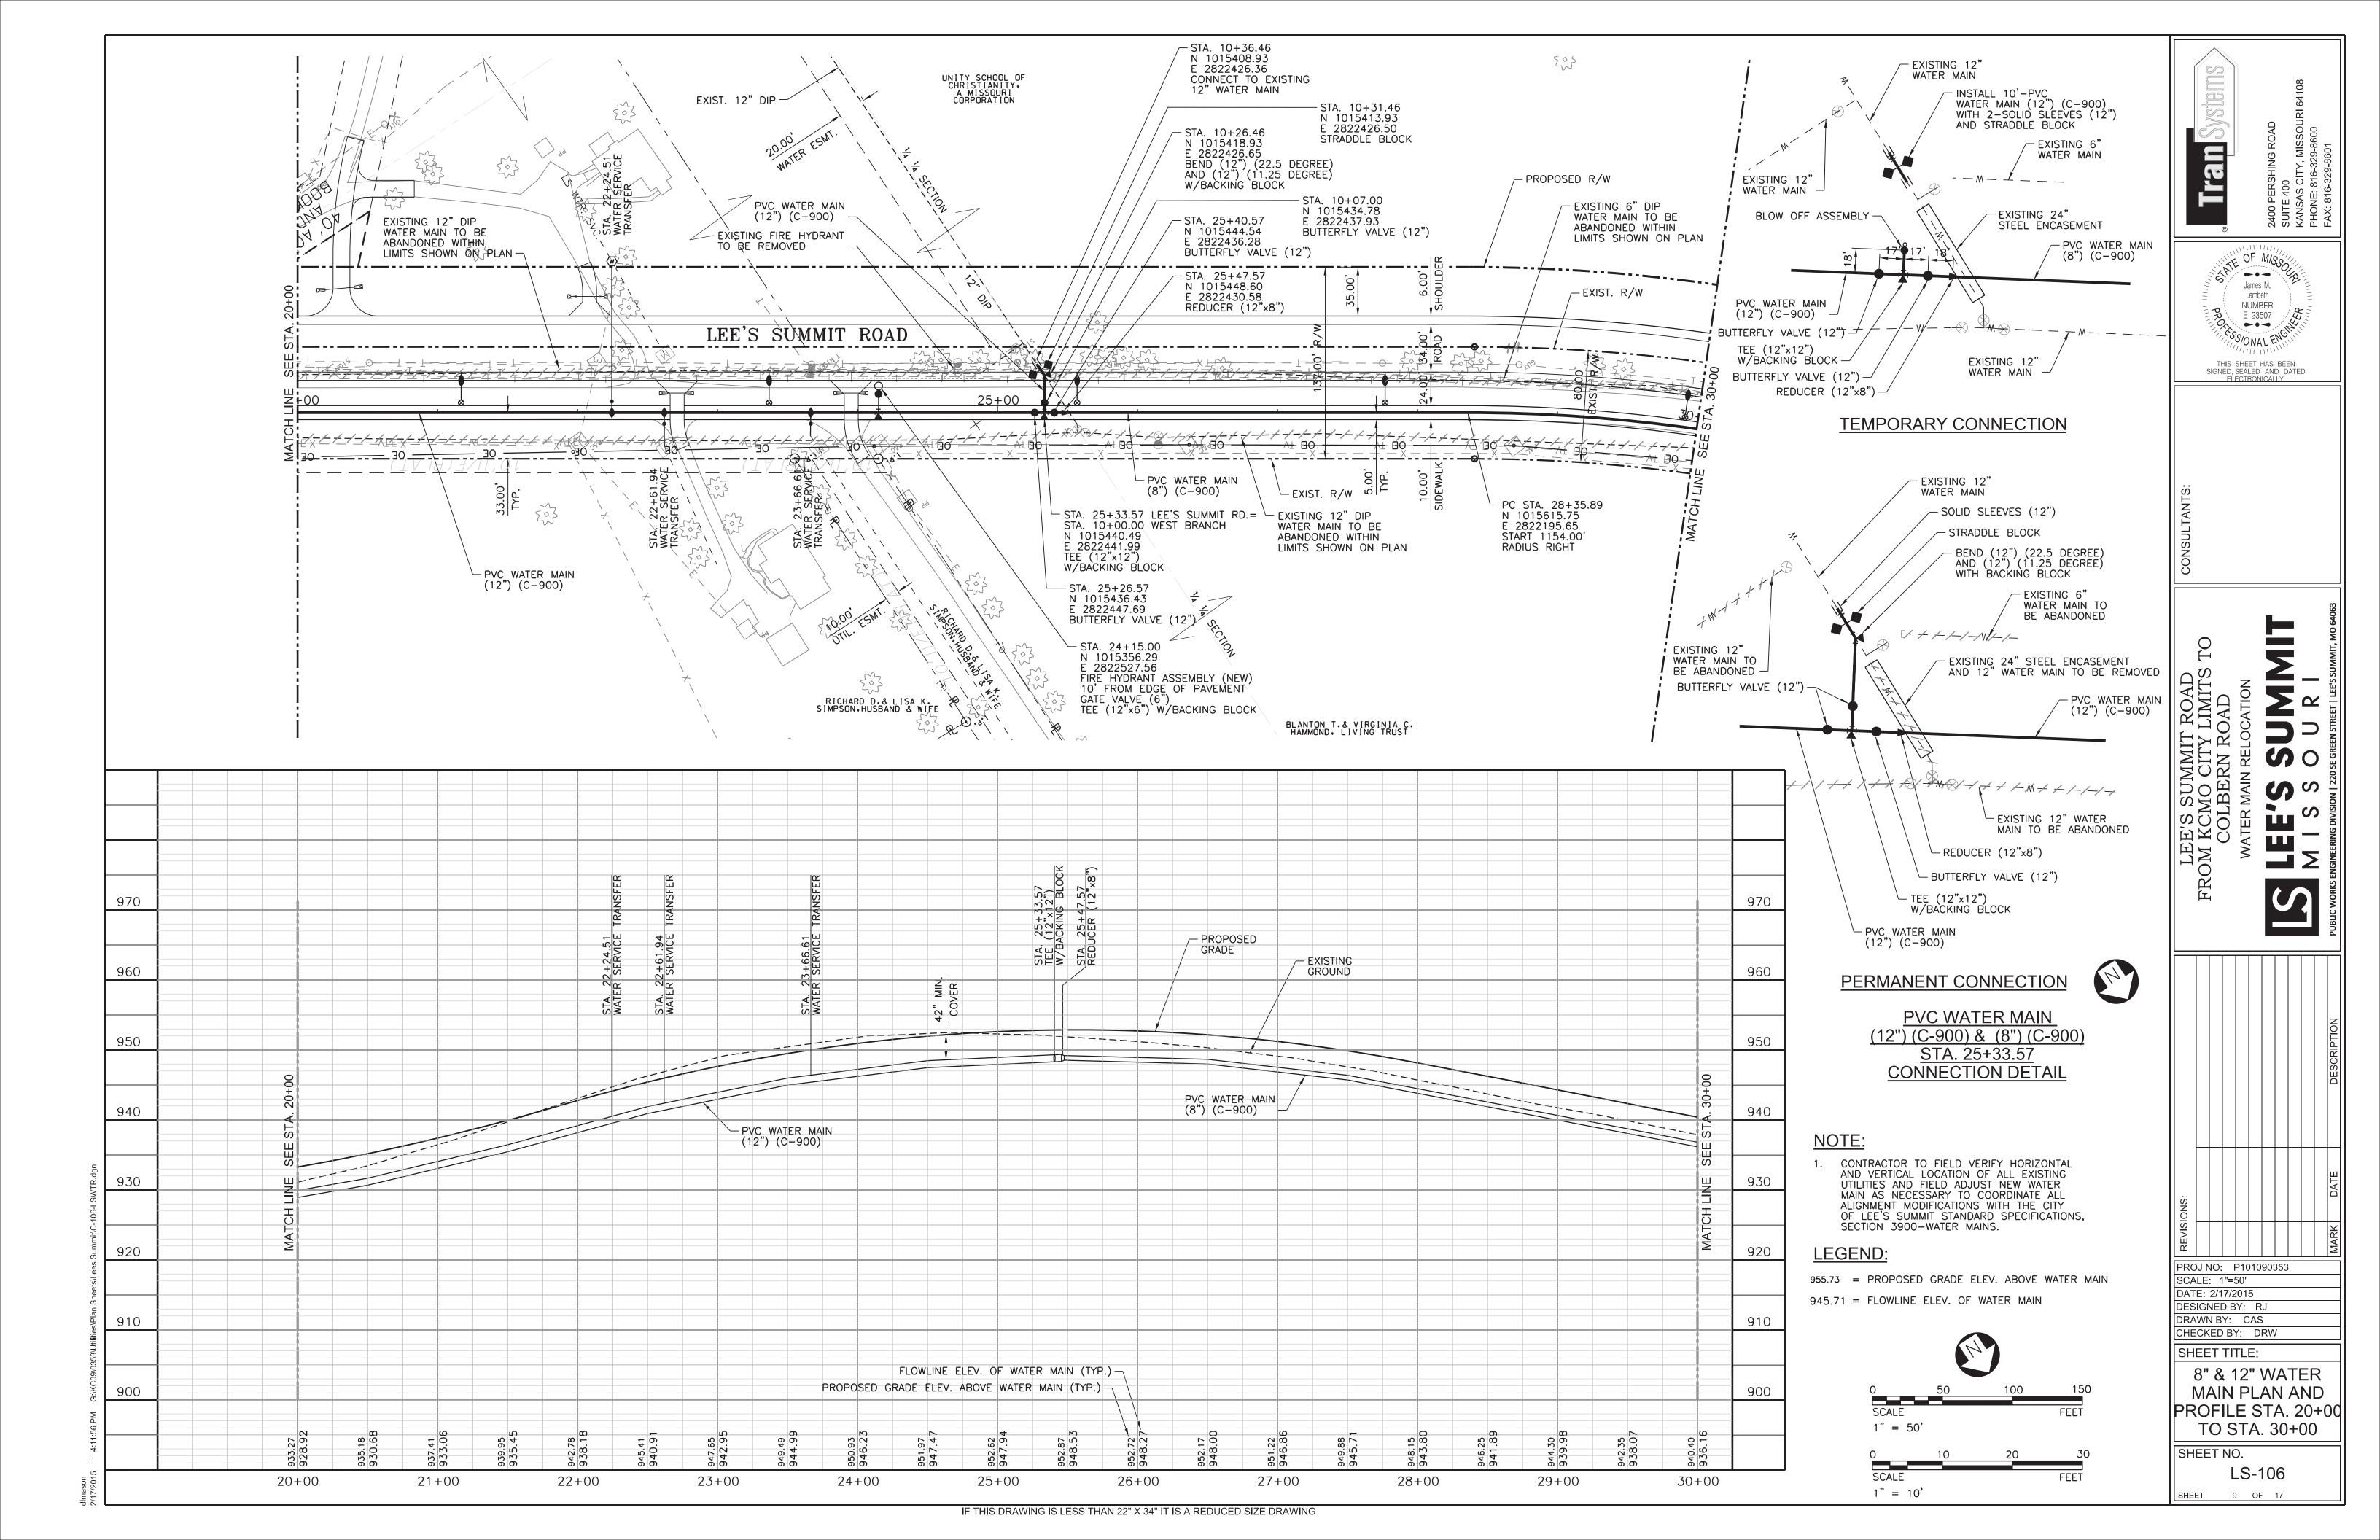


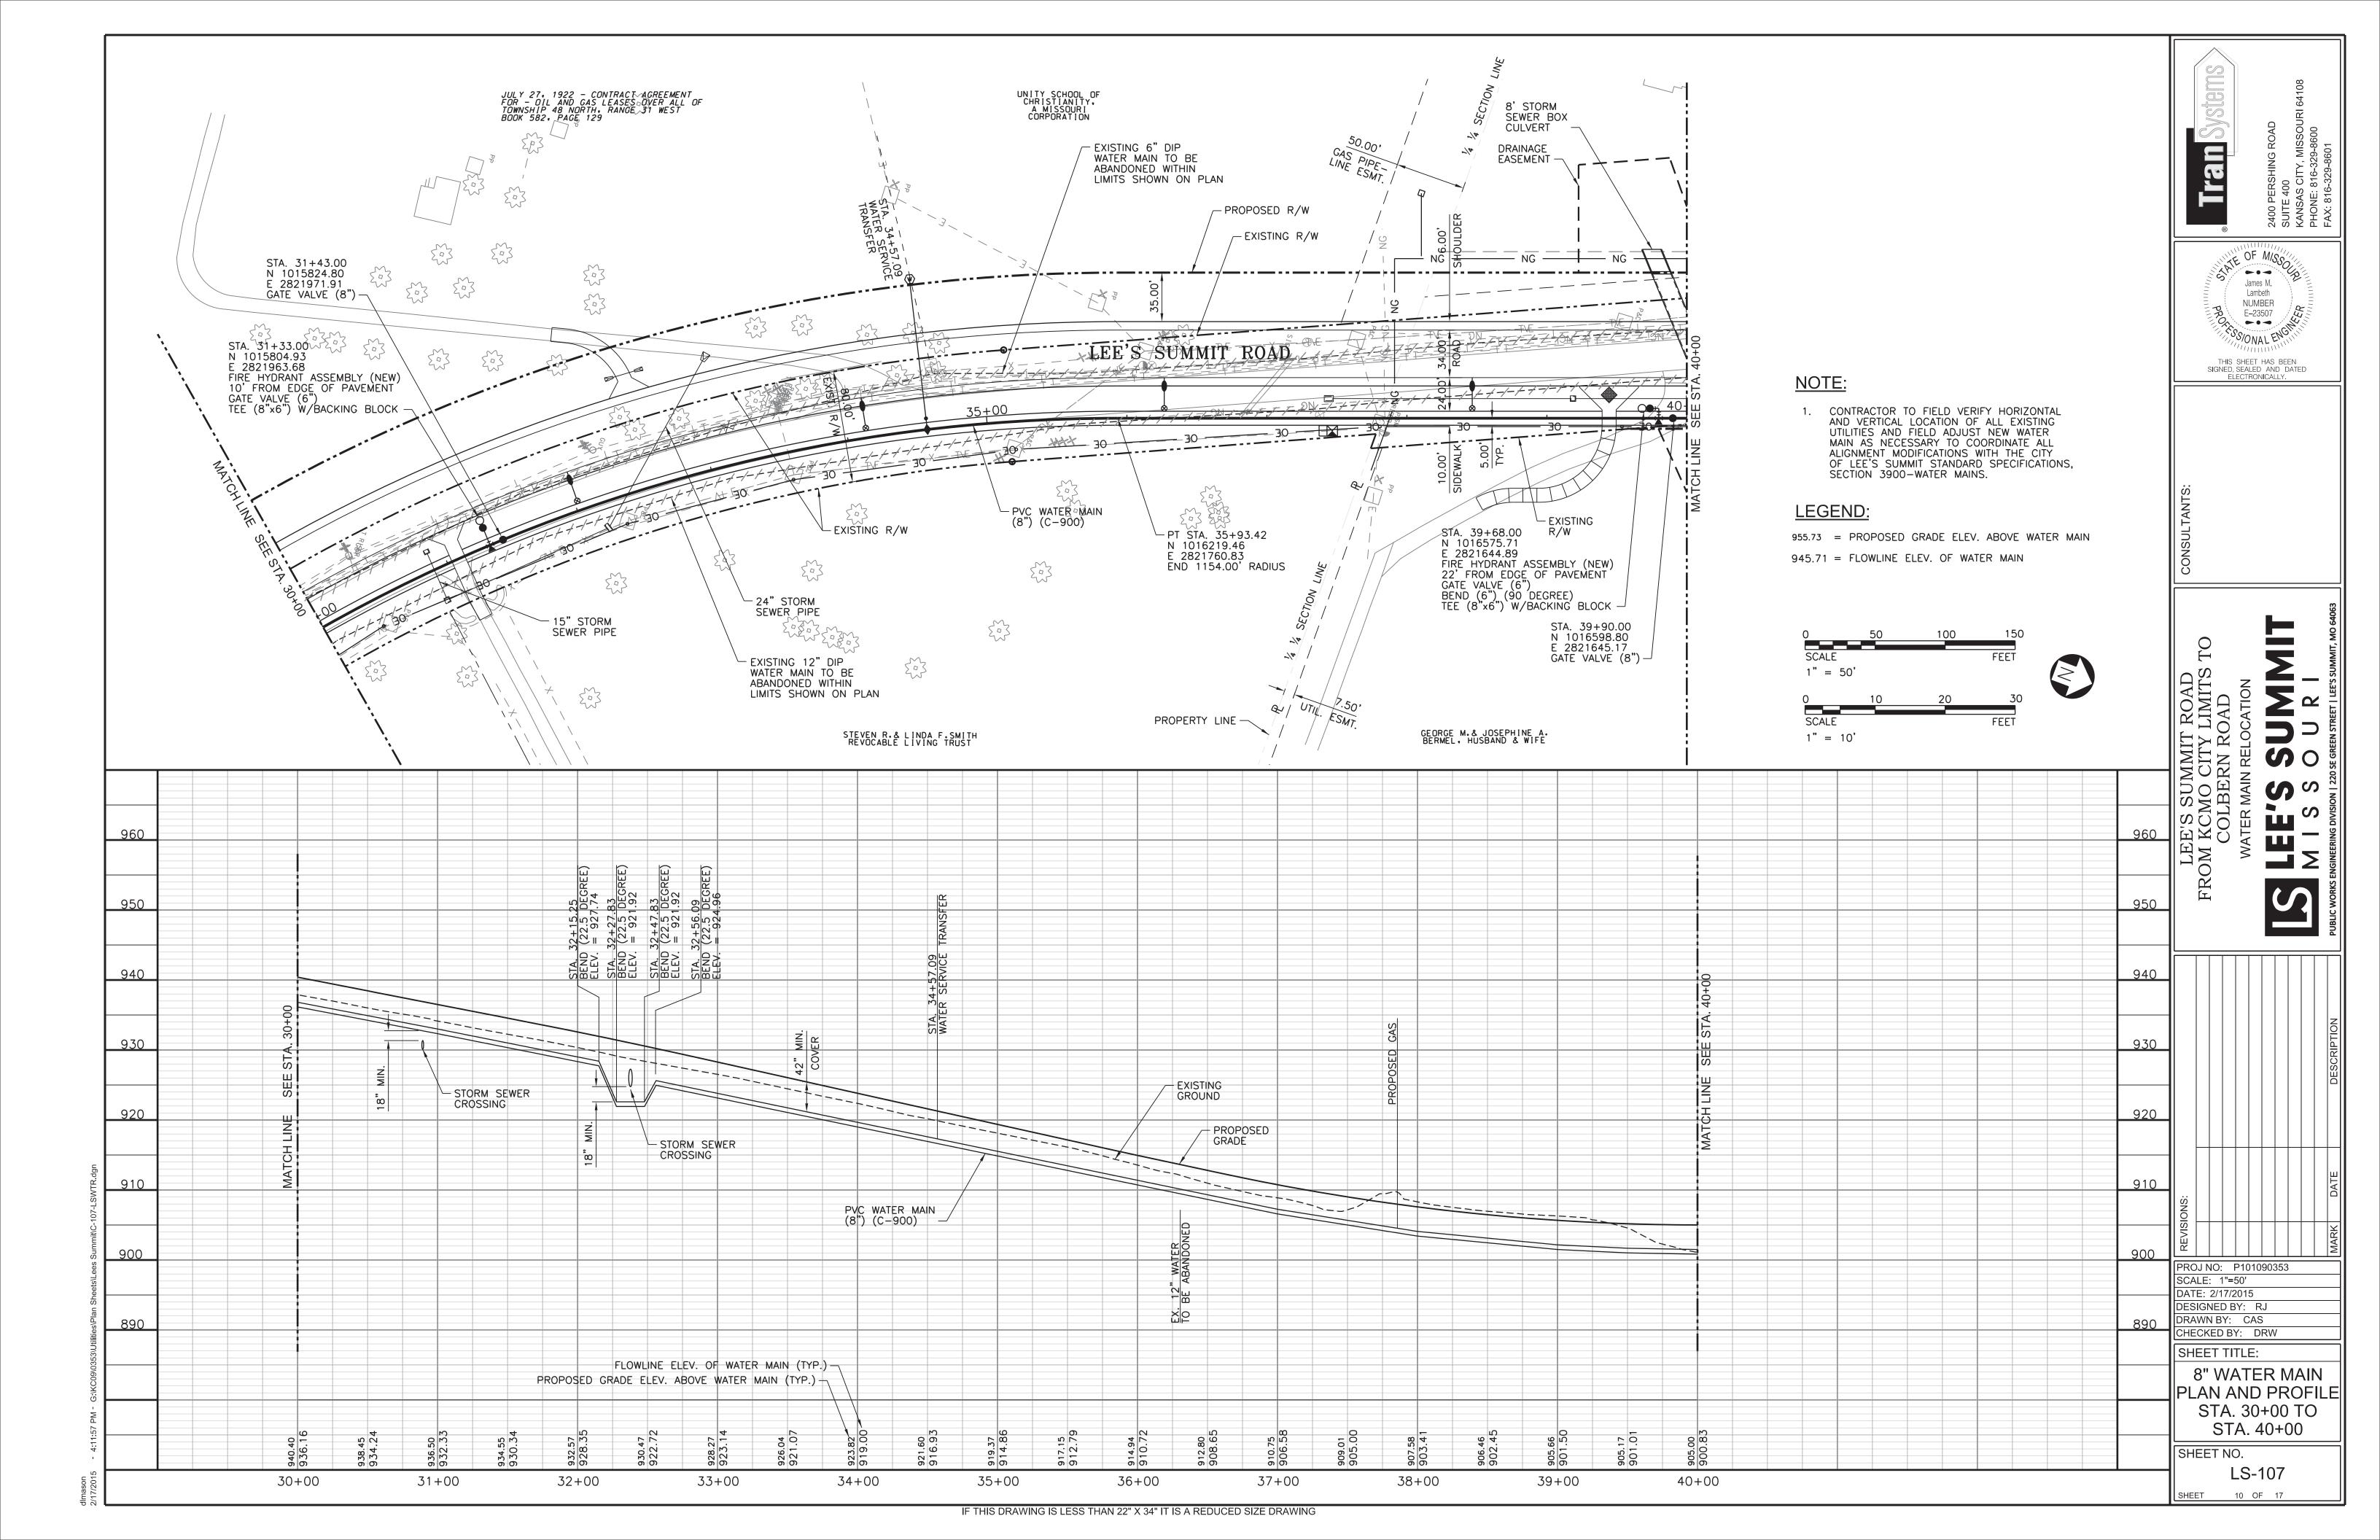

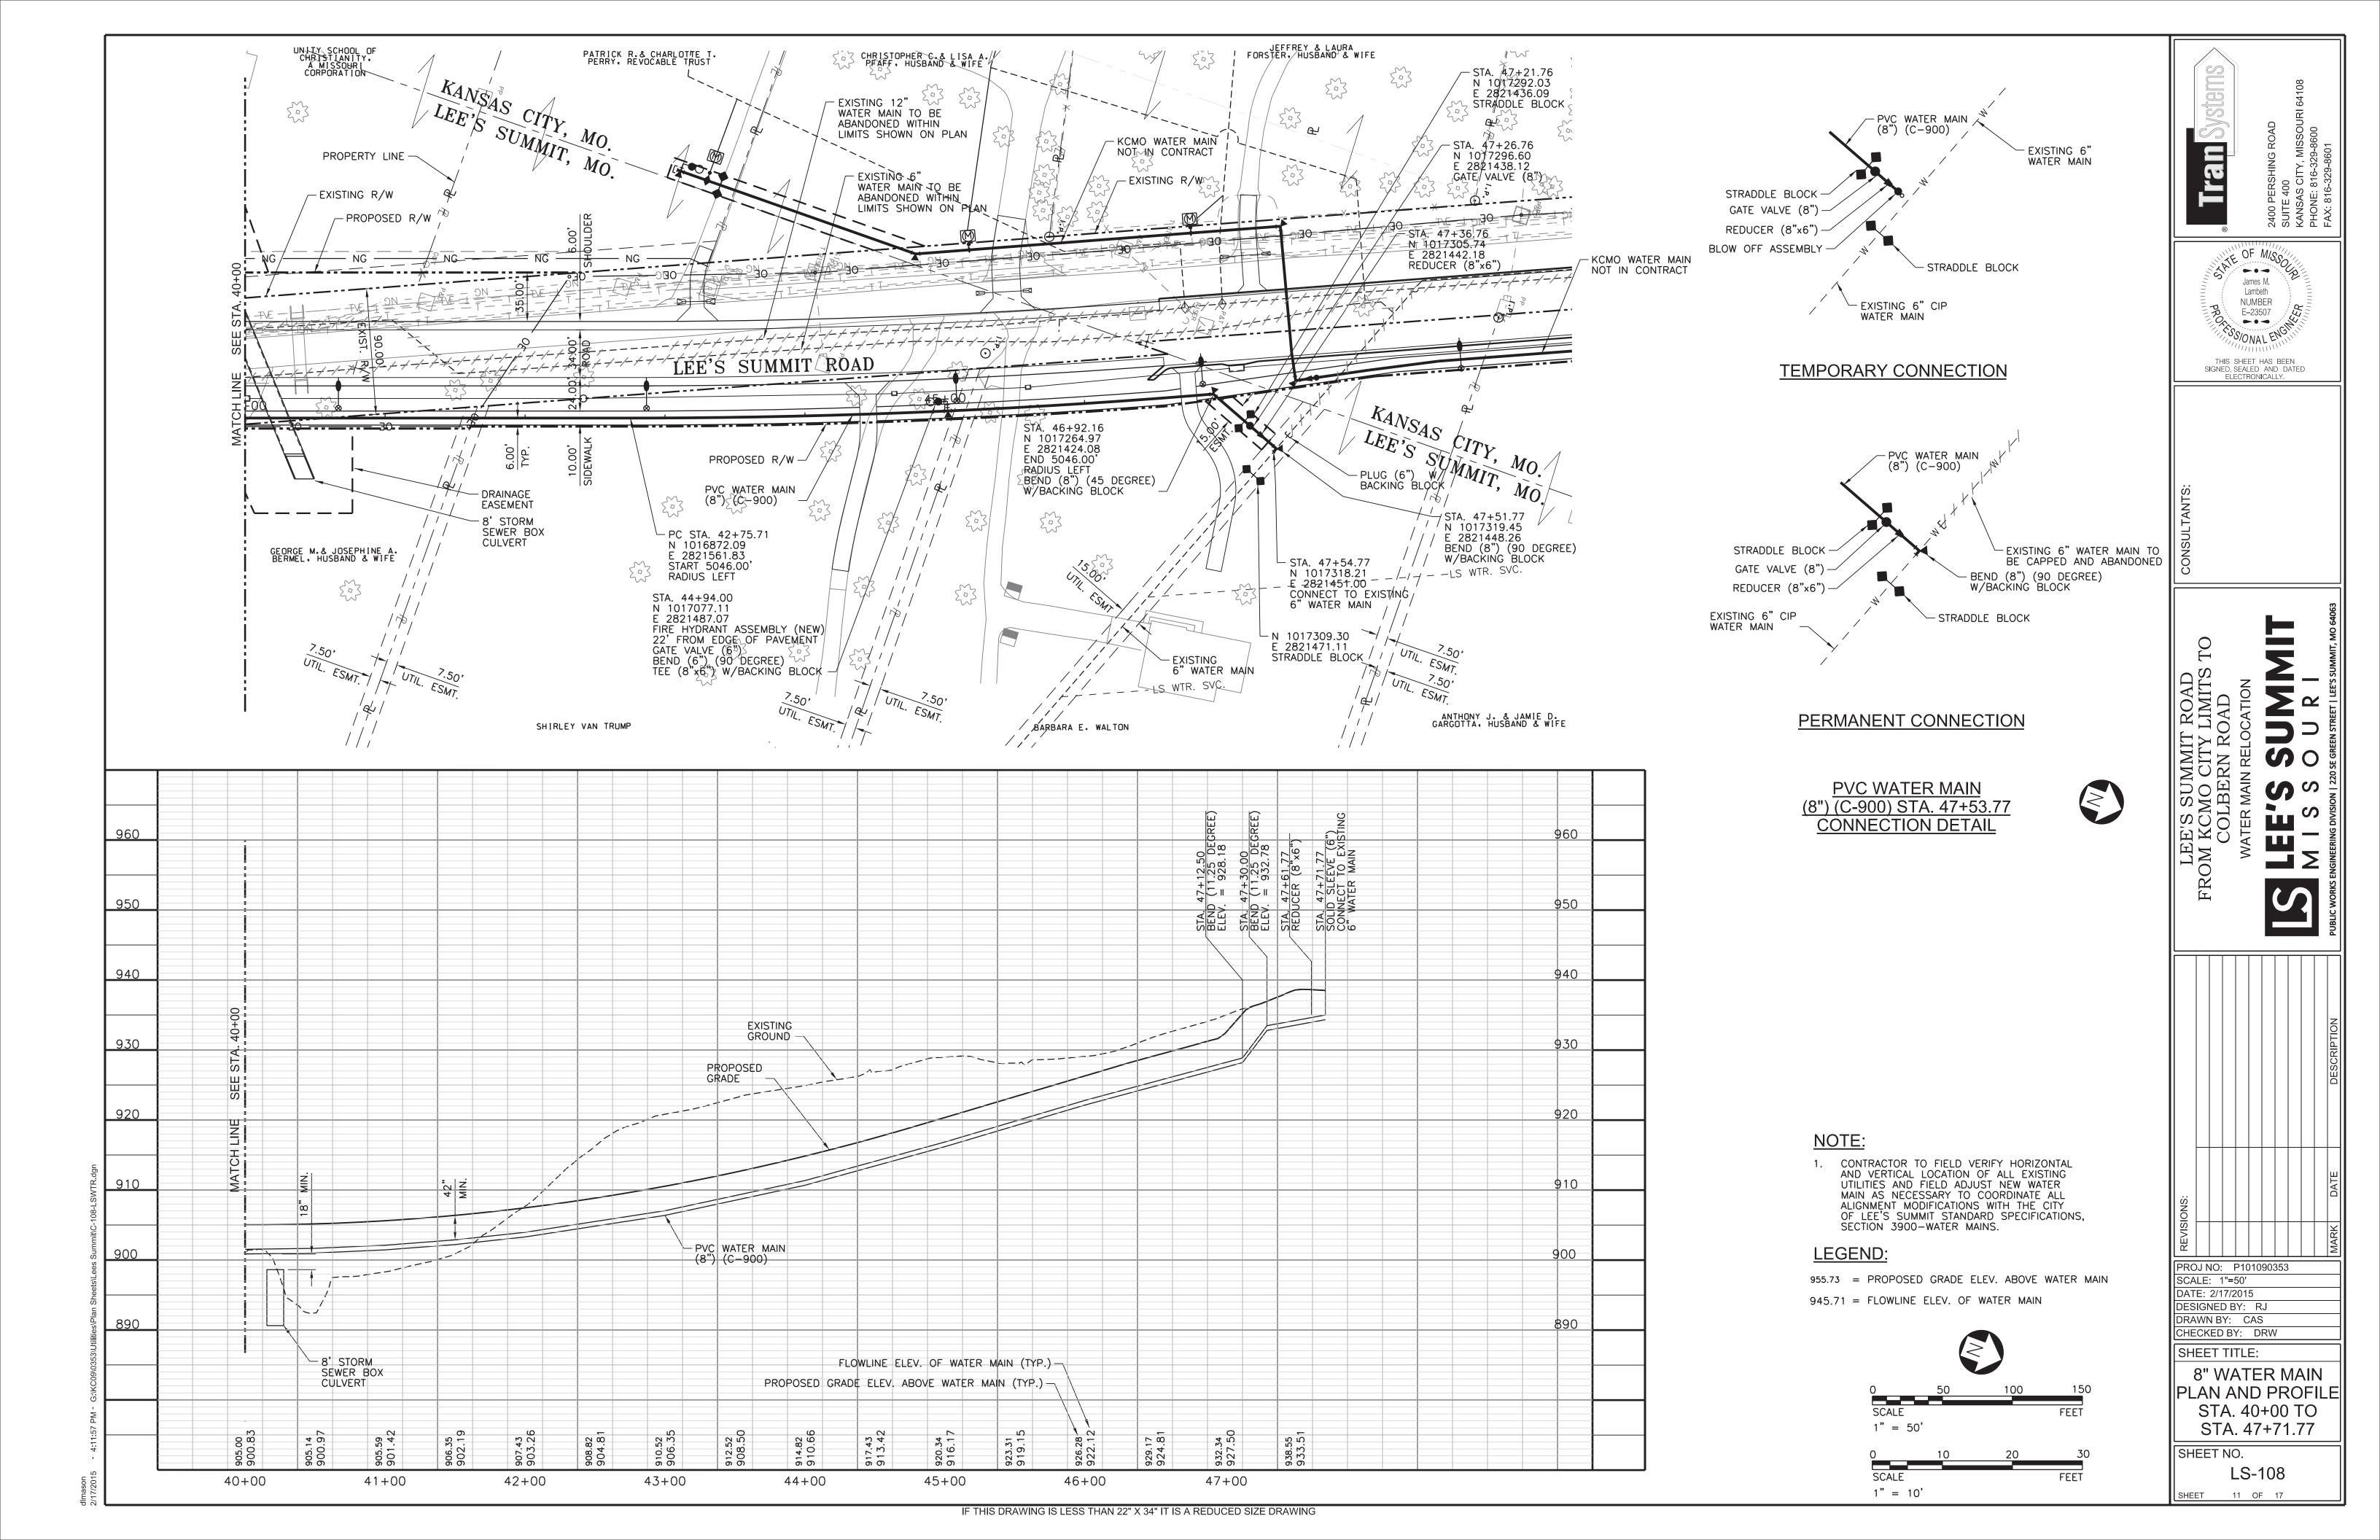

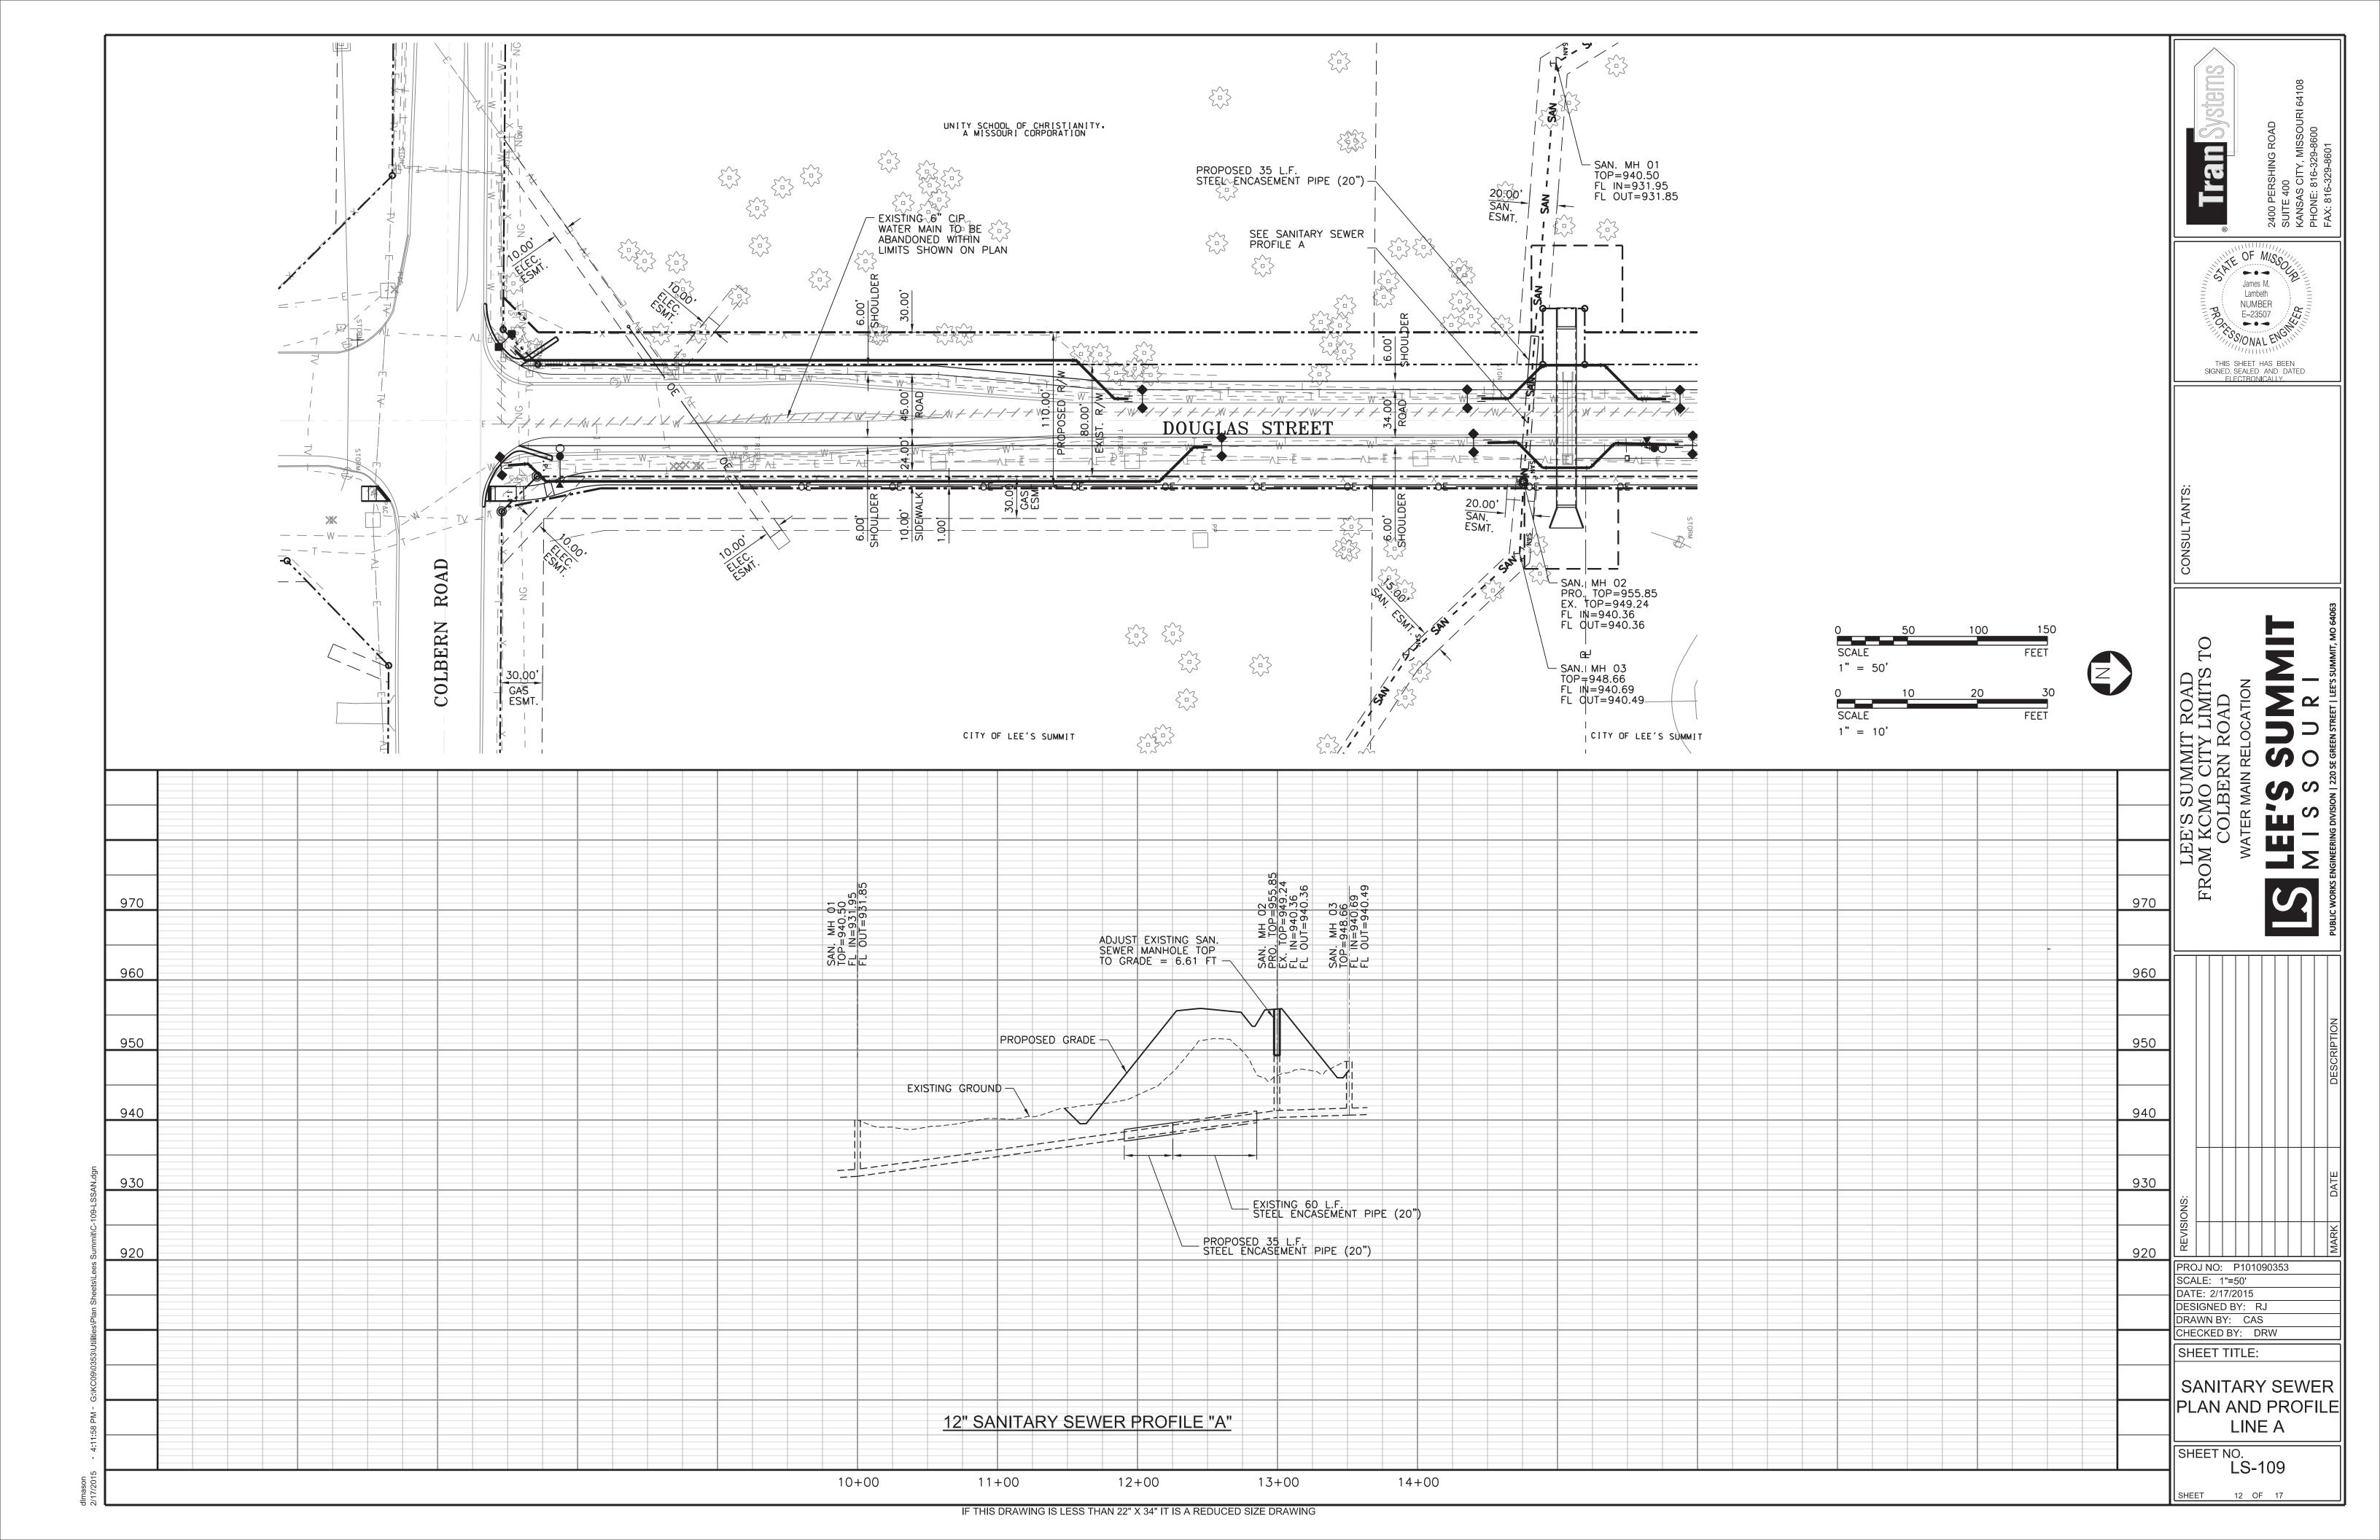

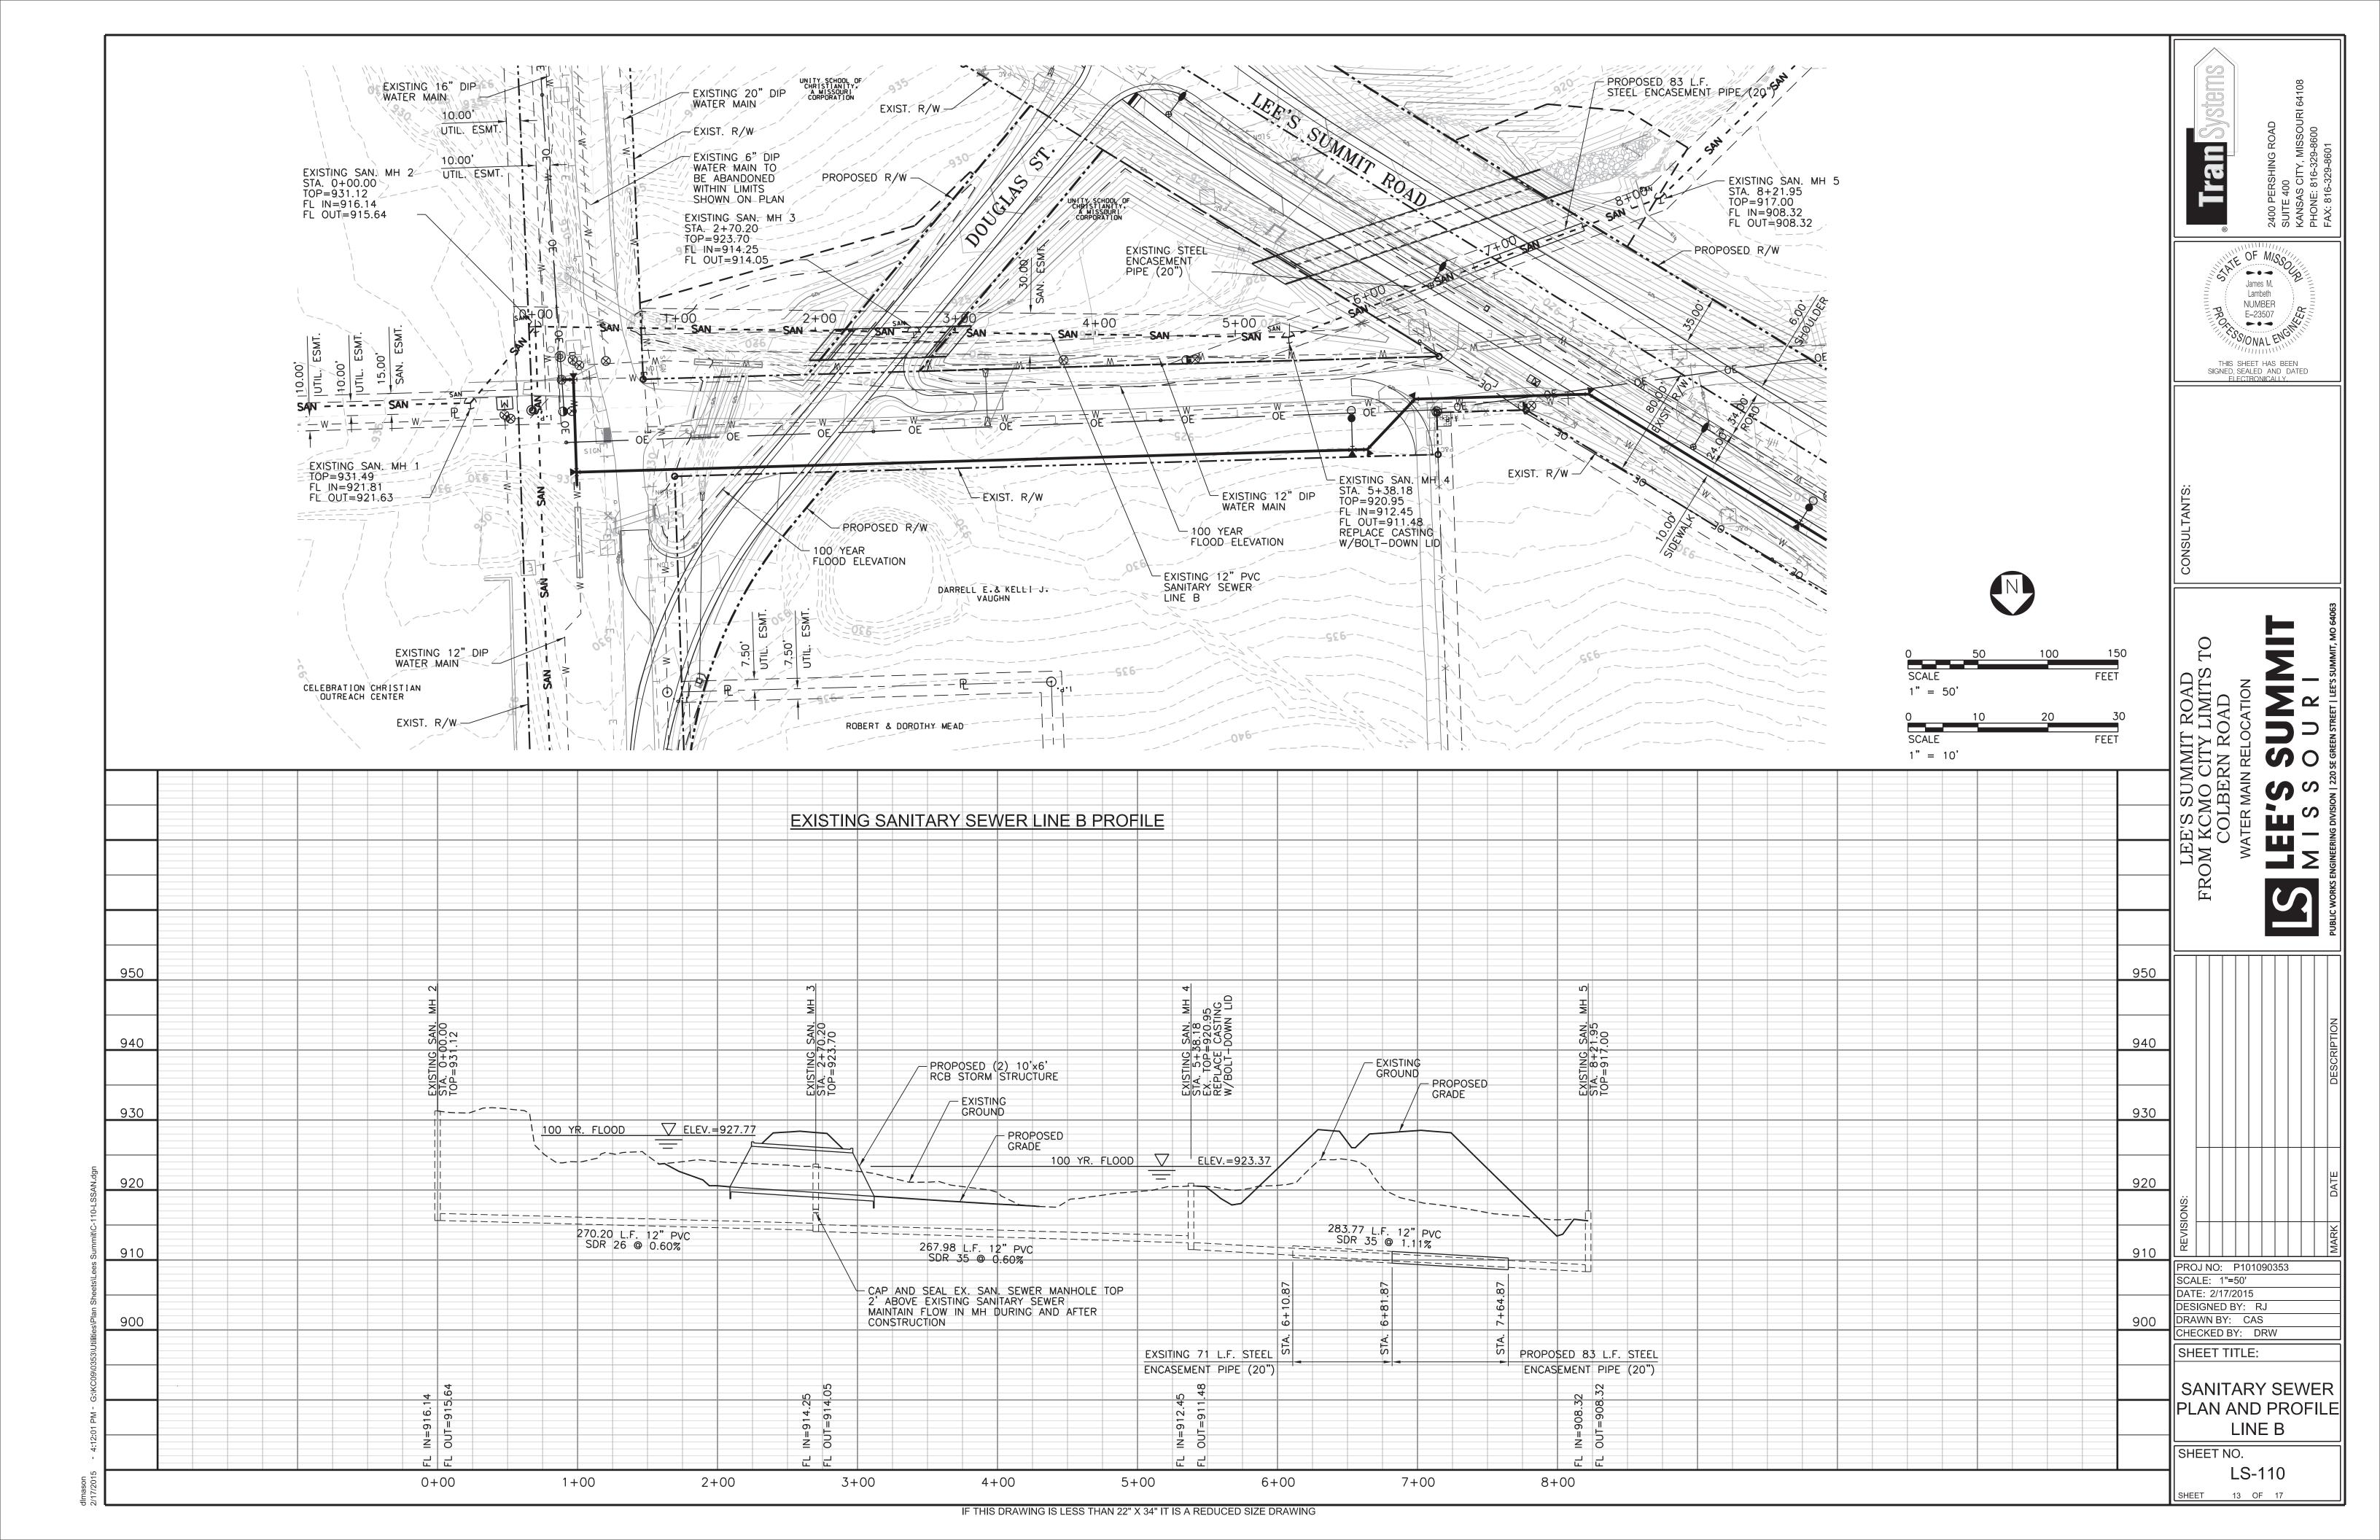

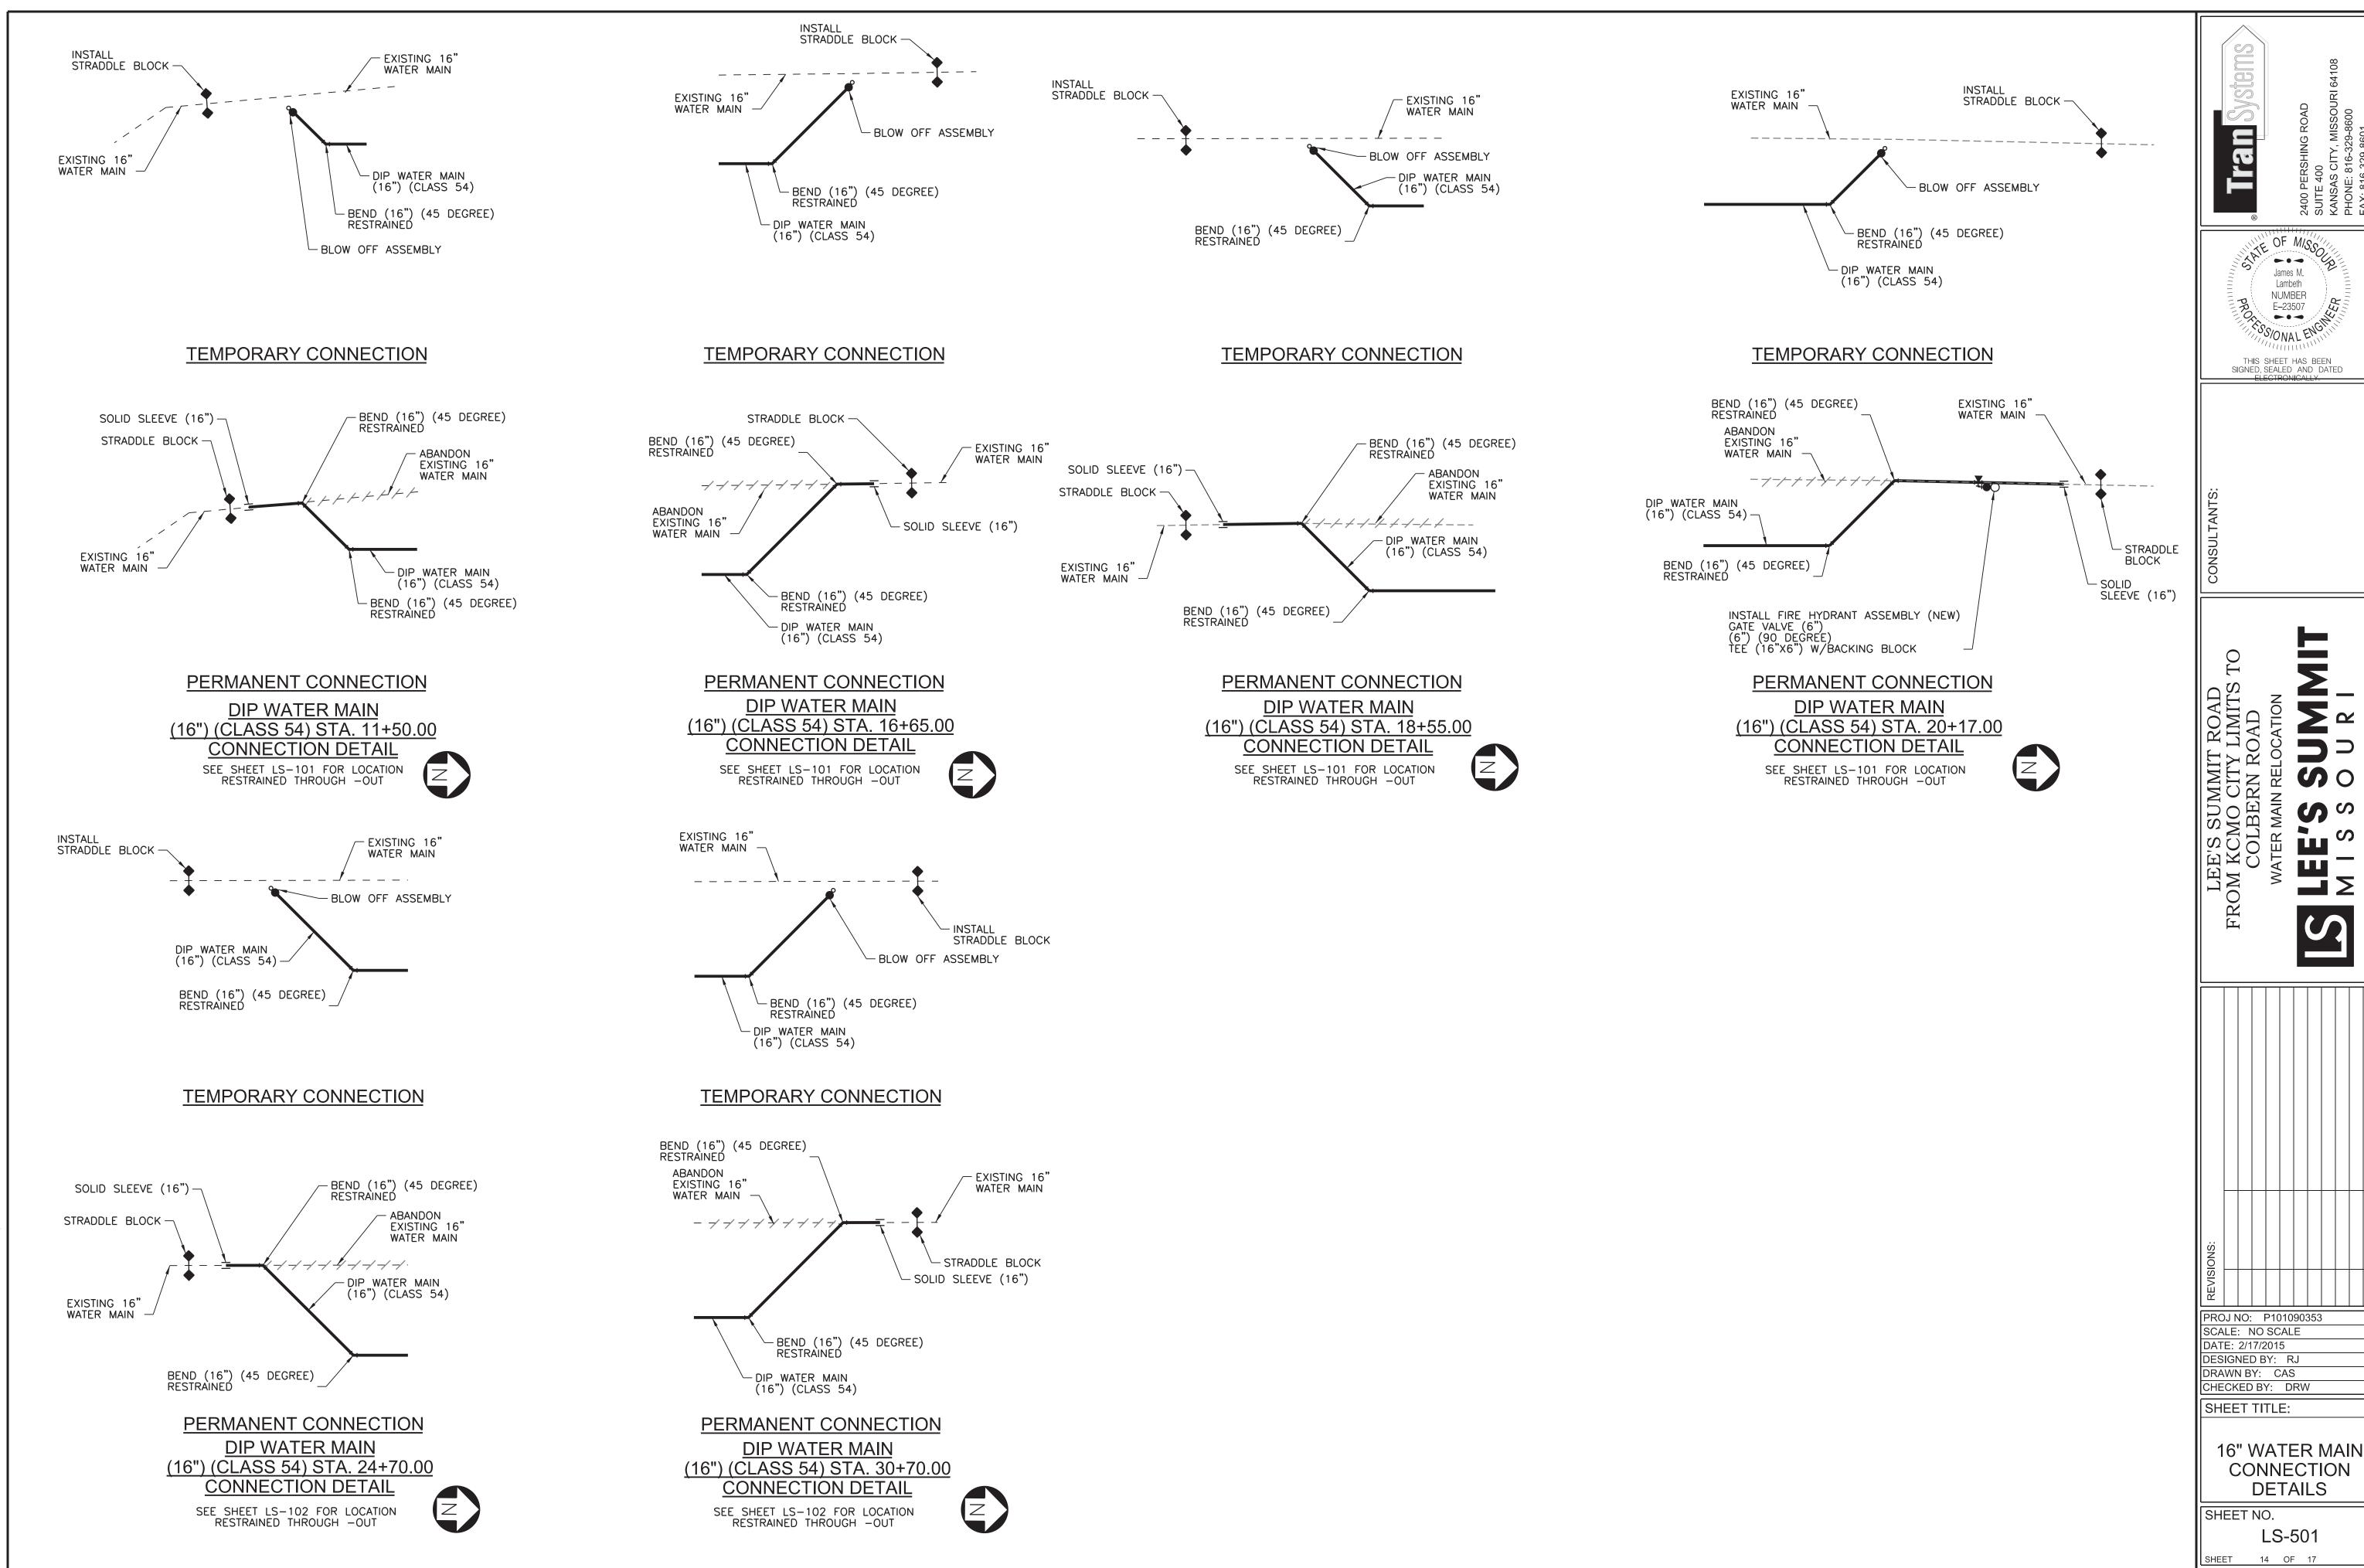

SATE OF MISSO

James M.

Lambeth NUMBER

THIS SHEET HAS BEEN SIGNED, SEALED AND DATED

**>** ~


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S


CONNECTION

**DETAILS** 

LS-501

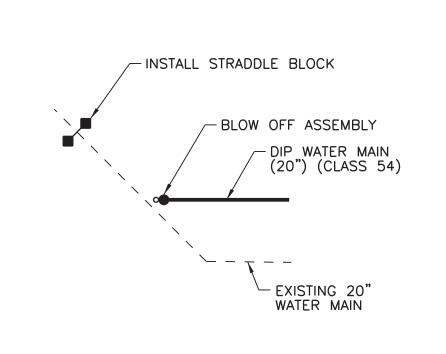


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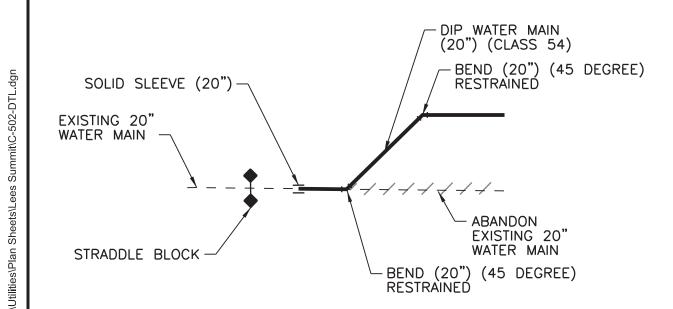

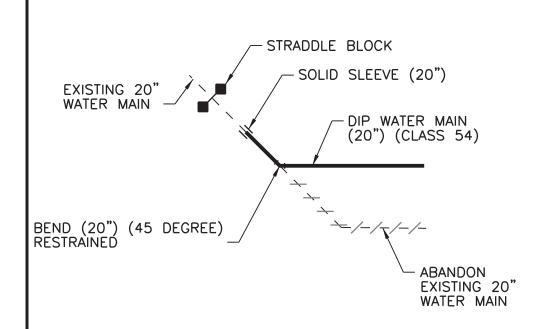
### PERMANENT CONNECTION

**DIP WATER MAIN** (20") (CLASS 54) STA. 10+25.00 **CONNECTION DETAIL** SEE SHEET LS-103 FOR LOCATION RESTRAINED THROUGH -OUT

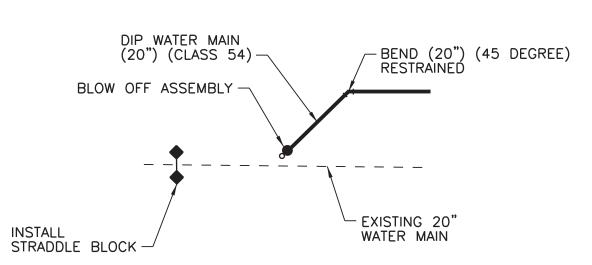


### **TEMPORARY CONNECTION**




### PERMANENT CONNECTION

**DIP WATER MAIN** (20") (CLASS 54) STA. 24+50.00 **CONNECTION DETAIL** SEE SHEET LS-104 FOR LOCATION RESTRAINED THROUGH -OUT



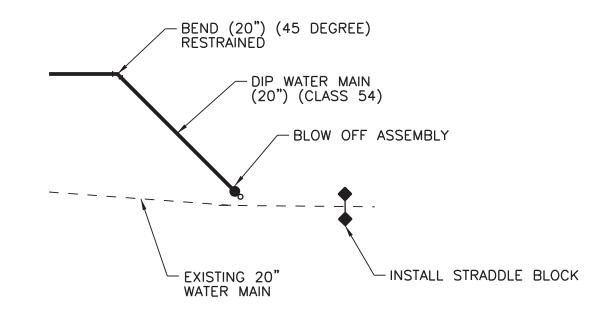


### TEMPORARY CONNECTION

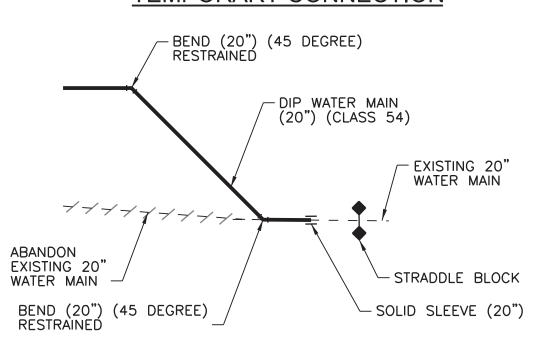


### PERMANENT CONNECTION

**DIP WATER MAIN** (20") (CLASS 54) STA. 14+77.00 **CONNECTION DETAIL** SEE SHEET LS-103 FOR LOCATION RESTRAINED THROUGH -OUT

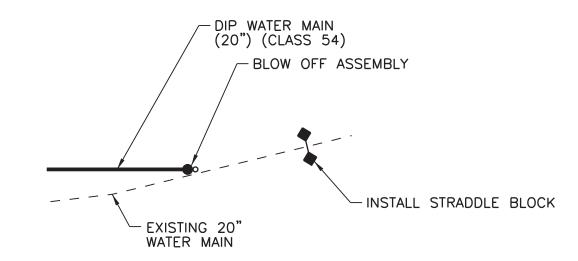


### **TEMPORARY CONNECTION**

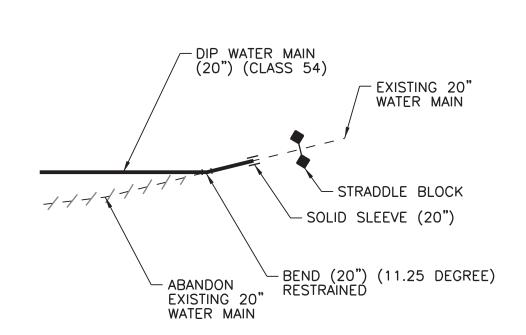


### PERMANENT CONNECTION

DIP WATER MAIN (20") (CLASS 54) STA. 30+06.00 **CONNECTION DETAIL** SEE SHEET LS-104 FOR LOCATION RESTRAINED THROUGH -OUT



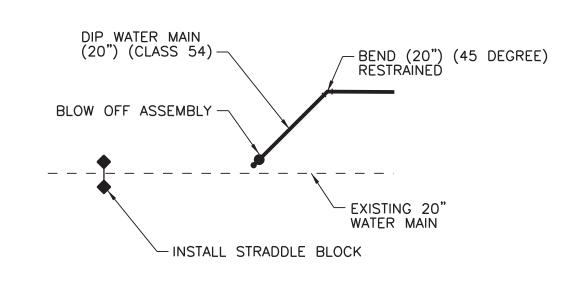


### TEMPORARY CONNECTION

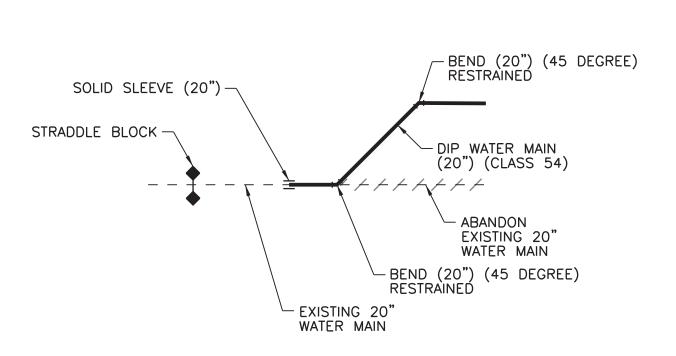


### PERMANENT CONNECTION

**DIP WATER MAIN** (20") (CLASS 54) STA. 17+29.00 **CONNECTION DETAIL** SEE SHEET LS-103 FOR LOCATION RESTRAINED THROUGH -OUT

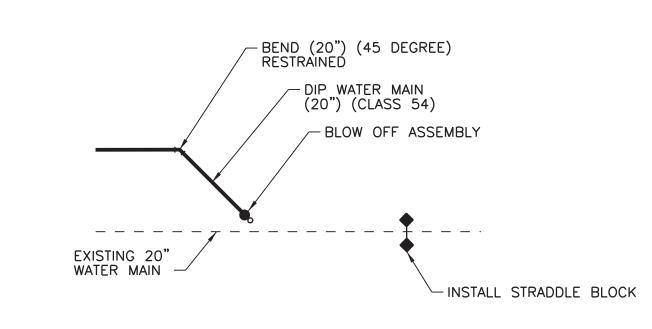


### **TEMPORARY CONNECTION**

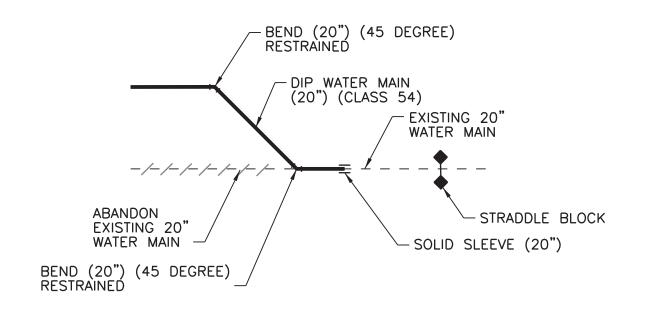

### PERMANENT CONNECTION

**DIP WATER MAIN** (20") (CLASS 54) STA. 18+81.00 **CONNECTION DETAIL** 

SEE SHEET LS-103 FOR LOCATION RESTRAINED THROUGH -OUT

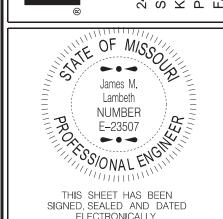

50 S

PROJ NO: P101090353 SCALE: NO SCALE DATE: 2/17/2015 DESIGNED BY: RJ DRAWN BY: CAS CHECKED BY: DRW

SHEET TITLE:

20" WATER MAIN CONNECTION **DETAILS** 

SHEET NO. LS-502 SHEET 15 OF 17

